


· (型) (型)

Council Records

These records were obtained in September 2022. NPDC is currently undergoing a review of the property search report content. As such the documentation provided by the NPDC may not be a complete full record. We suggest you get your own professional advice on the provided content and in fact any NPDC files for this property.


OWNER DB - AJ A	Roebuck	PERMITS 9/105/
ADDRESS		25/7/72
BUILDER		PLUMBING
BUILDER K. Bint		DRAINAGE
DRAINLAYER		value \$200
NATURE OF WORK Add	to Dwellin	y
PRAIN SATISFACTORY/	./ PLUMBING SA	ATISFACTORY/

DRAINAGE PLAN

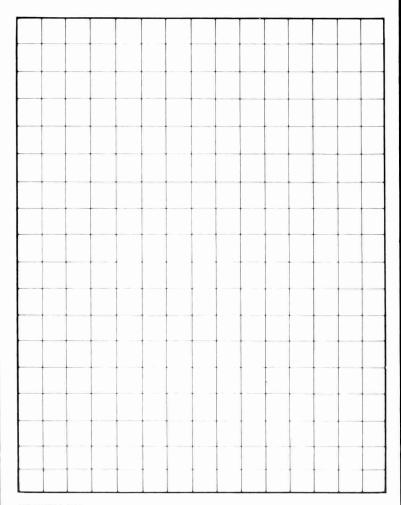

No. 26 Sec.	Lot 2 D.P. 10143
Address CEUADA	DRIGE
DRAINAGE AND PLUMI	
OWNER DARNES ADDRESS BUILDER PLUMBER DRAINLAYER ""	756/82 PERMITS 1821 PLUMBING 900.00 DRAINAGE 400.00 VALUE \$ 1300.00
NATURE OF WORK	LC115C
DRAIN TESTED 2/11/82 M.H. F FALL AND DESCRIPTION Proposition con	PLUMBING PASSED 18, 3, 83 plite H/5
STORMWATER CHECKED	Inspector.

DRAINAGE PLAN SCALE

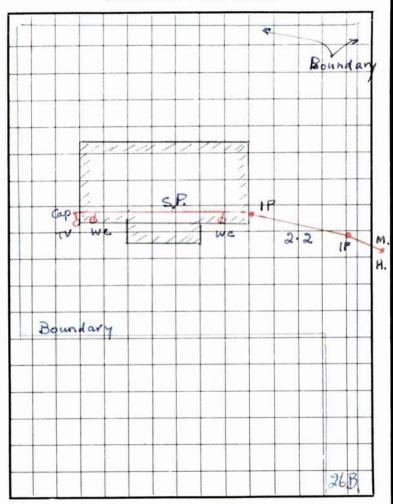

FRONTAGE NEVADA DRIVE

BUILDING CONSENT

35644A

PROPERTY ID

007925



New Plynou hAidrit EducaRISED WORKES 10Jan01 Page

Date Received: 10/01/01 35644 Application No: Area: NP DISTRICT Application No: Related: Name: BEAUMONT, Gordon Henry Address: 26C NEVADA DRIVE Lot: 1 NEW PLYMOUTH 4601 DP: 15452 Property ID:039635 Assessment: Date Action Returned Estab Action CLERICAL Accept & Plot Check for Compliance with Dist. P PLANNING BUILDING ab. 11-1-01 Building Act Compliance Building Act Health Compliance HEALTH ENGINEER Structural Check SEWER/WATER Off Site Services CLERICAL Final Approval 10 E=N=D==O=F==R=E=P=O=R=T===E=P=O=R=T=E=N=D==O=F==R=E=P=D=R=T=====

Drainage Plans Enclosed Yes/No
Plans Taken Yes/No
Yaka Keconmend walls for conservatory of Sell 31.1-0[

RECEIVED 1 0 JAN 2001

Works

Approved

Not Approved

196 11:01

Applicant

Phoned

More Info

Required

Application

Correct



UNAUTHORISED WORKS
Please provide the following information.
Full construction details of the deck are required.
(The floor plan and elevations differ for pile kyout
and bearers.) please show clearly the bearer size
and span between piles, the joist size, spacing between
joists and the length of cantilever of the joists.
Please show the method of fixing the beavers to the
posts and the size and fixing method of the braces.
The barrier design is to be detailed including the
method of fixing the baluster posts. Please provide
a detail of how the conservatory is weather
proofed to the deck. (15 deck raised under conservatory)
A hand rail to the steps is required.

Numbing & Prinage/Beilin / Environmenta Health/Hazardous Substances
of site visit was carried out on the 31. January 2001
of the conservotory it is a standard conservatory with
the lower the glazing in a golden spancy glass, the
orginal decking affects it may have been removed and
a Hardi wheel moterial screwed fixed to the joist.
The reaservatory is well sealed and no dyns of
water leads to the interior. It is recommend the
unaathorised work regis traken be usued for the
conservatory of Solf 31-1-01

UNAUTHORISE	agineering RKS
	(100 to 100 to 1
	19 19 19 19 19 19 19 19 19 19 19 19 19 1
<u>. </u>	7
	^
	A A A A A A A A A A A A A A A A A A A
	7
	* ************************************
3	
PIM Info	rmation to be sent
Grease Trap Building Business	BIA Guides
Septic Tank WOF Poster	1. How it works
Septic Tank LI Compliance Schedu	Table 1
Sewer Pump BRANZ Advisers	3. Getting approval
Swimming Pool Building Magazine	
Noise Control Electrical Safety	5. Compliance schedules
Demolition Playground Checkl	
Rural Fire Minimum Standard	
Application	7. The Building Industry Authority Levy
Other	
	A

S36 BA

Sign/Date

Landscaping

Trees/Heritage

New Ply	ymouth District Council COVER SHEET		ed:10Jan01	Page 1	
Rela	Application No: 35644 ated: Application No:	Date Received Area	: 10/01/01 : NP DISTRIC	T	
	Name: BEAUMONT, Gordon Henry ress: 26C NEVADA DRIVE NEW PLYMOUTH 4601	Prop	Lot: 1 DP: 154 erty ID:0396		n 8
		X200.00.	te		
Action No	Action		turned		
 1	Accept & Plot	CLERICAL			
3	Check for Compliance with Dist. P	PLANNING	1 1	11 .	
4	Building Act Compliance	BUILDING	Urac Wc	thori	SEO
6	Building Act Health Compliance	HEALTH	(1)0	urks.	
7	Structural Check	ENGINEER	•00		÷ i
9	Off Site Services	SEWER/WATER			
10	Final Approval	CLERICAL			
E=N=D==	=O=F==R=E=P=O=R=T====E=N=D==O=F==R=E	E=P=O=R=T=E=N=D==	:O=F==R=E=P=O	=R=T====	
No	t Approved Planning*		Actio	ns	Date/Initial
	Reason(s)	· ·			
Î	Bulk/Location	Parking/Load			
	Resource Consent	Landscaping			
Sig	n/Date Trees/Heritage	Hazard			
Oth	ner	1			<u> </u>
	* S35(1A) to Building A	ct to apply if Buildi	ing Consent Is	sued	
Ap	proved Planning		Actions		Date/Initial
-	Building Consent Condi	tions Required			

S37 BA

RC Condition

UNAUTHORISED Information Memorandum

Only include information relevant to this project - Complete prior to processing

PIM Details	Info Enclosed - Data Inputted (Initial)
E E	
•	
	* * * * * * * * * * * * * * * * * * * *
	· · · · · · · · · · · · · · · · · · ·
	-
	N 20 N
Schedule of Attachments	
1	es .
2	
3	V
4	1
5	

Comments/Letters

Put "quotation marks" at start/finish of letter to be typed - Precede letters to be sent ASAP with "Urgent"

Text	Initial
	2
	3
*	
	E s
	<u> </u>
	9
<u> </u>	
	7 0
· · · · · · · · · · · · · · · · · · ·	

Parcel

35644



FOR OFFICE USE

NEW PLYMOUTH DISTRICT COUNCIL

PLANNING & ENVIRONMENTAL SERVICES DEPARTMENT
PRIVATE BAG 2025, NEW PLYMOUTH 4260: PHONE (06) 759 6060 FAX (06) 759 6118

APPLICATION FOR REGISTRATION OF UNAUTHORISED WORKS

039535

	Scale OFMI 5148	
DETAILS OF PROPE	RTY TO WHICH THIS APPLICATION APPLIES:	
SITE ADDRESS:	Street No. Street Street No. Street	
	Town/District	
Lot:	1 DP: \(\lambda \lamb	
or Section No.	District:	
OWNER'S NAME	Surname or company name 61773	
OWNER'S POSTAL A	ADDRESS - if different from 'SITE ADDRESS' Street No. Street/PO /Private Bag	
	Town/District	6
	1 - 1 - 1 - 1 - 1 - 1 - 1 - 1 - 1 - 1 -	(C
Tick this box if the ap	t the owner, please give applicant details: 1 0 JAN 2001	T
	Surname First Names	
	Company name	
<u> </u>		

AIL ADDRESS FOR ALL CORRESPONDENCE	RELATING TO THIS APPLICATION
NAME: GT BUERS	and a market
Surname or company name	
Colon	11 1 1 1 1 1 1 1 1 1 1 1 1 1 1 1 1 1 1
First names	
ADDRESS: 26c	Nationala Deliver
Street No	Street/PO Box /Private Bag
7 , 11	
Town/District	
PHONE: 757241	< FAX:
STD	STD
SCRIPTION OF BUILDING WORK AND USE:	ing and drainage
escription eg garage, deck, dwelling, shop, plumbi	ing and dramage
700	A Company of the comp
Cows	ERUNTORY
<u> </u>	
YPE OF WORK:	Domolition Department and Drainage Only
	Demolition Plumbing and Drainage Only
Iteration Addition	Demolition Plumbing and Drainage Only
Iteration Addition	_
Iteration Addition Sta	and Alone Building
Addition Addition Change of Use Sta	TOTAL COST OF PLUMBING & DRAINAGE:
teration Addition Sta	and Alone Building
Iteration Addition Standard Change of Use Standard Change of Use Standard Cost OF PROJECT:	TOTAL COST OF PLUMBING & DRAINAGE:
Addition	TOTAL COST OF PLUMBING & DRAINAGE:
Addition Addition Change of Use Starting Change of Use 1 Starting Chang	TOTAL COST OF PLUMBING & DRAINAGE: \$ 00 Inc GST AREA OF BUILDING WORKS:
Addition Change of Use Start Cost of PROJECT: ROJECT DETAILS: Category of Works Domestic Farm	TOTAL COST OF PLUMBING & DRAINAGE: \$ • • lnc GST
Addition Change of Use Start Cost of PROJECT: ROJECT DETAILS: Category of Works Domestic Farm	TOTAL COST OF PLUMBING & DRAINAGE: \$ 00 Inc GST AREA OF BUILDING WORKS:
Addition Change of Use Start Cost of PROJECT: ROJECT DETAILS: Category of Works Domestic Farm	TOTAL COST OF PLUMBING & DRAINAGE: \$ 00 Inc GST AREA OF BUILDING WORKS:
Addition Change of Use Start S	TOTAL COST OF PLUMBING & DRAINAGE: \$ 00 Inc GST AREA OF BUILDING WORKS: 2 m²
Addition Change of Use Start Cost of PROJECT: ROJECT DETAILS: Category of Works Domestic Farm Industrial	TOTAL COST OF PLUMBING & DRAINAGE: \$ OO Inc GST AREA OF BUILDING WORKS:
Addition Change of Use Start Cost of PROJECT: OTAL COST OF PROJECT: OUTAL CO	TOTAL COST OF PLUMBING & DRAINAGE: \$

INFORMATION INCLUDED WITH YOUR APPLICATION

An incomplete application is likely to be subject to delays. It is recommended that you complete and present this check list with your application. This will enable Council staff to assist you in reducing the possibility of such delays occurring.

1	THREE COPIES OF ALL INFORMATION UNLESS SPECIFIED	PROVIDED
3.00		
2.	PLANS DRAWN TO A RECOGNISED METRIC SCALE	
3.	PLANS TO BE REPRODUCED IN DARK PERMANENT LINES Pencil originals are not acceptable.	
4.	 i) Sufficient dimensions need to be shown to fix the location of the building work relative to site boundaries and existing buildings; ii) Any projection or encroachment over a road or public place; iii) The location of existing and proposed stormwater and/or sewer services, easements or wells; vi) Details of any buildings or sites which are of cultural or historic significance. 	
5.	ELEVATIONS AND CROSS SECTIONS OF THE BUILDING WORK These need to show the existing ground lines and intended site works. The critical ground lines are at the foundations and at the boundary. High density unit developments, large houses may also require actual ground levels and floor levels to be stated and a datum reference to be fixed.	
6.	 CONSTRUCTION DETAILS i) Foundation sizes, shapes and reinforcing and spacings; ii) All timber sizes, spacings and spans for wall and door framing, lintels and beams; iii) All window and door sizes, detailing opening and fixed windows; iv) A heat balance calculation or thermal insulation to be shown on the plans; v) All work beyond the scope of NZS 3604 will require engineer's calculations or a producer statement. 	
7.	DETAILS OF ANY KNOWN FILL, FLOODING OR OTHER HAZARD AFFECTING THE PROPERTY	



PLANNING AND ENVIRONMENTAL SERVICES DEPARTMENT

MEMORANDUM

31 January 2001

File: APP 35644

MEMO TO:

SENIOR CONSENTS OFFICER: APPROVALS

FROM:

TECHNICAL SUPPORT OFFICER

SUBJECT:

UNAUTHORISED WORKS - 26 C NEVADA DRIVE, NEW PLYMOUTH

A site visit was carried out on the 31 January 2001 of the conservatory, it is a standard conservatory with the lower glazing in a golden fancy glass. The original decking appears it may have been removed and a Hardi sheet material screwed to the joists.

The conservatory is well sealed and no signs of water leaks to the interior. It is recommend the Unauthorised Works Registration be issued for the conservatory.

N Morris TECHNICAL SUPPORT OFFICER

ID: 039635 APP: 35644

11 January 2001

G Beaumont 26 C Nevada Drive **NEW PLYMOUTH**

Dear Mr Beaumont

CONSERVATORY - 26C NEVADA DRIVE

I acknowledge receiving your Registration of Unauthorised Works Application dated 10 January but wish to advise that the plans and specifications submitted do not fully comply with the Building Code and/or legislation. Further processing of this work will be suspended until amendments or the required additional information is received. The permitted period of suspension will be up to 20 working days within which time it is considered all information should have been submitted.

Building

1. Full construction details of the deck are required.

2. The floor plan and elevations differ for pile layout. Please show clearly the bearer size and span between piles, the joist size, spacing between joists and the length of cantilever of the joists.

3. Show the method of fixing the bearers to the posts and the size and fixing method of the

4. The barrier design is to be detailed including the method of fixing the baluster posts.

5. Provide a detail of how the conservatory is weather proofed to the deck (is deck raised under conservatory).

6. A handrail to the steps is required.

Any remedial work as required by these drawings shall be satisfactorily carried out and reinspected before issue of the Registration Certificate.

Should you envisage difficulty in providing additional information within the given time or wish to discuss the matter Council Officers will be pleased to provide assistance.

Yours faithfully

AUTHORISED OFFICER

Unauthorised /Unrecorded Works Registration No:35644

THIS IS NOT A BUILDING CONSENT

Issued: 31 Jan 01

APPLICANT : MR Gordon Henry BEAUMONT

26C NEVADA DRIVE NEW PLYMOUTH 4601

Application received: 11Jan01

PROJECT LOCATION

Street Address: 26C NEVADA DRIVE, NEW PLYMOUTH 4601

Property ID: 039635

Assessment No:

Legal: LOT 1 DP 15452

COUNCIL CHARGES

The Council's total charges payable on the uplifting of this

application in accordance with the attached details,

\$0.00

Receipt number: 1336844 Date: 10Jan01

Amount: \$148.00

1: Why Register Unauthorised Works ?:

Section 33 to the Building Act 1991 precludes the issue of a retrospective Building Consent by the Council. Section 43 to this Act also precludes the Council issuing a Code Compliance Certificate for work for which no Building Consent has been issued.

The primary focus of the Building Act is to ensure that building works and buildings are safe and also healthy for use and occupation.

The Registration of Unauthorised Works is a means of providing a report on file for future reference and property related enquiries that the unauthorised work is sound and complies with the N.Z. Building Code to the extent that can be reasonably ascertained upon inspection of the completed work(s).


2: Conditions and/or Limitations applying to this Registration:


The registration is for the conservatory as detailed on the application plans.


Unauthorised /Unrecorded Works Registration: 35644

Page: 1

:	Comments	Regarding th	is kegist.	Lacion.	
10	comments				
		Authorise	d Officer		
			Date		

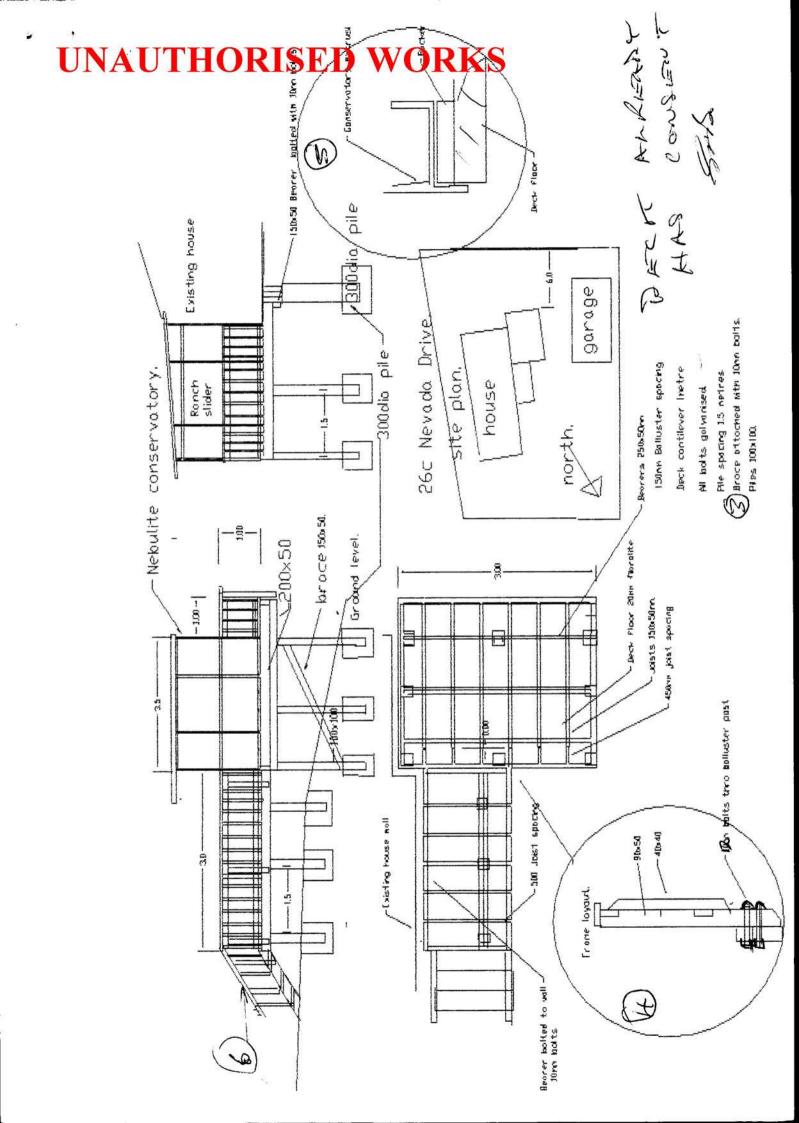

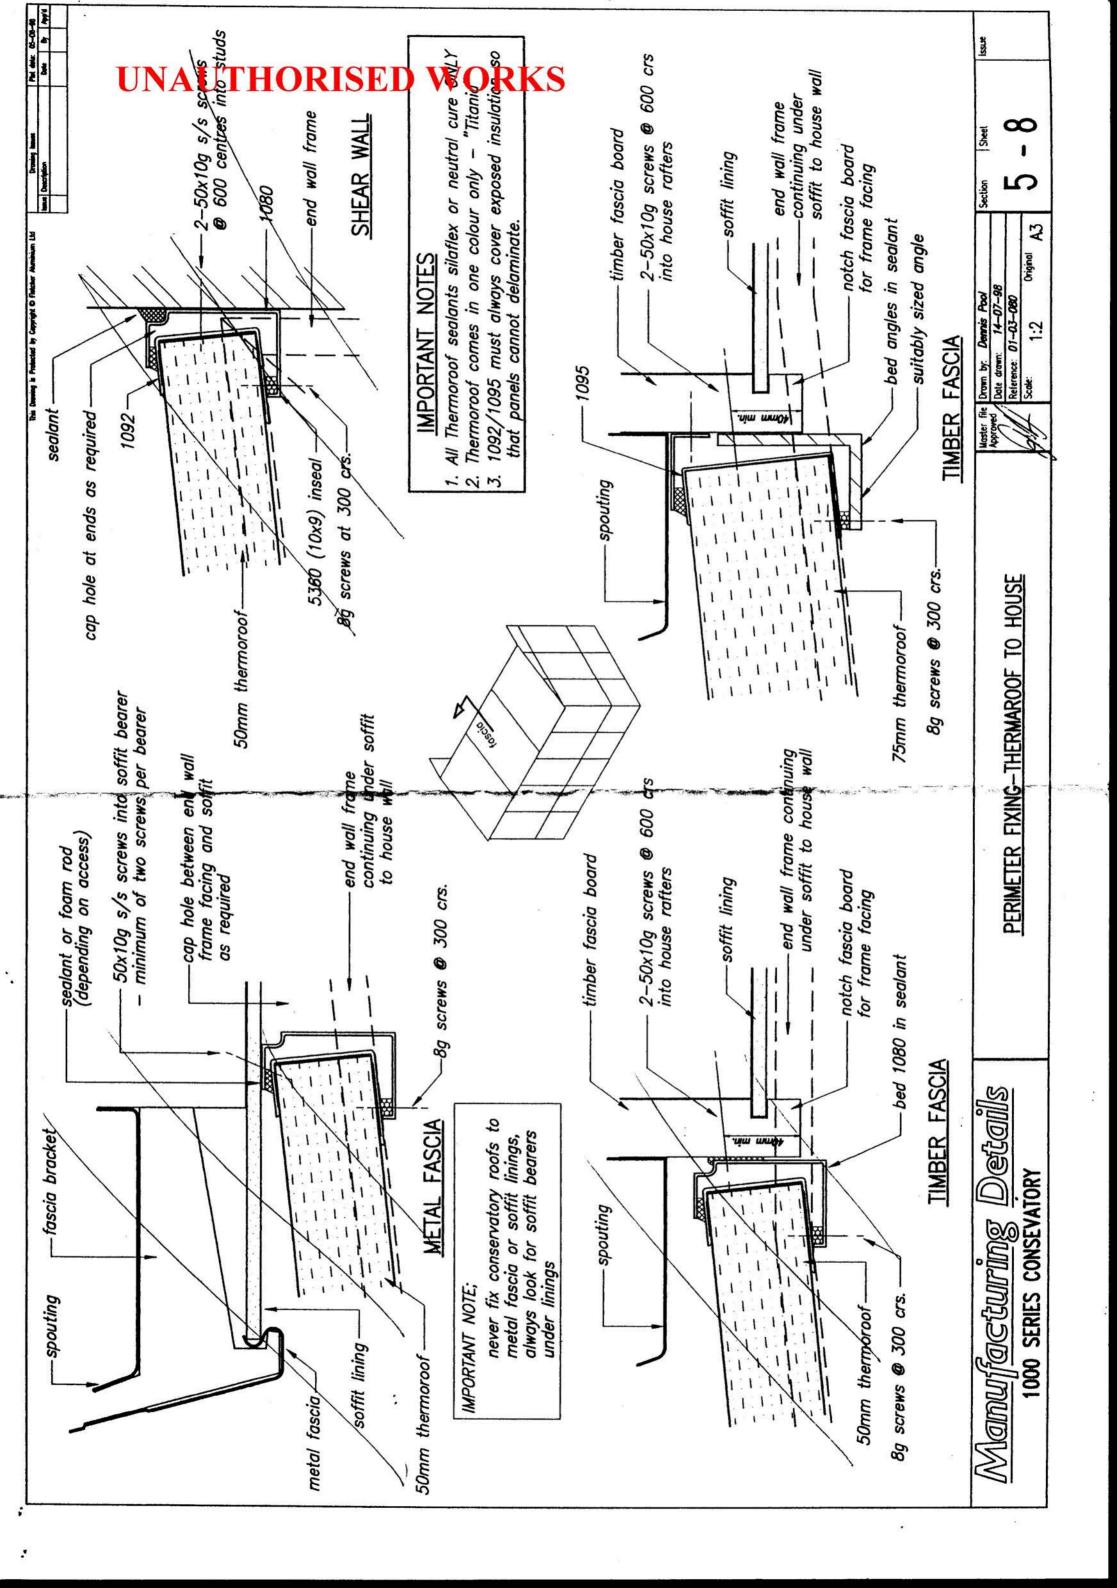

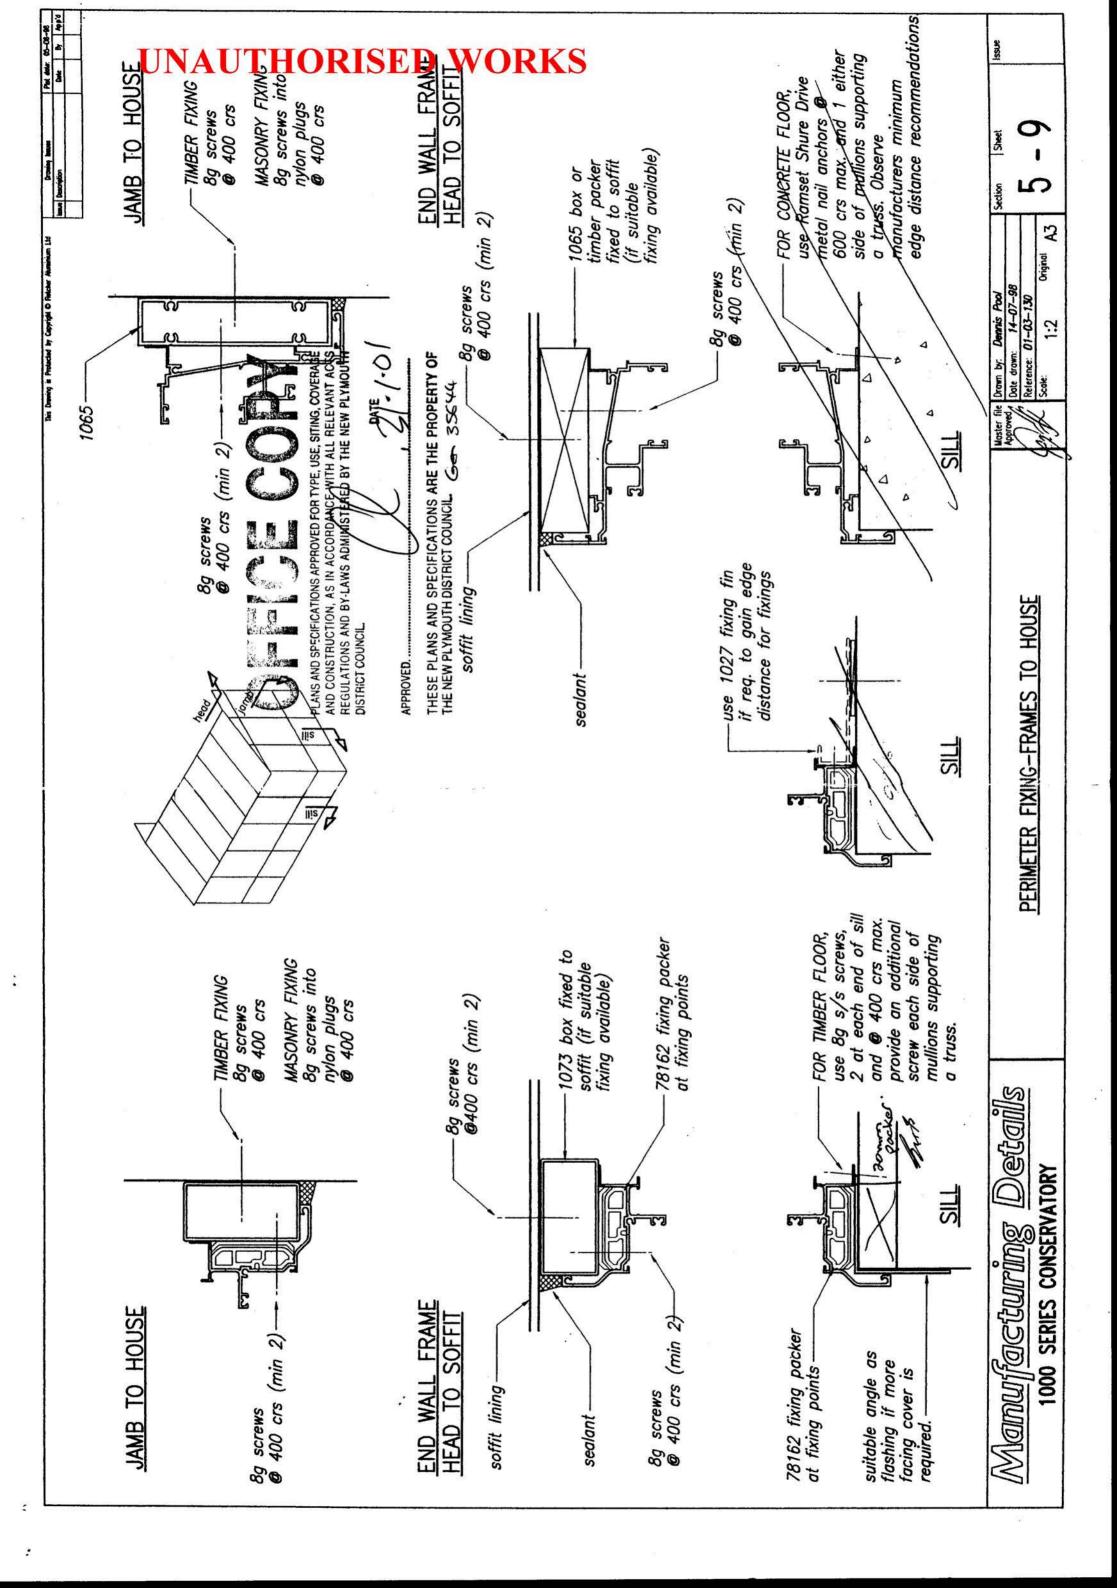


	HEART WET B	H: ACK:	NEV NEV BRI	7 V	<u> </u>	F	EL: EXISTING EXISTING PRECAST	G 🗆	POUI	ED []	S/S 12/ 2 lengths bro	wa
											VIII. 3.3	
<u> </u>			:		:		. ,					
!		0.0	.00			!!				!	Kilche	<u>7</u> 2
		ערו		1	:				<u> </u>		. !!	
				· !				1				<u> </u>
:		•	!		<u>: </u>							
. !				- 	<u> </u>	1				: :		
1 1			_	<u> </u>	-		<u> </u>	1	500 4			:
:			<u> </u>	: <u> </u>		-	i	21	5 0	1	i : l	:
			· !		; !		t , ,			4		
				: 	- ; - ;		-					-
			: !									
						 -	:		<u> </u>	ounce		
										J		,
												.
												·

A

15

ATION AND OPERATION MANUAL INSTAL

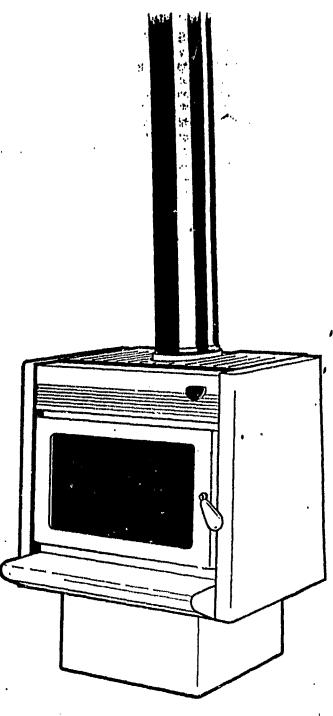

ANT MESSAGE TO THE OWNER

atulations on your selection of the Metro woodfire, this low emission, w combustion appliance is designed to give you many years of warmth and service

Please insure you read this manual fully and become conversant with the correct operation of your Metro . A consent is required from your local building authority which is the owner's responsibility to obtain .

As correct installation is critical to the performance and safe operation , it is recommended your Metro be installed by a registered installer or a person suitably qualified in the installation of wood burning fires , your Metro retailer will be able to arrange professional installation for you. Please take particular note of the following:-

* During the very first fire the Metro will give of an odour and fumes as the firebox paint cures . Do not be alarmed as it will last for approx one hour only and will only happen this one time .

 Properly seasoned (Dry) timber is necessary for the Metro to operate efficiently, firewood that contains to much moisture will result in flue blockages and reduce the heat output of the Metro substantially.

* Never - Dry clothes on the heater

Never - Emply ash into a plastic bucket or paper bag

Never - Burn treated or un-seasoned (wei) wood

Never - Operate the Metro with door ajar except on start up

Never - Oparate the Metro with the Cook top grill removed as wall temperatures behind the Metro will be excessive .

* The Metro is an approved clean air appliance but the following must be noted and adhered to in clean air zones :-

- Only wood with a moisture content of 25% or less may be used as a fuel, coal must not be used.

- The off position on the air control setting must not be used .

IMPORTANT MESSAGE TO THE INSTALLER

The Metro woodfire has been tested too and compiles with AS2918 and NZS7421-1990 when installed in accordance with this manual . Please insure you are fully conversant with this manual and these relevant standards. Correct installation is critical to the safe operation and performance of this heater, Please take particular note of the following:-

*A minimum 3.6 metres of 150mm dia flue is required . This flue must be fully encased from the ceiling to the cowl .

* All flue joints must be sealed and riveted , the bottom of the flue must be fully sealed into the flue stub.

* The Metro must be bolled through the hearth into the floor to comply with the seismic restraint provisions of NZS-7421.

* The Metro is coated in vitreous enamel or if silicon resin paint if it is a Metro Chameleon , take care during assembly , lifting and installation not to mark or damage the panels .

ASSEMBLY.

The Metro woodfire is packaged in a single palletised carton, to minimise freight damage the pedestal has not been attached in position but is packaged inside the firebox . Having Removed the cardboard and timber packaging and located this manual, familiarise yourself with the illustrations on the following page's 3 and 4 and proceed as detailed .

 Open the door, remove the cardboard box containing pedestal, side bricks, door handle, rear shield deflector and bolt bag.

* Remove the 2 x pozidrive screws from the base of the firebox which secure it to the wooden pallet , close and latch the door .

* Remove the "Cook top" grill and lay the collapsed Metro carton on the floor directly behind the Metro.

* Place one hand into and securely grip the flue outlet, place your other hand under the front of the pallet base and gently rotate the Metro backwards untill it is resting on its back, discard the pallet.

* Fully open the Metro's door taking care that the door does not fall closed , take the 4 \times 6mm bolts from the bolt bag and insert them through holes provided in the firebox base . Position the pedestal over the 4 x bolts and fit the nuts and washers supplied (refer diagram 1). Check to ensure the pedestal is correctly aligned and securely tighten the 4 nuts.

* Close and latch the door , taking grip of the flue outlet once more gently raise the Metro untill it is upright . Refit the "cook top" grill and attach the door handle to the door latch assembly by screwing on clockwise.


* Attach the rear shield deflector to the rear panel directly behind the flue outlet, the angled sides point forward almost touching the cook top arili . secure with screw provided .

 Open the door fully and fit the side bricks to each side of the firebox . Location lugs are fitted to the base and rear of the firebox to retain the side bricks in position , refer diagram 2 .

* Fit the top baffle into position in the top chamber of the firebox where it is supported on 4 lugs.(note, the baffle must be hard back against the rear of the firebox with the chamfered comers facing forward as shown in diagram 2)

Your Metro is now fully assembled and ready for installation . Due to the excessive weight of the Metro and the potential to damage panels through incorrect handling, any further moving of the appliance should involve two people each lifting under the side panels.



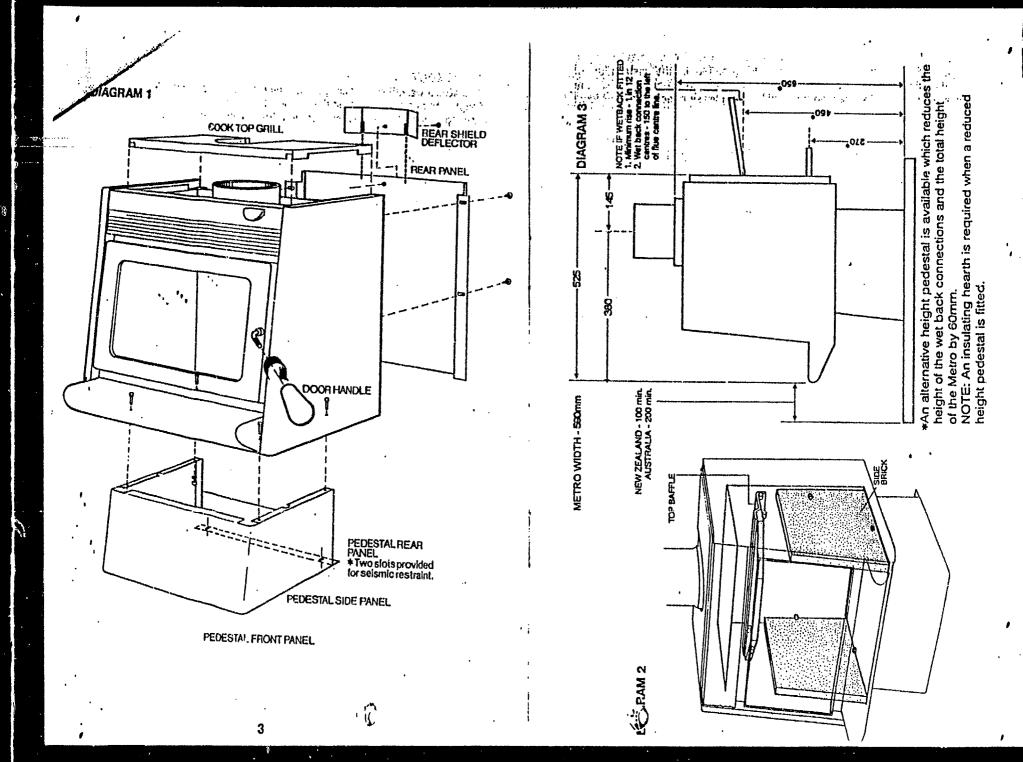

in it is important your Metro woodlire is installed by a staller or a person suitably qualified in the installation of ming appliances. A building consent is required and the lation is usually checked on completion, please check with your local suitaing authority.

HEARTH Prior to construction or placement of the hearth it is necessary to ensure there is clear access for the flue system through the roof cavity, it may be necessary to move the Metro's position slightly to avoid a roof truss etc. Pioneer manufacture custom made hearth's designed to compliment the styling of the Metro at an affordable price, consult your Metro retailer if you wish to consider a Metro hearth.

Your Metro does not require an insulating hearth but must be positioned on an ash hearth which should be of adequate size to give appropriate clearances and projections. The requirements for New Zealand and

Australia differ and are set out as follows :-

NZS 7621-An ash hearth must extend 200mm horizontally in all directions directly below the door opening. The top surface of the ash hearth must be raised a minimum of 25mm above the surface of the combustible floor directly in front of the Metro.

AS 2918-An ash hearth must extend 200mm horizontally to the rear and each side directly below the door opening , and 300mm forward of the door

opening.

A suitable ash hearth is any continuous non combustible surface which includes ceramic tiles with grouted joints fixed directly to timber flooring. If this type of hearth construction is proposed, it is recommended to lay a sheet of 6mm cement sheet (Harditex or villa board) as this will prevent movement of the tiles and cracking of the grout.

Once the hearth is constructed and in final position, the Metro can be positioned ensuring the correct wall clearances detailed on page 6 are

maintained.

If in New Zealand seismic restraint is required, secure through the rear of the pedestal as shown in diagram 1. It is necessary to secure the Metro through the hearth into the floor.

Using a piumb -bob mark the ceiling at a point directly above the centre of the Metro's flue outlet. You are now ready to install the flue system.

FLUE SYSTEM The Metro requires a 150mm diameter stainless steel or vitreous enamel flue 3.6 metres in minimum length and terminate with a suitable cowl and flashing in clear undisturbed air. All flue pipe must be encased as detailed in NZS7421 / AS2918 within the roof cavity or where timber framing is in close proximity. It is also necessary to fully encase the flue pipe between the roof line and the cowl assembly at the top of the flue 'All flue joints must be sealed and riveted and the bottom of the flue must be fully sealed into the flue outlet of the firebox, instructions are supplied with the flue pack.

FLUESHIELD Ploneer have developed a vented double flueshield 1200mm in length which enables the Metro to be installed with minimal wall clearances from combustible walls as detailed in the clearance schedule below. To fit the Pioneer double flueshield proceed as follows referring to the diagram shown:

* Unpack the flueshield and brackets


 Remove the plastic film from both the outer and inner face of the flueshield, a sharp knife or razor blade is required to clean up surplus plastic film left protruding from the crimped joint.

* Fit the unfolded lower bracket to the inner rear heat shield of the Metro directly behind the flue outlet, inside the top grill "cut out".

* Fit the folded top bracket centrally at the top of the "inner" flueshield

facing forward.

* Lift the flueshield into position and locate the bottom of the "inner" flueshield onto the lower bracket previously fitted to the Metro.

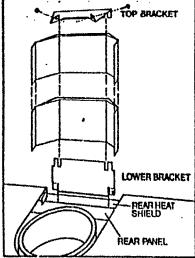

* Attach the top bracket to the flue pipe using rivels or screws .

CLEARANCES Your Metro woodfire has been tested and approved to NZS7421 / AS2918 when installed in accordance with the following minimum clearances from combustible surfaces.

		AUSTRALIA	NEW ZEALAND
With Ploneer	REAR	. 50mm	50mm
Double	SIDE	320mm	300mm
Flueshield	CORNER	100mm	100mm
Without	REAR	405mm	430mm
any	SIDE	320mm	300mm
Flueshield	CORNER	255mm_	280mm

- * An optional Pioneer flue shield "side extension panel" is available which when fitted extends the flue shield depth 40mm and enables a reduction in side clearances to:-
 - 270mm for conventional side wall installation
 - 220mm providing the side wall does not protrude forward of the Metro (le, alcove installation)

Place a quantity of crumpled newspaper on the base of the firebox, add dry kindling and ensure the air control is fully open. You may use commercial fire lighting products to

ease the start up of the fire but never use liquid fuels. Light the fire and leave the door ajar slightly if necessary, approximately 5 to 10mm for a few minutes while the fire establishes. Once burning, open the door and add 2 or 3 small logs at a time until you have a well established fire, usually this will take approximately 30 minutes during which time the air control should be set on high and the door should be closed except for the initial few minutes and when fuel is being added.

Once the fire is established regulate the air control to achieve the desired burn rate / heat output. Note the Metro should be operated with the air control operating in its tower movement range, in the unlikely event that you have a five fire lift the air control knob slightly into the upper movement range and move it fully to the left OFF position.

Note, during the first fire the Metro will give off an odour and fumes while the paint cures on the firebox, don't be concerned, it will last approximately one hour and only happens this one time.

Normal Always open the air control fully prior to opening the door operation then open the door slowly. When loading fuel always place the fuel to allow plenty of air space between the logs and leave on high for a minimum of 10 to 15 minutes. Never use the door to force a piece of wood into the firebox as this may cause the glass to break. When the ash level results in ash spilling out, remove the excess but always leave a layer of ash 10mm to 15mm deep in the bottom of the firebox. CAUTION only use metal containers for carrying or storing ash as it can retain heat for several days.

ExtendedIt is most important if the Metro is to be refuelled and turned down for a slow extended burn that it be operated on high for a period of 10 to 15 minutes prior.

if the air control is turned down to a low setting to soon after refuelling or un-seasoned firewood is used, the excess creosote produced will reduce the life of the top baffle and the flue. In addition the output of the Metro will be greatly reduced and flue cleans will be required much more frequently.

water generators designed to give maximum output with minimal effect on the operation of the fire. Only the Pioneer Cast Jacket wetback system as illustrated should be fixed to the Metro as any alternative type will void the Metro's emission approvals and may seriously effect the performance of the appliance and void it's warranty.

7.

jacket or high output 4Kw alloy version. Both types have been independently tested in a Telarc registered laboratory and your Metro retailer will discuss your particular requirements with you to access which is best suited to your situation.

Both welback options can be fitted to the Inside rear of the firebox, with the connection pipes accessible as illustrated in diagram 3. Position of connection pipes with standard pedestal fitted are:

Inlet = 270mm above hearth
Outlet = 460mm above hearth

Inlet and Outlet = 150mm left of flue centre (facing wall)

NOTE . An optional reduced height pedestal is available which lowers the above connection heights and the total height of the Metre by 60mm , if ϵ reduced height pedestal is used the Metro must be installed on an insulating Hearth .

To fit the Wetback proceed as follows:-

1. Remove the rear panel as illustrated in diagram 1 by removing the 4 pozl drive screws. Remove the 2 pre-punched knockouts from this panel.

2. Having removed the rear panel, 2 further knockouts will be visible and are to be removed from the inner rear heatshield.

 Open the Metro's door and locate the welback access cover plate filted to the left hand side on the rear firebox wall, secured with 4 boits. Remove all 4 boits using a 10mm spanner and discard the cover plate.

4. An additional bolt head will be visible on the right hand side of

the rear firebox wall, remove this also.

5. Using the tube of sealant supplied with the wetback, apply a liberal bead of sealant around both connection holes on the inside of the firebox. On the rear of the wetback casting apply the remaining contents of the tube equally around both connection pipes.

6. Fit the wetback into the firebox and position the connection pipes through the connection holes in the firebox. Securely altach the wet back using 3 of the bolts previously removed fitting them

through the slots provided in the wetbecks jacket.

7. The wetback is ready for connection to the storage cylinder by a registered plumber.

Note * The wetback can only be connected to a vented system.

* The return (hot) pipe should have a minimum rise of 1 in 12.

* The wetbacks performance will reduce as the distance to the storm of cylinder increases, suggested maximum distance is 3 to metres.

8.

.oated in vitreous enamel and will not be effected by normal .or general house hold cleaners ,usually a wipe with a damp cloth .one heater is not operating is all that is required ...

Metro Chameleon's are coated with silicon resin based paint and will require periodic re-painting particularly on the ash lip and around the door opening. As a wide colour range of aerosols are available, you can change the colour of your Chameleon as your desire or decor changes. To clean use a damp soft cloth.

The glass may build up creosote deposits especially if your fuel is not properly seasoned or you are operating on low settings for extended periods, a high fire will assist to burn of the creosote and if it becomes excessive a razor blade scraper can be used on a cold glass.

MAINTENANCE

Flues should be swept a minimum of once a year and as required during the winter, if smoke enters the room when you open the Metro's door this usually indicates the flue needs cleaning.

Door adjustment provision is available on both sides of the door to enable adjustment as the door seal compresses causing air to leak into the firebox .To adjust the hinge end of the door ,open the door fully , loosen the top hinge nut and slightly lift the latch end of the door . You will see the hinge assembly move , approx 1mm will be sufficient , then re-tighten . Repeat by loosening the lower hinge nut but this time apply a slight downwards pressure onto the door .

The door latch is also adjustable as the latch pin on the right side of the firebox is fitted through a slot which enables the latch pin to be loosened, moved back and re-lightened.

Door and glass seals should be replaced when they become hard and start to break up , approximately every 2 to 3 years . The door of your Metro is easily removed enabling the door to be taken to your local retailer for seal replacement . To remove the door open it fully , hold it in both hands and lift the hinge end of the door up over the top hinge pin . then lower the door from the bottom hinge pin .

Side bricks need to be replaced if the become cracked or broken through mechanical damage (continuous bumping with firewood). The Metro, must not be operated unless both side bricks are in sound condition.

Top baffle will also require replacement if it becomes distorted or breaks, the Metro must not be operated with a faulty or missing top baffle.

(1)

14	ILINO WA	RRANTY		
ا و و و آسون د				
**************	*****	********	******	****

PIONEER Manufacturing Limited warrants the steel firebox against defective materials and workmanship which would render it unfit for normal domestic use within a period of five years after date of original purchase. All other parts including cabinet, door, glass, baffle, bricks and seals are warranted for a period of one year, from date of original purchase for domestic use against defective materials and workmanship.

WARRANTY CONDITIONS

- The heater must be installed, operated and maintained strictly in accordance with the building code and the manufacturers installation and operation manual.
- * This warranty covers the replacement or repair at the manufacturers discretion but excludes freight and/or travel costs.
- * The manufacturer or there agent are not liable for any loss or expense direct or indirect arising from the failure of any part or operation of the heater.

A claim under this warranty should be directed to the retailer who supplied the heater, or if this is not possible write direct to the manufacturer stating details of fault, serial number of heater, date purchased and name of retailer.

LOCAL CONSUMER	LAWS APPLY TO THIS WARRANTY
************	100000000000000000000000000000000000000
IMPORTANT - Complete a	and retain at time of purchase:-
PURCHASE DATE	
SERIAL NUMBER	
COLOUR	
RETAILERS NAME	
ADDRESS	
PH. No.	

PIONEER

MANUFACTURING LIMITED

MAMAKU STREET
P.O. BOX 11 INGLEWOOD
PH 06 7566520
FAX 06 7566540
NEW ZE ND

BUILDING FILE Code No. 382 Subject Dwg No. Sheets Permit No. Date

NEW PLYMOUTH CITY COUNCIL DEING ISSUED

FOR OFFICE USE: File No	7 71			
The state of the s	6682	Herrica on Hans of	ni nëmp2n3n9va Ioni na Masaga	100
_ ,	sipt 24 . 7		12 1 100 13 6 14	र्वाके विश्व कर्ताछ।
	t ระไทย ถ้านต่อง ได้ พ	diffic in andign	्रोमार्थ १८३ क्रांसीना वर्षे १	2 1 11 22 GH) 27 22 GH3.
व्याप्यक्र प्रभाव । व्याप्ताक्ष्म स्थापना । स्थापना विकास स्थापना । विकास स्थापना ।		पर्यकृति होते व्यक्ति	e skali ke suippiteli. Westakke bakk divi	chd rappes the
TO THE CITY ENGINEER	10000 <u>111-24 - 3</u> 71 is nobusy 1	erska distribusio se establis	JUL 1986 Date. 1	insolved by Visit
APPLICATION FOR BUILDING P			Lot No.	
The state of the s	***************************************	IVE COMERCE	The Louid Pier	
For erection of DWELLING			No.	5 4 . 44 . 4 m
OWNERUR PORTER & BCI	NARD STORE IS	ADDRESS 4	SPENCE PL	ACE N
Proposed Use PRIJATE R			- Visiongdo brio ma'	िष्टां प्रदेशिये जार
Foundation GENTON TIMBER	all and the state of the state	HARO PLAC	g Sailtiera Sal 2003	
Foundation	Wa	un Timbers T	RAMEROOF LORK	NUMED
AREA of Site		535	M	
AREA of existing buildings		Gestevan oldinas sub	M2 To Jecus	
AREA of existing accessory buildings	ulbitud bel guisati od carno tibus semi	alegan id prijalski	ndividu (Šie dobad) Dedo mi nemakidos	Will state of the
inters of existing accessory outstings		Q-7		
AREA of Building in application		7.0	M ²	
Builder BEAZLEY HOMES	and the first defense with	ddress		***************************************
P.O. BOX 749 NEW PLYMOUTH		Address	Serg dit la spagen n	Thed they re
PHONE 88-728				
tructural Eng	chaming of the creak		To the advisor of the second	Shippin Ships
kilding Projects Authority Required	Yes No Supp	lied Yes/No		
			FOR OFFICE	TICE
otal Value of Building	s 480	on —	Corrected Value	犯法 しゅまた じょ
anitary Plumbing and Drainage	\$ 5.	100-		
alue of Building for Permit	s 50 s43	00-		
later for Building				
uilding Research Levy on				
cardings Mths @				
		TOTAL	FEES BUILDING	
artine Date AUGUST	1091-			
arting Date PUUUS	1 0 Fi	nishing Date	CTOBER 199	
AME AND ADDRESS OF APPLICAN		Y HUME:		
	P.O. E NEW PI	BOX 749 LYMOUTH	Phone	
	rnun	E 88-729	100	1
	Si	gnature of Applica	m JKCW	dess
			Ur sensee	

Signature of Owner

NEW PLYMOUTH CITY COUNCIL CITY ENGINEER'S DEPARTMENT



agreeurs stress hands the gallindom from Agentade Lide s that ages with my been measured but man high all afternaments	e to risky dough a fall beingenhoods, act (links 1)
To the City Engineer	Phone No. 881726
I wish to apply for permission to carry out the work described	in the plans and specifications deposited herewith at:-
House No 26 B Street NEUADA DPIJE	Lot No. D.P.
OWNER JR PORTER # 60 WARD AND	ea of Site (Vision and St. 1997) 20140
ADDRESS SPENCE PLACE NP Sig	mature of Applicant DROWLING
Proposed Use DWELLING 9822 900 Sig	nature of Owner
VEHICULAR CROSSING 00.001 00.004 00.002 00.003	When required
Proposed Existing	Position
36,0% (7.5.5%) \$0.5% 00.5% (0.5.6%)	L/Boundary to C/ Line
WATER CONNECTION	117
Size of Existing Connection 0 mm b	n Belgaria n (n. 1945). Die der Stadt (n. 1945). Belgarian (n. 1945). Die der Stadt (n. 1945). Die der Stadt (n. 1945).
Size of Requested Connection NA	
NA	.E.M
de la	tyle he taco transmiser ody vnicesara inf
No. Units served	
Size of Existing Connection	but and the latest we will put disease but the second metres of the latest sentially themselves the second
	ow/above the ground level of the point where the sewer connection quired.
N A	*Strike out whichever is inapplicable.
Distance from L/Boundary Dep	
Conditate	10000 shindayeem
Disposa (spooliy)	
PLUMBING AND DRAINAGE	Eirie ITO
Name of Registered Plumber / Drainlayer ANCHOR	EUIS GD
Value of Proposed Work, Labour Only Plur	nbing 500
	inage
Drainage	
NA	
Size of Existing Drainage	
Size of Proposed Drainage	
Other Works Proposed Stormwater Disposal (specify) SOAK HOLE	
File No. 7 71 Rec. No. 56862	28236 Check Sht. No FEES Sewer
Date 14 JUL 1986 Zone	Sewer Sht. No. P&D.
	Veh. Crg

BUILDING INSPECTOR'S FIELD SHEET


382 26 AUTHORITY

Stats. No. D 028229

THE STREET		TH CITY COUNCIL 6.60 28236
Inspector: M	File No.	7 71 86 Date Permit Issued 24, 7, 86
	ELECT PIE NO.	Date Permit Issued 1/180
OWNER		BUILDER
1	PORTER - SC WARD	NEW POEAZLEY FORKES
Mailing Address	268 NEUROR DR	Mailing Address PO POX 747
k (DEW PERMOUTH	1 NOEW RYMOUTH
	July 12 The state of the state	W 88726
PRO	PERTY ON WHICH BUILDING IS TO BE	LEGAL DESCRIPTION
3,70	D= 0001=	
Street No.	HE HEOUE	Valuation Roll No.
Street Name		Lot D.P15452
Town/District		Section Slock
Riding	January Supplier and Main Bur	Survey District
055031	PTION OF PROPOSED WORK AND MAIN PUR	
FLOOR		NATURE OF-PERMIT (TICK BOX)
Whole Sq. Metres	Number Erected	- exclude domestic garages and domestic outbuildings
		FOUNDATIONS ONLY
ESTEMATED	Partie	ALTERED, REPARED, EXTENDED — include conversions and resided buildings
VALUES	Drainese	NEW CONSTRUCTION
*		OTHER THAN BUILDINGS — include demolitions DOMESTIC GARAGES
	101A <u>48000 (00)</u>	AND DOMESTIC OUTBUILDINGS
FEES AF	PPLICABLE	
Building Permit Street Damage De		8 Receipt No.
Building Research	Levy M.S. Plumbing	Date of Payment 2/2/26
Plumbing		Authorised Officer A was all
Sewer Connection	\$TOTAL:	
Special Condition	\$ 7	जिल्लाक कर के किया है। जिल्लाक के किया
		and the first of the second second The second s
• .		
-		
Date Inspected	REMARKS (e.g. stage reached with wo	n de la companya de Prika de la companya
	11	
	feeles of grow	nd good
12/8/86	check outs to	rig I sails requirel
-		11 . Lit. O. L + t.
	on all poles as	well as bolls there outs to (CONTINUED OVER)

	be treated with out outs exceeded 35 mm
	be treated will ait outs exceeding 35 mm
18/86	Preline ok prace extra unelet house I braces needed both ends of house
	I braces needed both ends of house
	masture 22-25 average est to line
16/0/186	Emploted
711	
·	
_	

•	gnature)Date

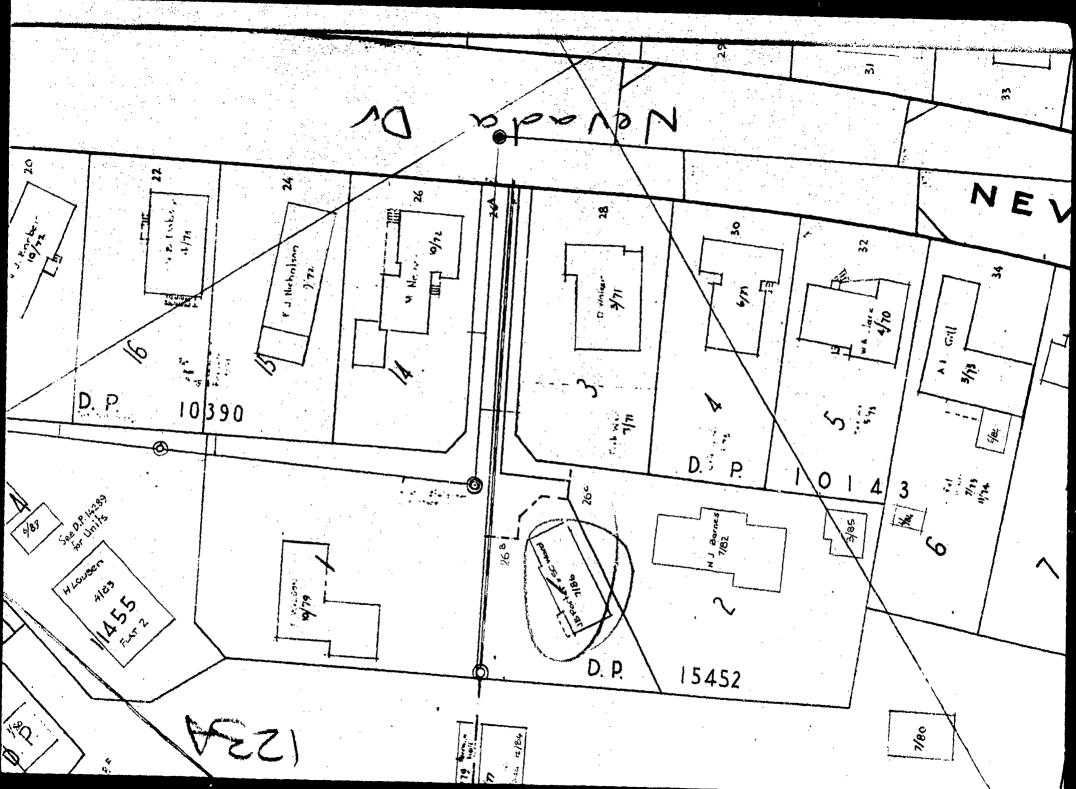

CITY ENGINEER'S DEPARTMENT

ASSESSED	REQUIREME	NTS

Not Approved _ _ _

71

File No .. ____ Check Sheet No.____ 28236 SOERTIOG DWNer: JR BATER, SC WARD Sewer Sheet No.123A Plotted: MID DR__ Zons:______ Address: 268 NEUADA 452_ Sec. No.____ Area of Site: ____ ____ D.P._ VETTING TO BE COMPLETED BY TOWN PLANNING Designations______ Coverage Maximum Height______ Relat. of Bldg. Size: (1) Rear Yard_____ (2) Side Yard______ Grassed Areas______ Building Lines & Street Widening_____ Parking______ Access to Rear of Site______ Accessory Buildings_______ Service Lanes & R.O.W._____ Crossing Length Gross Floor Area of Shops______ SEE SECTION CARD Use of Yards______ BUILDING --DRAINAGE -Loading _ _ _ _ - - - - -WAYER -Amalgam. of Titles_____ Remarks: Approved___

SERVICES

•		
Existing Service		
Required Service	the sate was not now such that was been page danging our tags gar day.	
Location		
Depth	24	
Special Requirement		
Common Drain		
Fee \$	Fee \$	•
	FEE \$=	z :
B: WATER CONNECTION		
Existing Service _ 20 mm D		
	eight above Datum	
Distance: Main to Boundary		
Boundary to Load		
Required Service 20 mm		
leter Not required.		٠.
	FEE \$	
C; PLUMBING		
o. Fittings W.CsBathsBasinsSi	2 2 2 2 Showard Tube Othern	
otal Values	mass dnowerslobsothers	
	C. Copper Gal. Iron	`
•		
ackflow Prev	competendial. If the	1 4.
ackflow Prev	couper and iron	
ther Fittings		
	Plumbing Fee	
ther Fittings		
ther Fittings		
stimated Value	Plumbing Fee	
ther Fittings	Plumbing Fee	
ther Fittings	Plumbing Fee	
ther Fittingsstimated ValueScools RAINAGE xisting Required ittings Required ommon Drain	Plumbing Fee	
ther Fittings	Plumbing Fee	
ther Fittings	Plumbing Fee	
ther Fittings	Plumbing Fee	
RAINAGE xisting Required ittings Required informater stimated Value	Plumbing Fee	
ther Fittings	Plumbing Fee	
RAINAGE xisting Required ittings Required informater stimated Value	Plumbing Fee	
RAINAGE xisting Required ittings Required immon Drain eptic Tank tornwater Sco stimated Value P. & D. \$ 600 :000 C. VEHICULAR CROSSINGS	Plumbing Fee	
RAINAGE Existing Required ittings Required common Drain eptic Tank comwater Sco Stimated Value Sco Otal Estimated Value P. & D. \$ 1600 : 000 C. VEHICULAR CROSSINGS Type of Footpath A Condition erb & Channel Condition	Plumbing Fee	
RAINAGE Existing Required ittings Required common Drain eptic Tank comwater Sco Stimated Value Sco Otal Estimated Value P. & D. \$ 1600 : 000 C. VEHICULAR CROSSINGS Type of Footpath A Condition erb & Channel Condition	Plumbing Fee	
RAINAGE RAINAGE Risting Required ittings Required common Drain common Drain common Tank common to the commuter stimated Value Otal Estimated Value P.&D. \$(600:000) C. VEHICULAR CROSSINGS Ope of Footpath All Condition crb & Channel crb & Channel cisting Crossing 3 Grace Tipp all gard	Plumbing Fee Drainage Fee FEE \$ 70	
RAINAGE Existing Required ittings Required common Drain eptic Tank comwater Sco Stimated Value Sco Otal Estimated Value P. & D. \$ 1600 : 000 C. VEHICULAR CROSSINGS Type of Footpath A Condition erb & Channel Condition	Plumbing Fee	

REMARKS : CORRESPONDENCE : AGREEMENTS SPECIFIC REQUIREMENTS

362/26/b

Se	wer	connection	to exist	MH IS	part	of	Subdivisional	requireme	nt.	PC	17-7-86
								·····			
											·
											
						<u> </u>				····	
						.,		Approved	PC_	17:2	_86
							No	t Approved			


									*		
									*		
											
								· · · · · · · · · · · · · · · · · · ·			
	<u></u>		·····							No	44.7
				, , , , , , , , , , , , , , , , , , ,				Approved	_ OW	<u> </u>	10/
						تدليون سوي	No	t Approved		`: 	
						*			-		
									÷ .		
							•				
							14.5%.				
										· · · · · · · · · · · · · · · · · · ·	
								•			~ ~ ~
								Approved			
							No				
								••	•		
								•			
·				<u> </u>							
											
					<u> </u>						
											
***										<u></u>	
								Approved	-2	Lega	
	******						No.	t Approved			
								,			•
			·····								
										 	
				<u>,,,,,,,,,,,,,,,,,,,,,,,,,,,,,,,,,,,,,</u>					 		
-											
											
***************************************								Approved			1-86
							No				


: HEALTH & BY-LAWS		рф 2-2-	
reas			3
ight	e di di series di se		
entilation			
emarks:			
	Approved.	He-	1/7/86
	Not Approved_		
	1		
362	126		
: DANGEROUS GOODS			
omestic or Commercial			
torage Capacity & Location			
icence Required Yes/No			
Testing usdation 100%	Approved		
	Not Approved		ادران پښورچ مد جدي
G: BUILDING			
lemarks:			
		· · · · · · · · · · · · · · · · · · ·	
	FEES:	A6400.00	
	Bldg.	43.000	1950
	Water Bldg.		5-00
	B.R.L.	A8.000	
	TOTAL		248 0
	1 1 1 1 1 1 1 1 1 1 1 1 1 1 1 1 1 1 1	· ·	
	Approved	70	16/7
Building Inspector			
	Not Approved		و کرونسا ہے میں ہے ۔ ایک ا
Specification:			1138
Structural Engineer	Approved	*	
COMPLETED &	Not Approved	+ 5	
Fire Service	-		
	Not Recommended		
	Approved		
PERMIT NO. 28229			

BUILDING FILE Code No. 382/260 Subject REMEDIAL WORK DWG No. Sheets ___ Permit No_1103 Date

BUILDING INSPECTOR'S FIELD SHEET	AUT REW PLYMOUTH	CITY COUNCIL No. F 011103
nspector: M	File No. 3	78/89
Receipt No.		Date Permit Issued 12/4/67
OWNER		BUILDER
Name A A A TARE		Name
Mailing Address	1) 1 12	Mailing Address () - 1 11 KLLEY + (YAC)
	247.41	1 M. Kacas Leymonth
		7/9/3
PROPERTY ON WHICH BU	ILDING IS TO BE EREC	
SITE		LEGAL DESCRIPTION
Street No.	1)14 <u> </u>	Valuation Roll No.
Street Name		Lot D.P/ 54 52
		Ţ'
Town/District		Section Block
Riding		Survey District
DESCRIPTION OF PROPOSED WO		
	(
		THE PERSON OF THE PROPERTY OF THE PERSON OF
FLOOR AREA DWEL	LING UNITS	NATURE OF PERMIT (TICK BOX) NEW BUILDING
Sq. Metres Erected		exclude domestic garages and domestic outbuildings
Building)	788 L	FOUNDATIONS ONLY ALTERED, REPAIRED, EXTENDED, CONVERTED, RESITED
ESTIMATED Plumbing		- include installation of heating appliances
VALUES Drainage		NEW CONSTRUCTION OTHER THAN BUILDINGS — include demolitions
G.S.T. /		DOMESTIC GARAGES AND DOMESTIC OUTBUILDINGS
FEES APPLICABLE		
	Connection \$	Receipt No.
Street Damage Deposit . \$ Building Research Levy \$	\$ \$	\pm $12.14.59$
Plumbing	\$ \$	Date of Payment
Sewer Connection \$ Vehicle Crossing Levy \$	\$ G.S.T. \$	Authorised Officer (
M.S. Plumbing \$	TOTAL: \$	+
pecial Conditions:		
	wif phills	
ate Inspected REMARKS (e.g. stage	reached with world	
ate Inspected REMARKS (e.g. stage	reached with work)	
<u> </u>		

FOR OFFICE USE:	File No	3 78	Check Sheet No. 322C	6
	Receipt No	14165	Check Sheet No. 320 Sewer Sheet No. 123 Zone.	À
	Date of Receipt	12.4.	S9 7	• • • • •
	Date of Receipt.		Zone	
ADDRESS OF PROP	ERTY 26° N	EVADA DR	21	Mai: 1 989
LEGAL DESCRIPTION	N OF LAND: LOT:	2	DD 15450	•••••
NAME OF OWNER (DETAND INK	PORTER	De C	
NAME OF OWNER C	F BUILDING:. MR	PORTER	ADDRESS: 25 New 22 ADDRESS: 25 New 22 ADDRESS: P.O. Box 38	a Drive
NAME OF PRINCIPA	L CONSULTANT: .	t.Associates.	ADDRESS P.O. Sox 535	5. N.P.
NAME OF OCCUPIE	K V. S X S	ングイドス	ADDRESS DE No. all	2 0
NAME OF BUILDER:	W.K	>le	ADDRESS: 48 Frankling	2. Ped
***************************************	• • • • • • • • • • • • • • • • • • • •	• • • • • • • • • • • • • • • • • • • •		Ü
DD CD C C C C C C C C C C C C C C C C C		• • • • • • • • • • • • • • • • • • • •		
PROPOSED USE OF A	BUILDING	• • • • • • • • • • • • • • • • • • • •	• • • • • • • • • • • • • • • • • • • •	
For Permission To	esery sub.	renedial	Dogumenta, etterile 1	
work on	subfroor F		Documents: attached as part of this application which are applicable:	
ex per at		7~	Drawings - Two sets (See notes on back of sheet)	
			Specifications - Two copies	
			Form No. 2 - Structural Design Features Summary Part A and Part B	
			Form No. 3 - Fire and Egress Features Summary	
DESCRIPTION OF PRO	OPOSED WORK:		Building Project Authority	
New building	Conversion		Estimated starting date	
Addition Alteration	Demolition			
Hoardings M			Estimated completion date	
•			New floor area	• • • •
Total Value of Building	Excluding G.S.T.	s 788	FOR OFFICE USE Corrected Value	
Sanitary Plumbing and Dr (Exclud	rainage (Labour only) ing G.S.T.)	\$		
Value of Building for Perm	uit	\$ 788		
	T)	1		
NAME OF APPLICANT	······	210		•••
Address AS	trankley.	Koad,	•••••	
lignature	to the	Telephone No.	75913 <	
		,	(e.g. owner, builder, principal consulta	

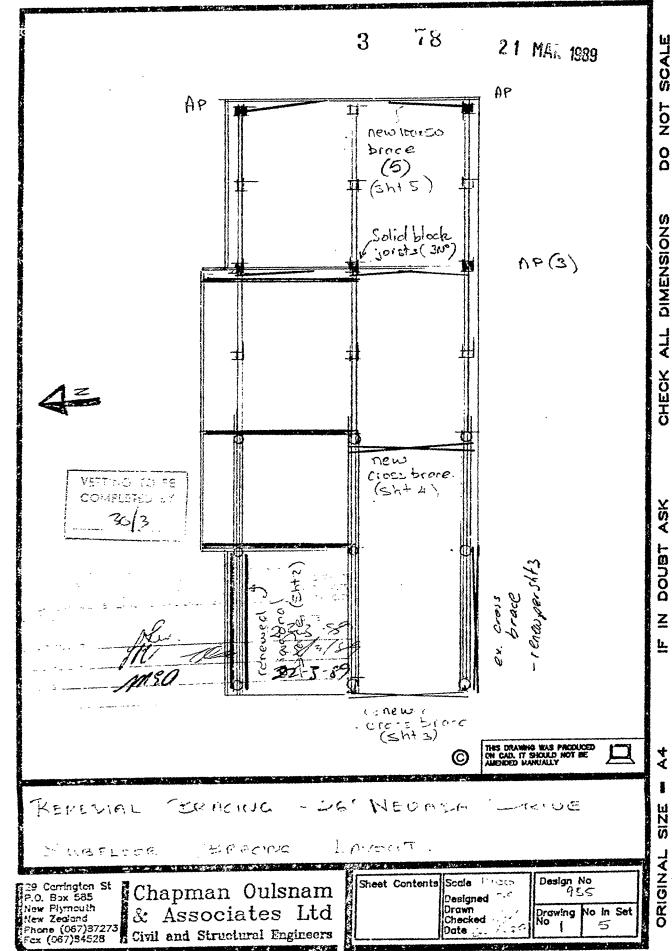

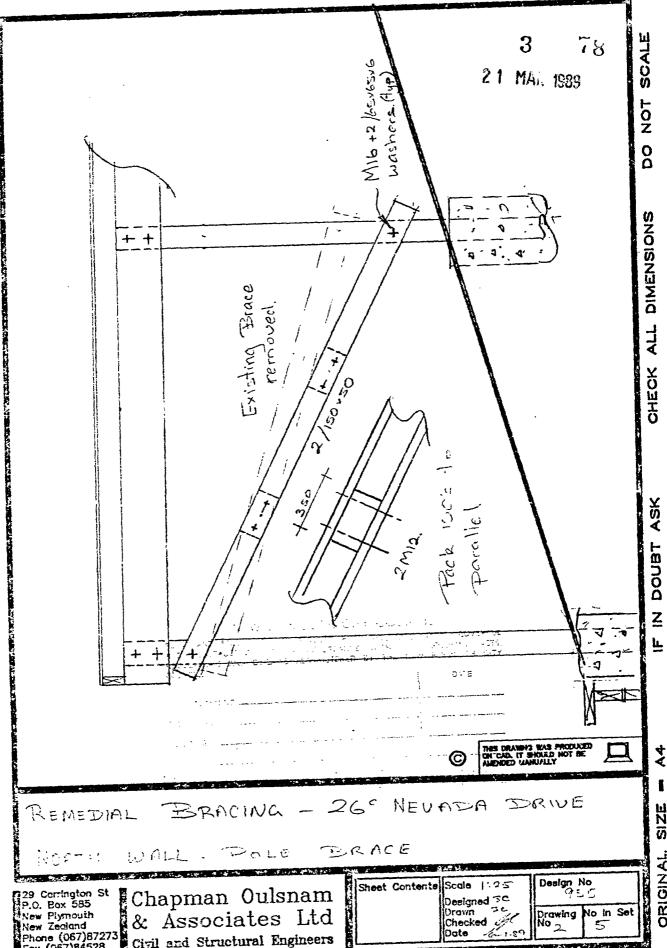

SIZE ORIGINAL.

SCALE

TON OG

CHECK ALL DIMENSIONS

ASK

IN DOUBT

THIS DRAWING WAS PRODUCED ON CAD. IT SHOULD MOT BE


REMEDIAL BRACING - 26° NEUADA DRIVE


WELT WALL FOLE BURGE

29 Carrington St P.O. Box 585 New Plymouth New Zealand Phone (067)87273 Fax (067)84528 Chapman Oulsnam & Associates Ltd Civil and Structural Engineers

Sheet Contents	Scale 1:25	Design	No
1	Designed 3C Drawn 5C Checked 7C Date 6 1-29	Drawing No 3	No in Set
L	Date 6 - 1-11	L	L,i

ORIGINAL SIZE - A4

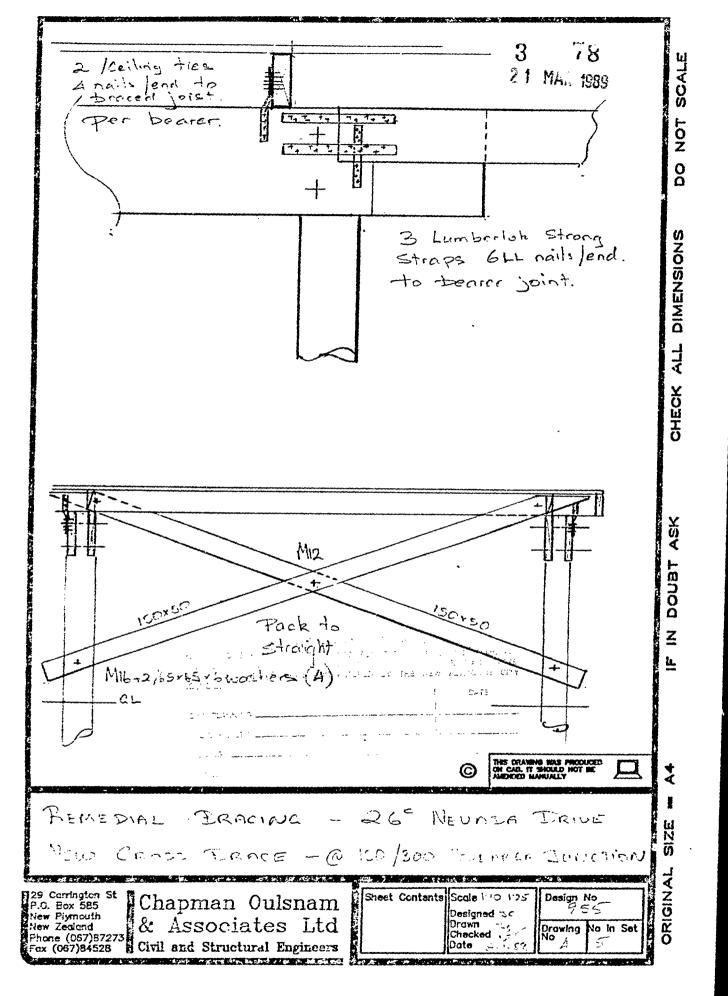

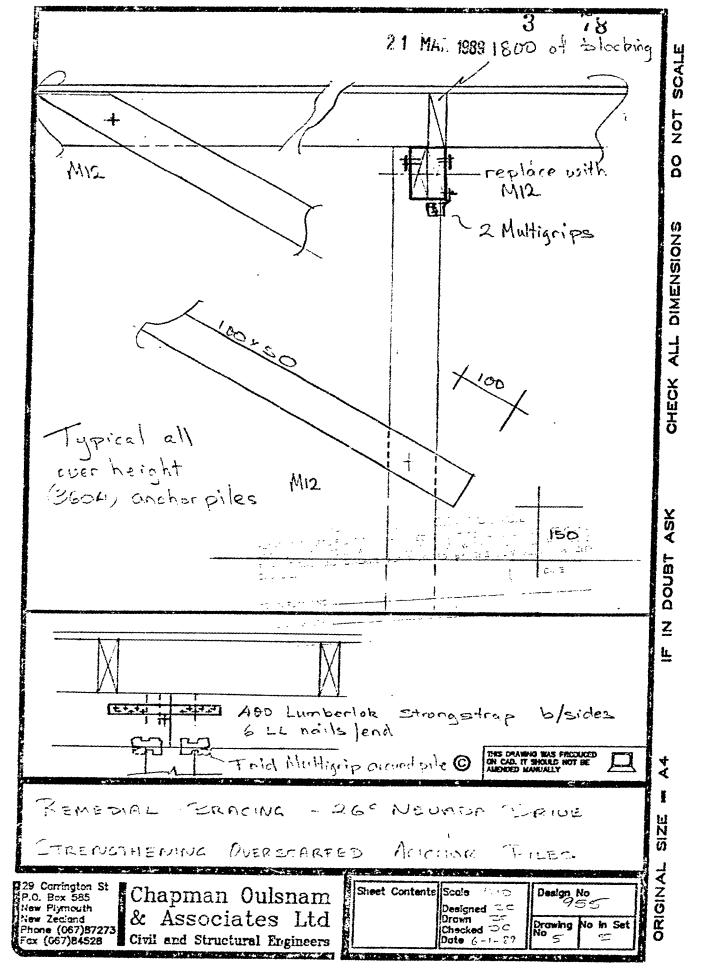

382/260

CITY ENGINEER'S DEPARTMENT

ASSESSED REQUIREMENTS

			File No. 3	
Project: REMEDIAL Gwner: MR TORT Address: 260 NEUr	Wheir DNO	Check Sheet No.	32206	_
Owner: MR TORT	ER	Sewer Sheet No.	123 A	<i>ラ</i> ナー
Address: 26° NEUr	ada 1015	700e: Ro	: tottea:Z	
Lot No2D.P	15452	Sec. No	^	
		occ.	VEITING TO BE	
			COMPLETED BY	
TOWN PLANNING			30/3	•
Designations				
Area of Buildings				
Coverage				
Maximum Height				
Front Yard				
Relat. of Bldg. Size: (1)	Rear Yard			-
(2)	Side Yard			-
Open Space				1
Grassec Areas			. —	1
Trees				·
Building Lines & Street W	idenina_			-
Ferking				-
Access to Rear of Site				-
Accessory Buildings				·
Service Lanes & R.O.W				-
Drossing Length				-
Gross Floor Area of Shops.				-
Resid. Accom				-
Levels of Sitelle				
use of Yards	gae gan	NON CARD		
_secinc				
creening	TOWN FLE INDIG	Law -		
ralgar. of Titles	อิษเวเวร			
enarks:	DRAINACE	- Remir		
	WATER	water 1		
				[
				-
				-
				_
				_ [
			Approved	ł
		Not	Approved	

S E R V I C E S

	STORMWATER CONNECTION
Existing Service	
Required Service	
Location	
Depth	
Special Requirement	*
Common Drain	
Fee \$	Fee \$
	FEE \$
B: WATER CONNECTION	
Existing Service	
Distance from L/Boundary	Height above Datum
Distance: Main to Boundary	
Boundary to Load	
Required Service	
Meter	
	FEE \$
C : PLUMBING	
3 3 1	2 2 2
lo. Fittings W.CsBathsBasins	2 2 2 Sinks ShowersTubsOthers
otal /aloas	
Supply Pipe Sizes	P.V.C. Copper Gal. Iron
eckflow Prev	
ther Fittings	
stimated Value	Plumbing Fee
<u>Rainage</u>	
xisting Require	d
ittings Required	
ommon Drain	
eptic Tank	
tormwater	
sorwered value	Drainage Fee
otal Estimated Value P. & D. \$:	FEE S
: VEHICULAR CROSSINGS	
pe of Footpath Condition	DR
rb & Channel	
isting Crossing	Inst. No
w Crossing Position	
	- D
rengthen Path Sq.Yds Level at	: boundary


REMARKS : CORRESPONDENCE : AGREEMENTS SPECIFIC REQUIREMENTS


Note: G.S.T. is to be excluded from all fees quoted in this Document. _ Not Approved_ _ Approved= Not Approved_ Approved____ Not Approved____ Approved _ _ _ - Not Approved_____ Approved 3 4/1 28


- Not Approved_ _/_

16mm 35mm


BUILDINGFILE Code No. 382/26° Subject Dwa No. Sheets Permit No Date

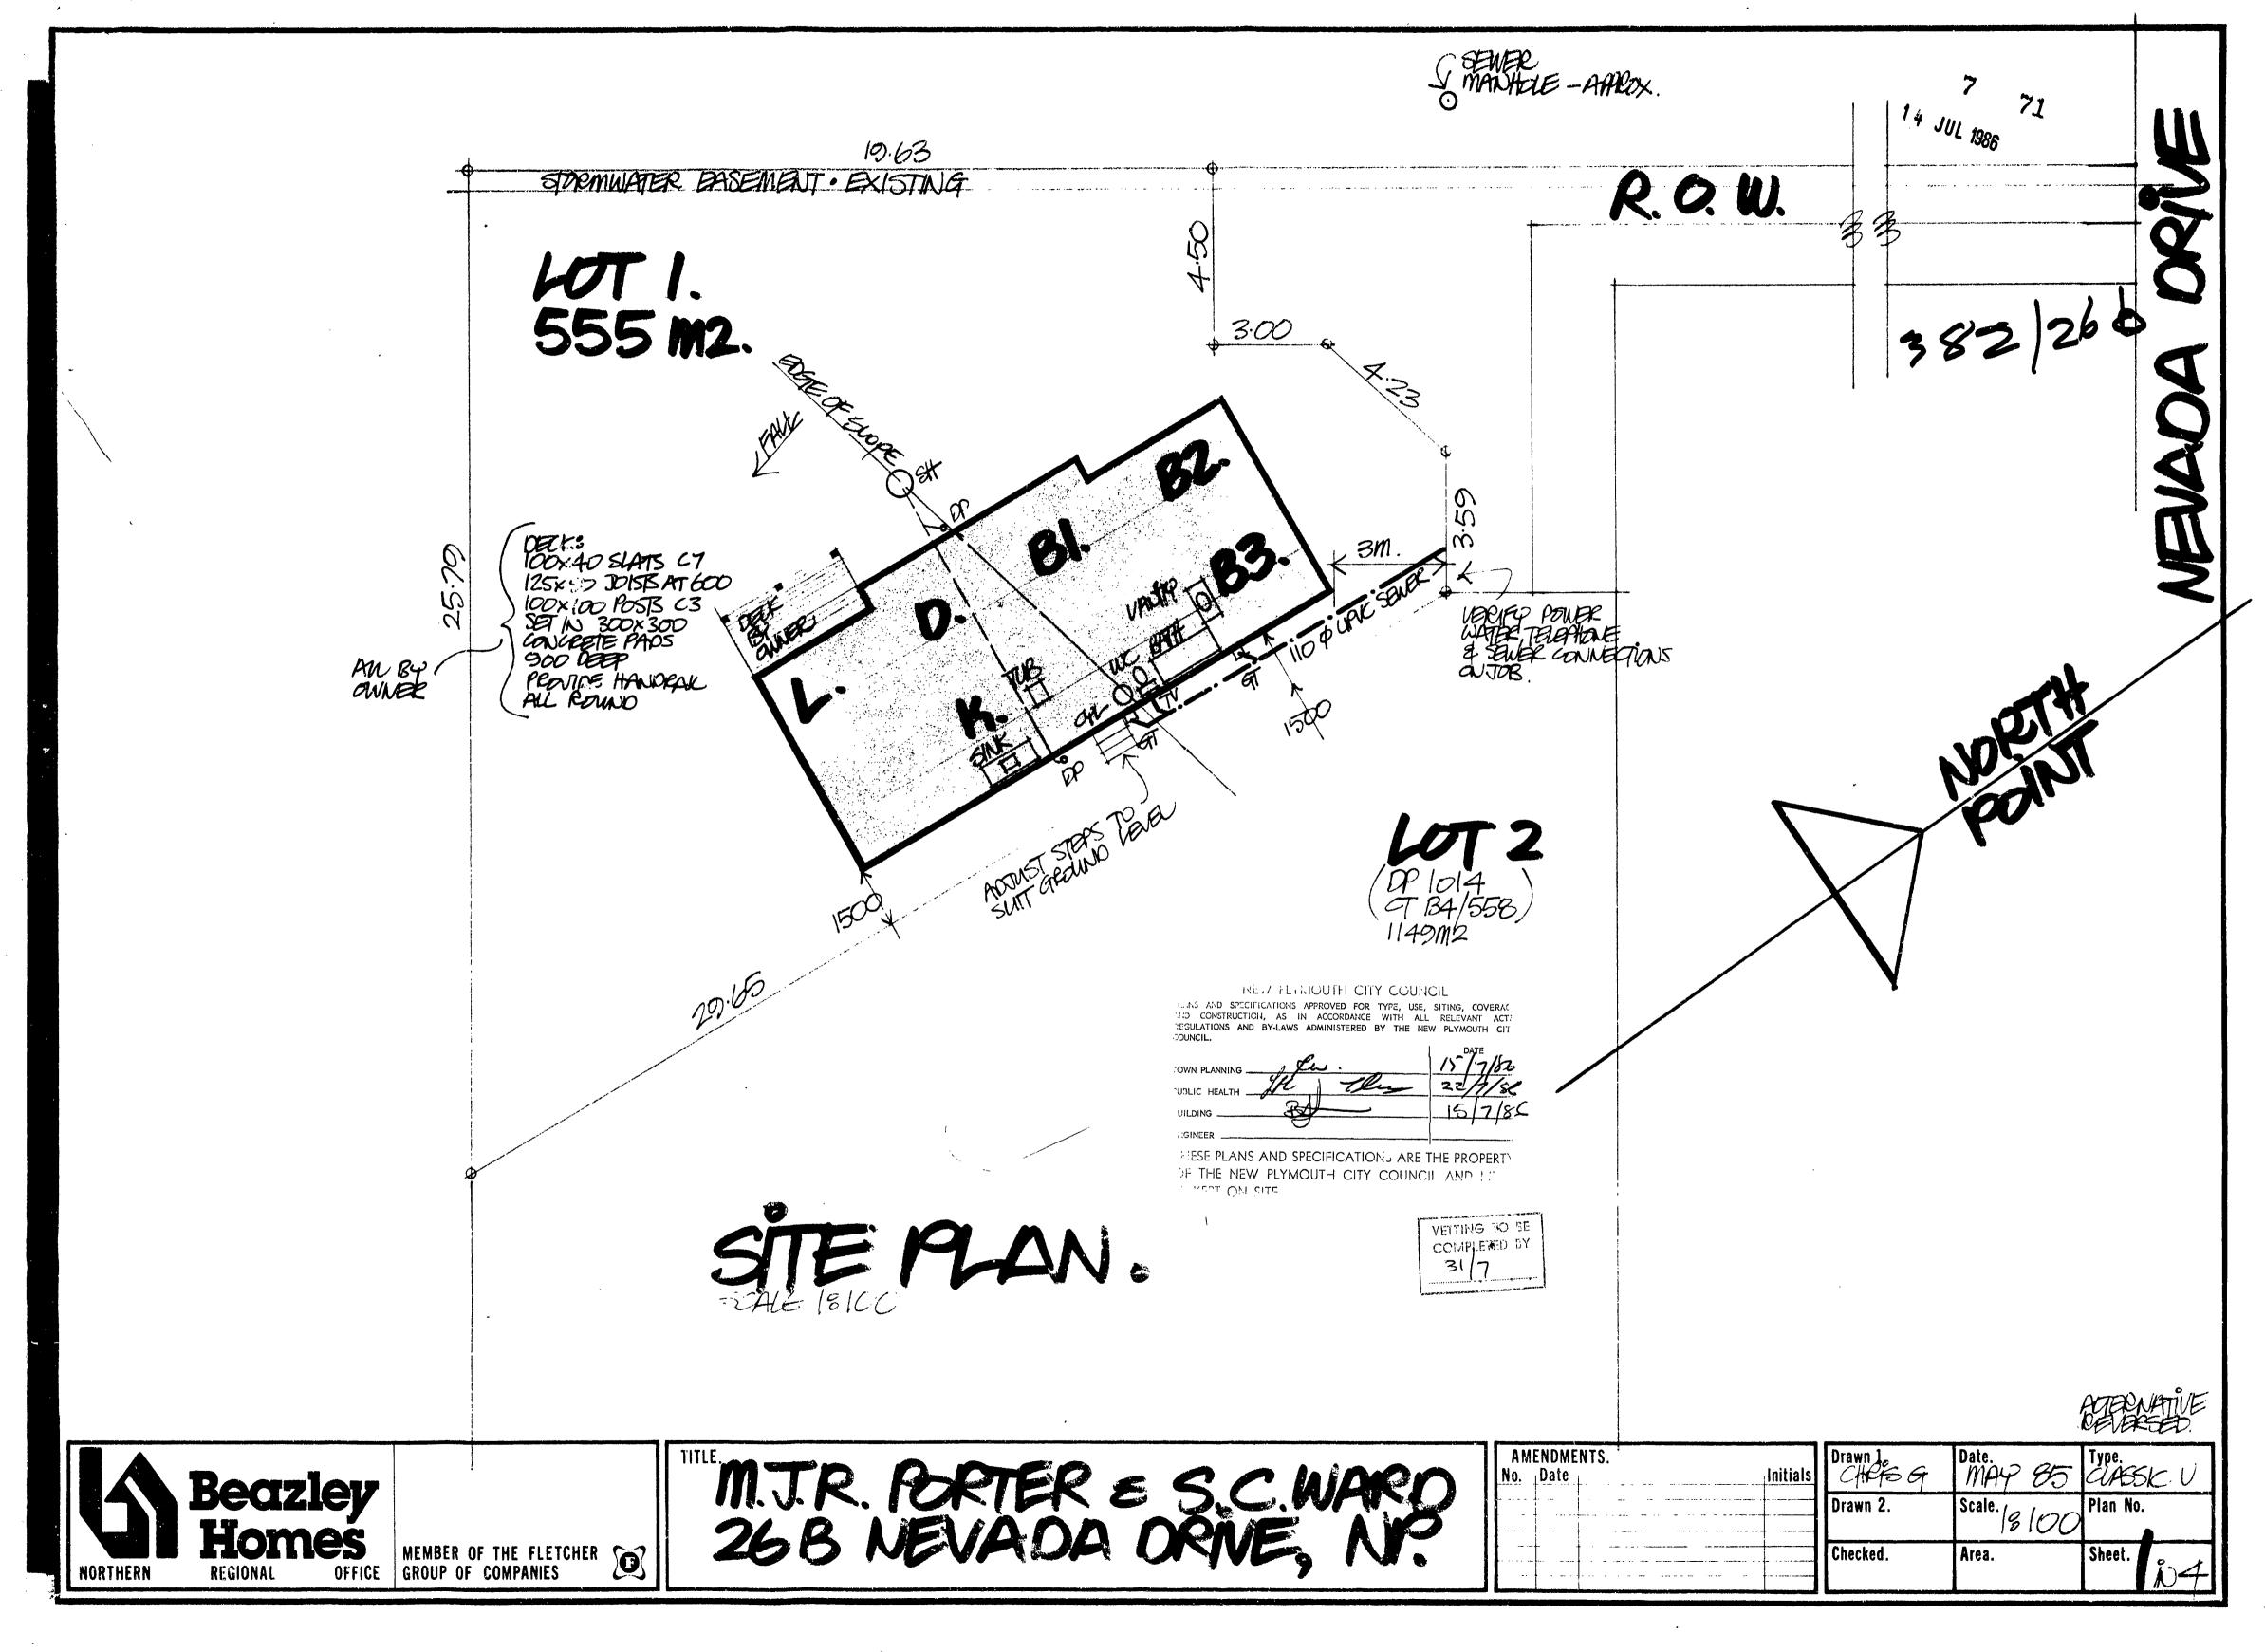

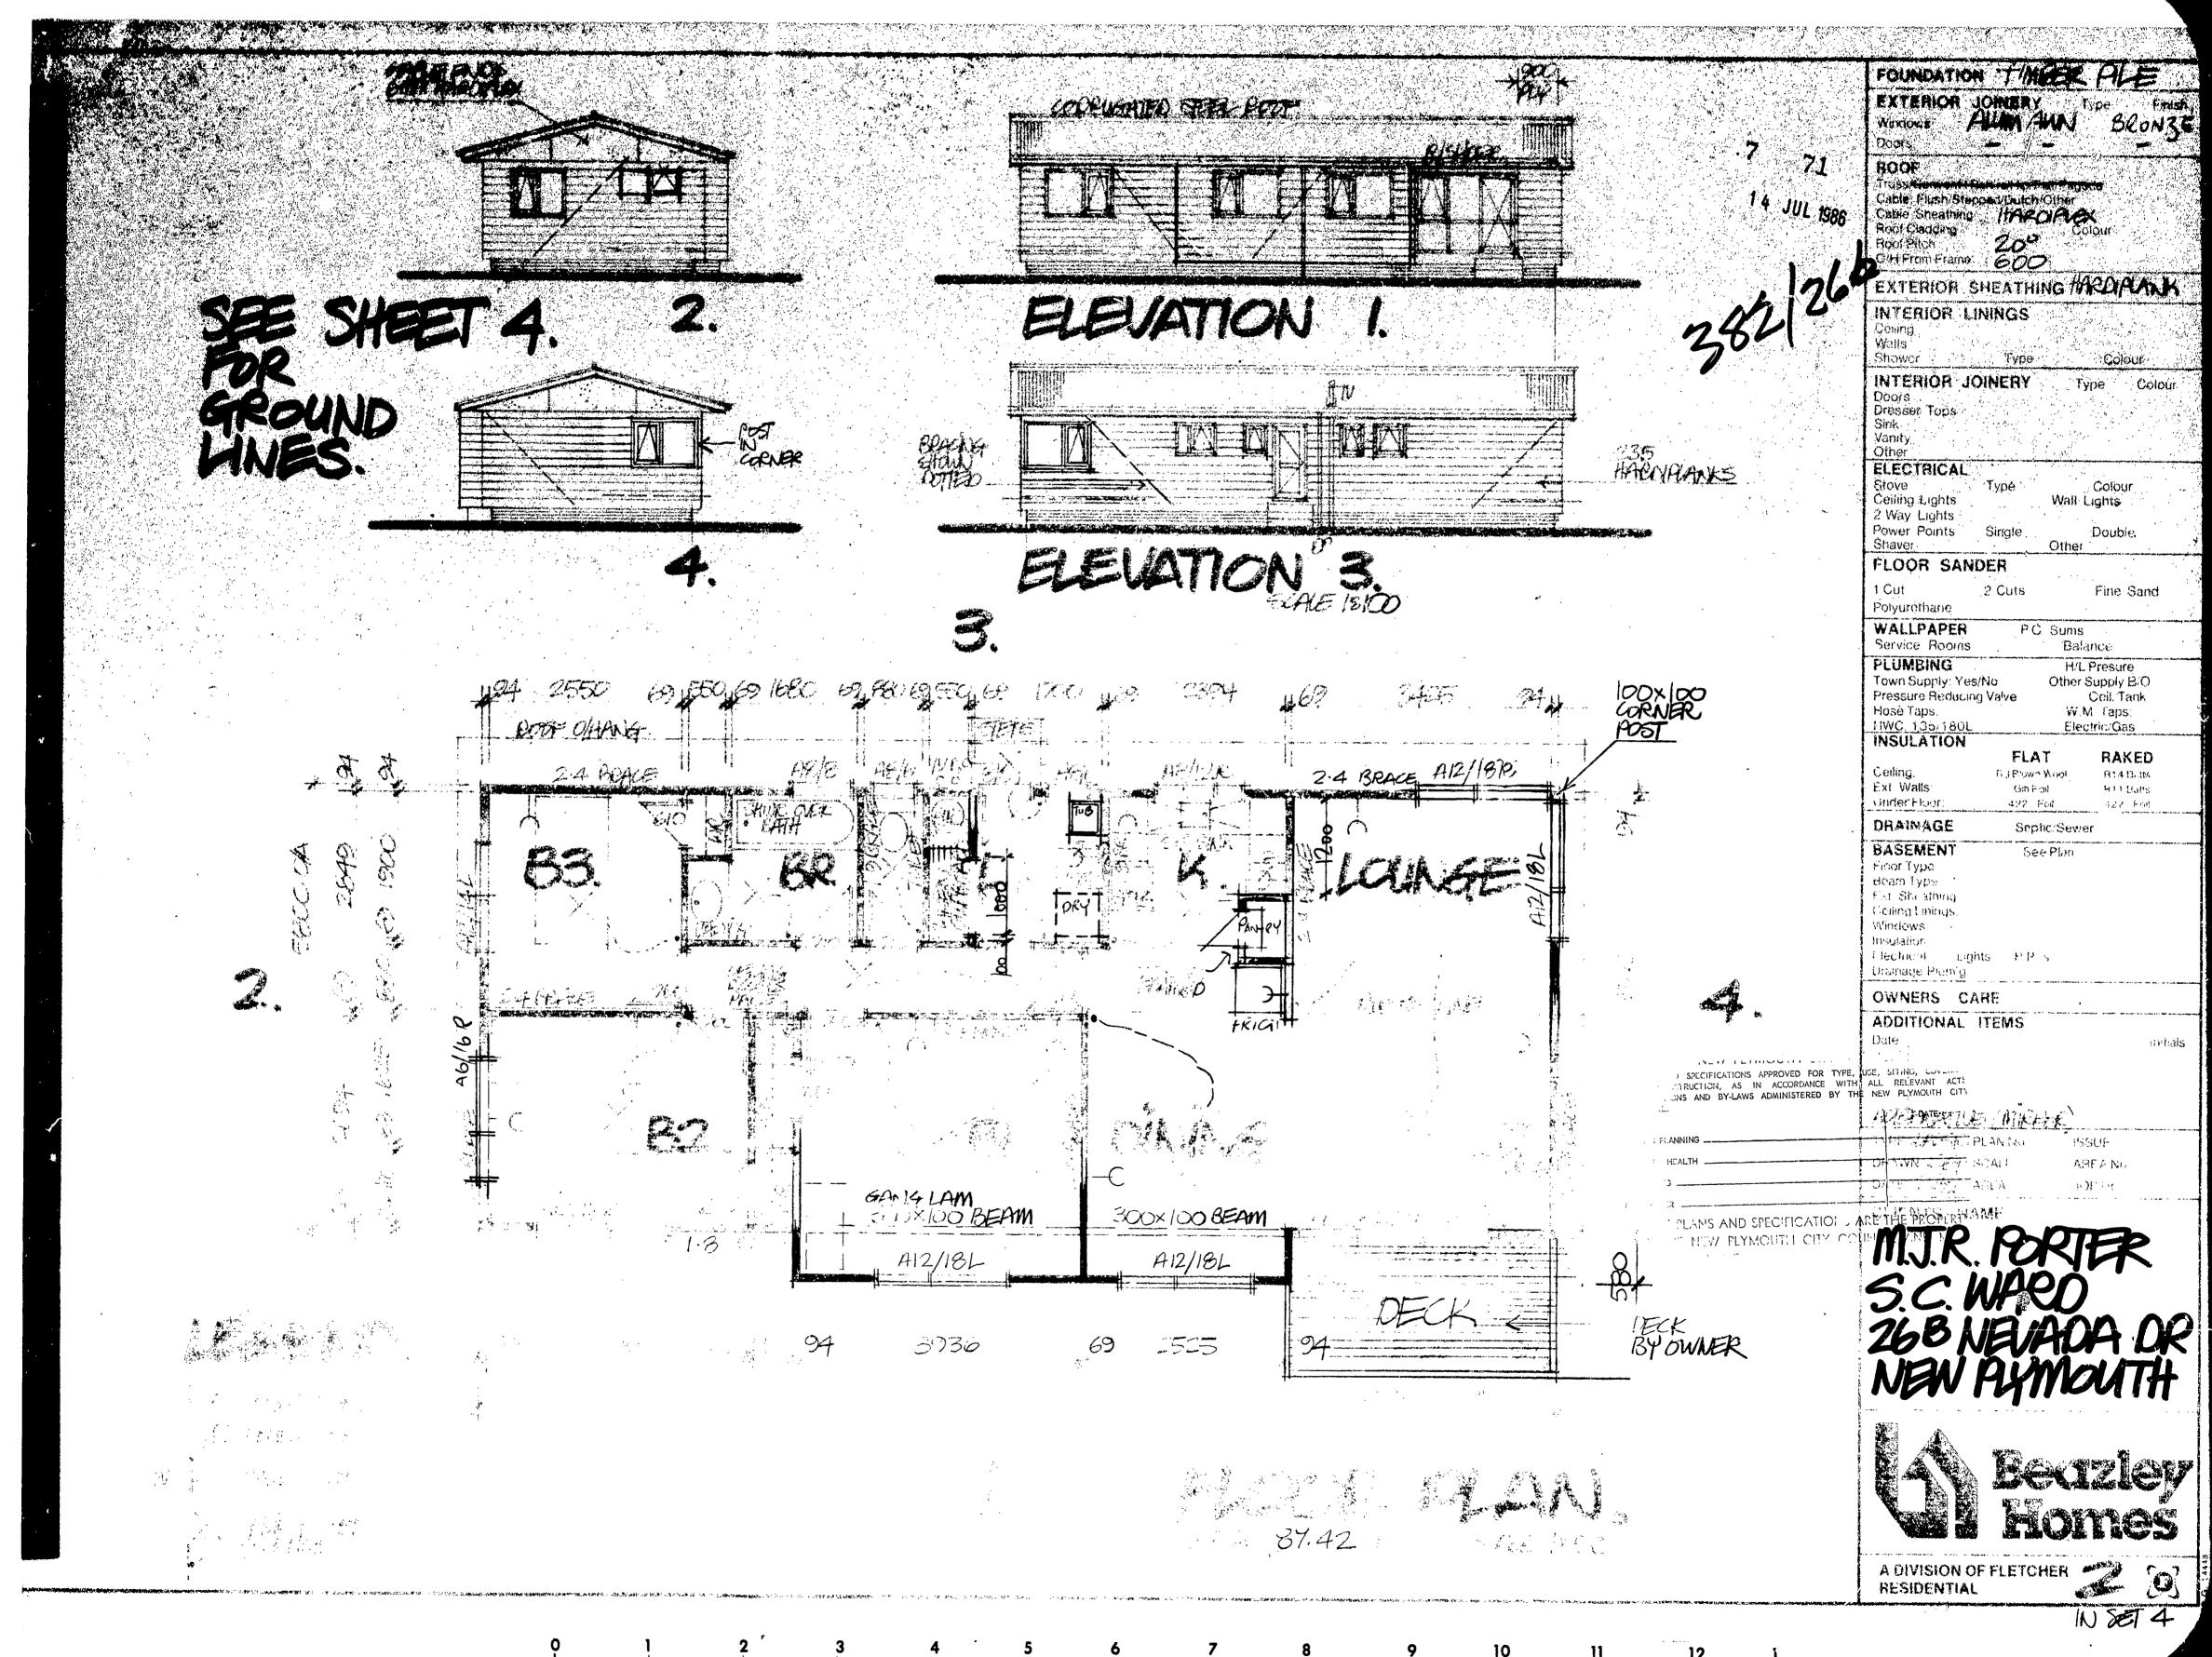

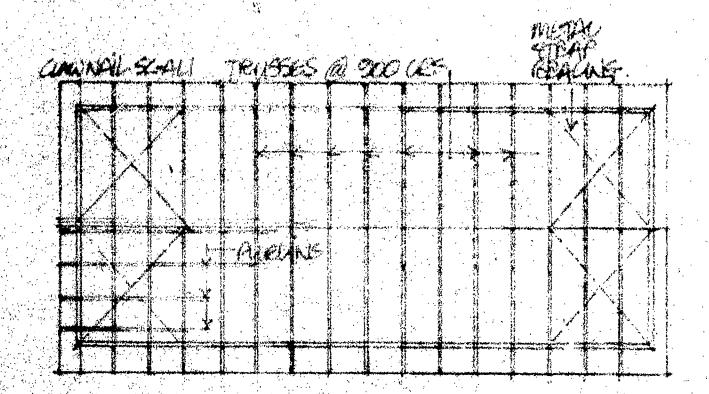


PCCE FROWNG PLAN.

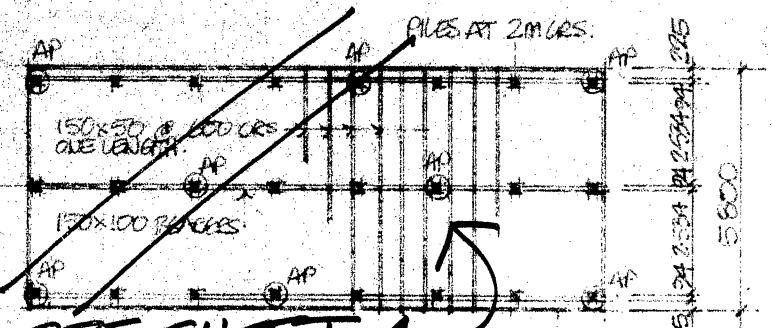


PISED FOUNDATIONS REPREMING PLAN.

126 y 125 C28 TANAGUES SET ON LONGETTE VANS DE ANOSIDE PLES AS STOWN. SEE CETAL. 数据器 影像 第 10 智度 1 PRO (Line) Etherick)

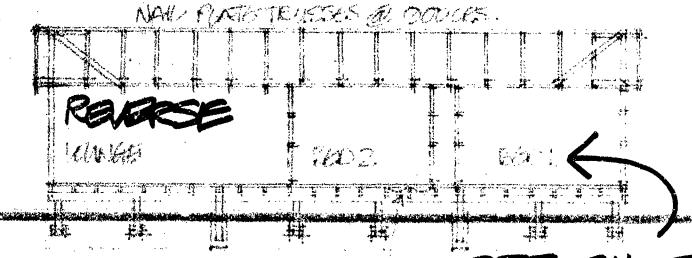

SEE SHEET 4 for foundations.
SECTION

SHEET AS REVERSE PLAN! SAR SHEETS

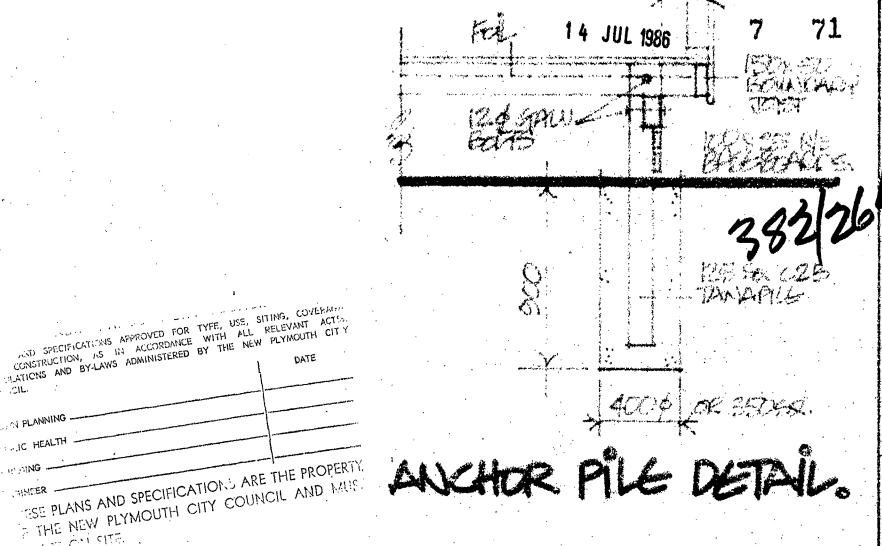


ANCHOR PILE DETAIL.

GOVERNATION SUMMARY.

DAOBIT CORR GAMU TREAL ROOF AT LO FIRST LIGHT WEIGHT DUKEND BUILDING PAPER 20 TO VITTO PHOLIUS AT SOO MAN CONTRES. NAV PLACE THUSSES SCALL AT 900 MAN SENTRES. PIECE GLASS KATT CELLING & WHALL WELLATION SUMM PATICLE BOARD FLOURING IN LARGE SHEET FOR FLORE OTHER MEDICAS IN ONE WHATH 1900 BARES AS HOW PERHAPATER FOR UNITERFORE INSULATION PROCESSION ISONOMI.

HAVE MUTILBEBLARIES ON BUILDING PAVER. KOVED & 15×90 WARD FRAMING AIRBO! WARD UNING HAMPER SOFFITE 150x 25 FARCIA/BARGE BOARLES MARLOY FULL SPORTING AND PLAINTINGS

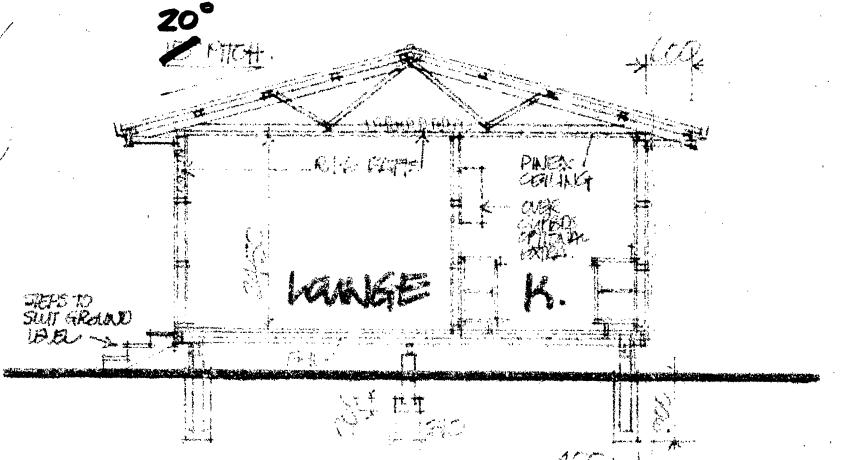

BRACING CALCULATIONS:-

STOREY SAULT

RoofType 1.15 RoofPyth 125*/45*

Earthquake Zone Root of Sulding Longth Post or Building Width: Gross Hoot or Plan Faithguake: BU's Mong & Across

Wind BU's Along Wind: BUTS Across

	Min B.U.S.	j\n.	Type	8 U Bating .	Length (U e diven
A				A solly	2.4	
8	7.	3	2.	62	2.0	124
C	144	4	* *	42	2.4	10.8
D						

TOTAL MIN. 358 TOTAL 527 TOTAL BU S REQUIRED ALONG

Wall Line

	Min BU s	No.	Type	B U. Rating	Length.	B.U.'s Giver
1	56	6		42	24	1904
M			2	62	24	46€
N	المورية الموري	E	6		1.8	111.6
O		0		62	20	124
P	38	10		42	2.4	laose
	k. estatus in estatus	TOTAL	. MIN	316	TOTAL	54
		TOTAL	.B.U.	s REQUIRE	ACROS	475

ADDITIONAL ITEMS

Truss Rote

TYPE GALLES PLAN NO DRAWNES SCALE DATE NOT AREA


AREA NO JOB No.

CLIENTS NAME

26B NEVADA DR. NEW PLYMOUTH



ADIVISION OF FLETCHERS 140

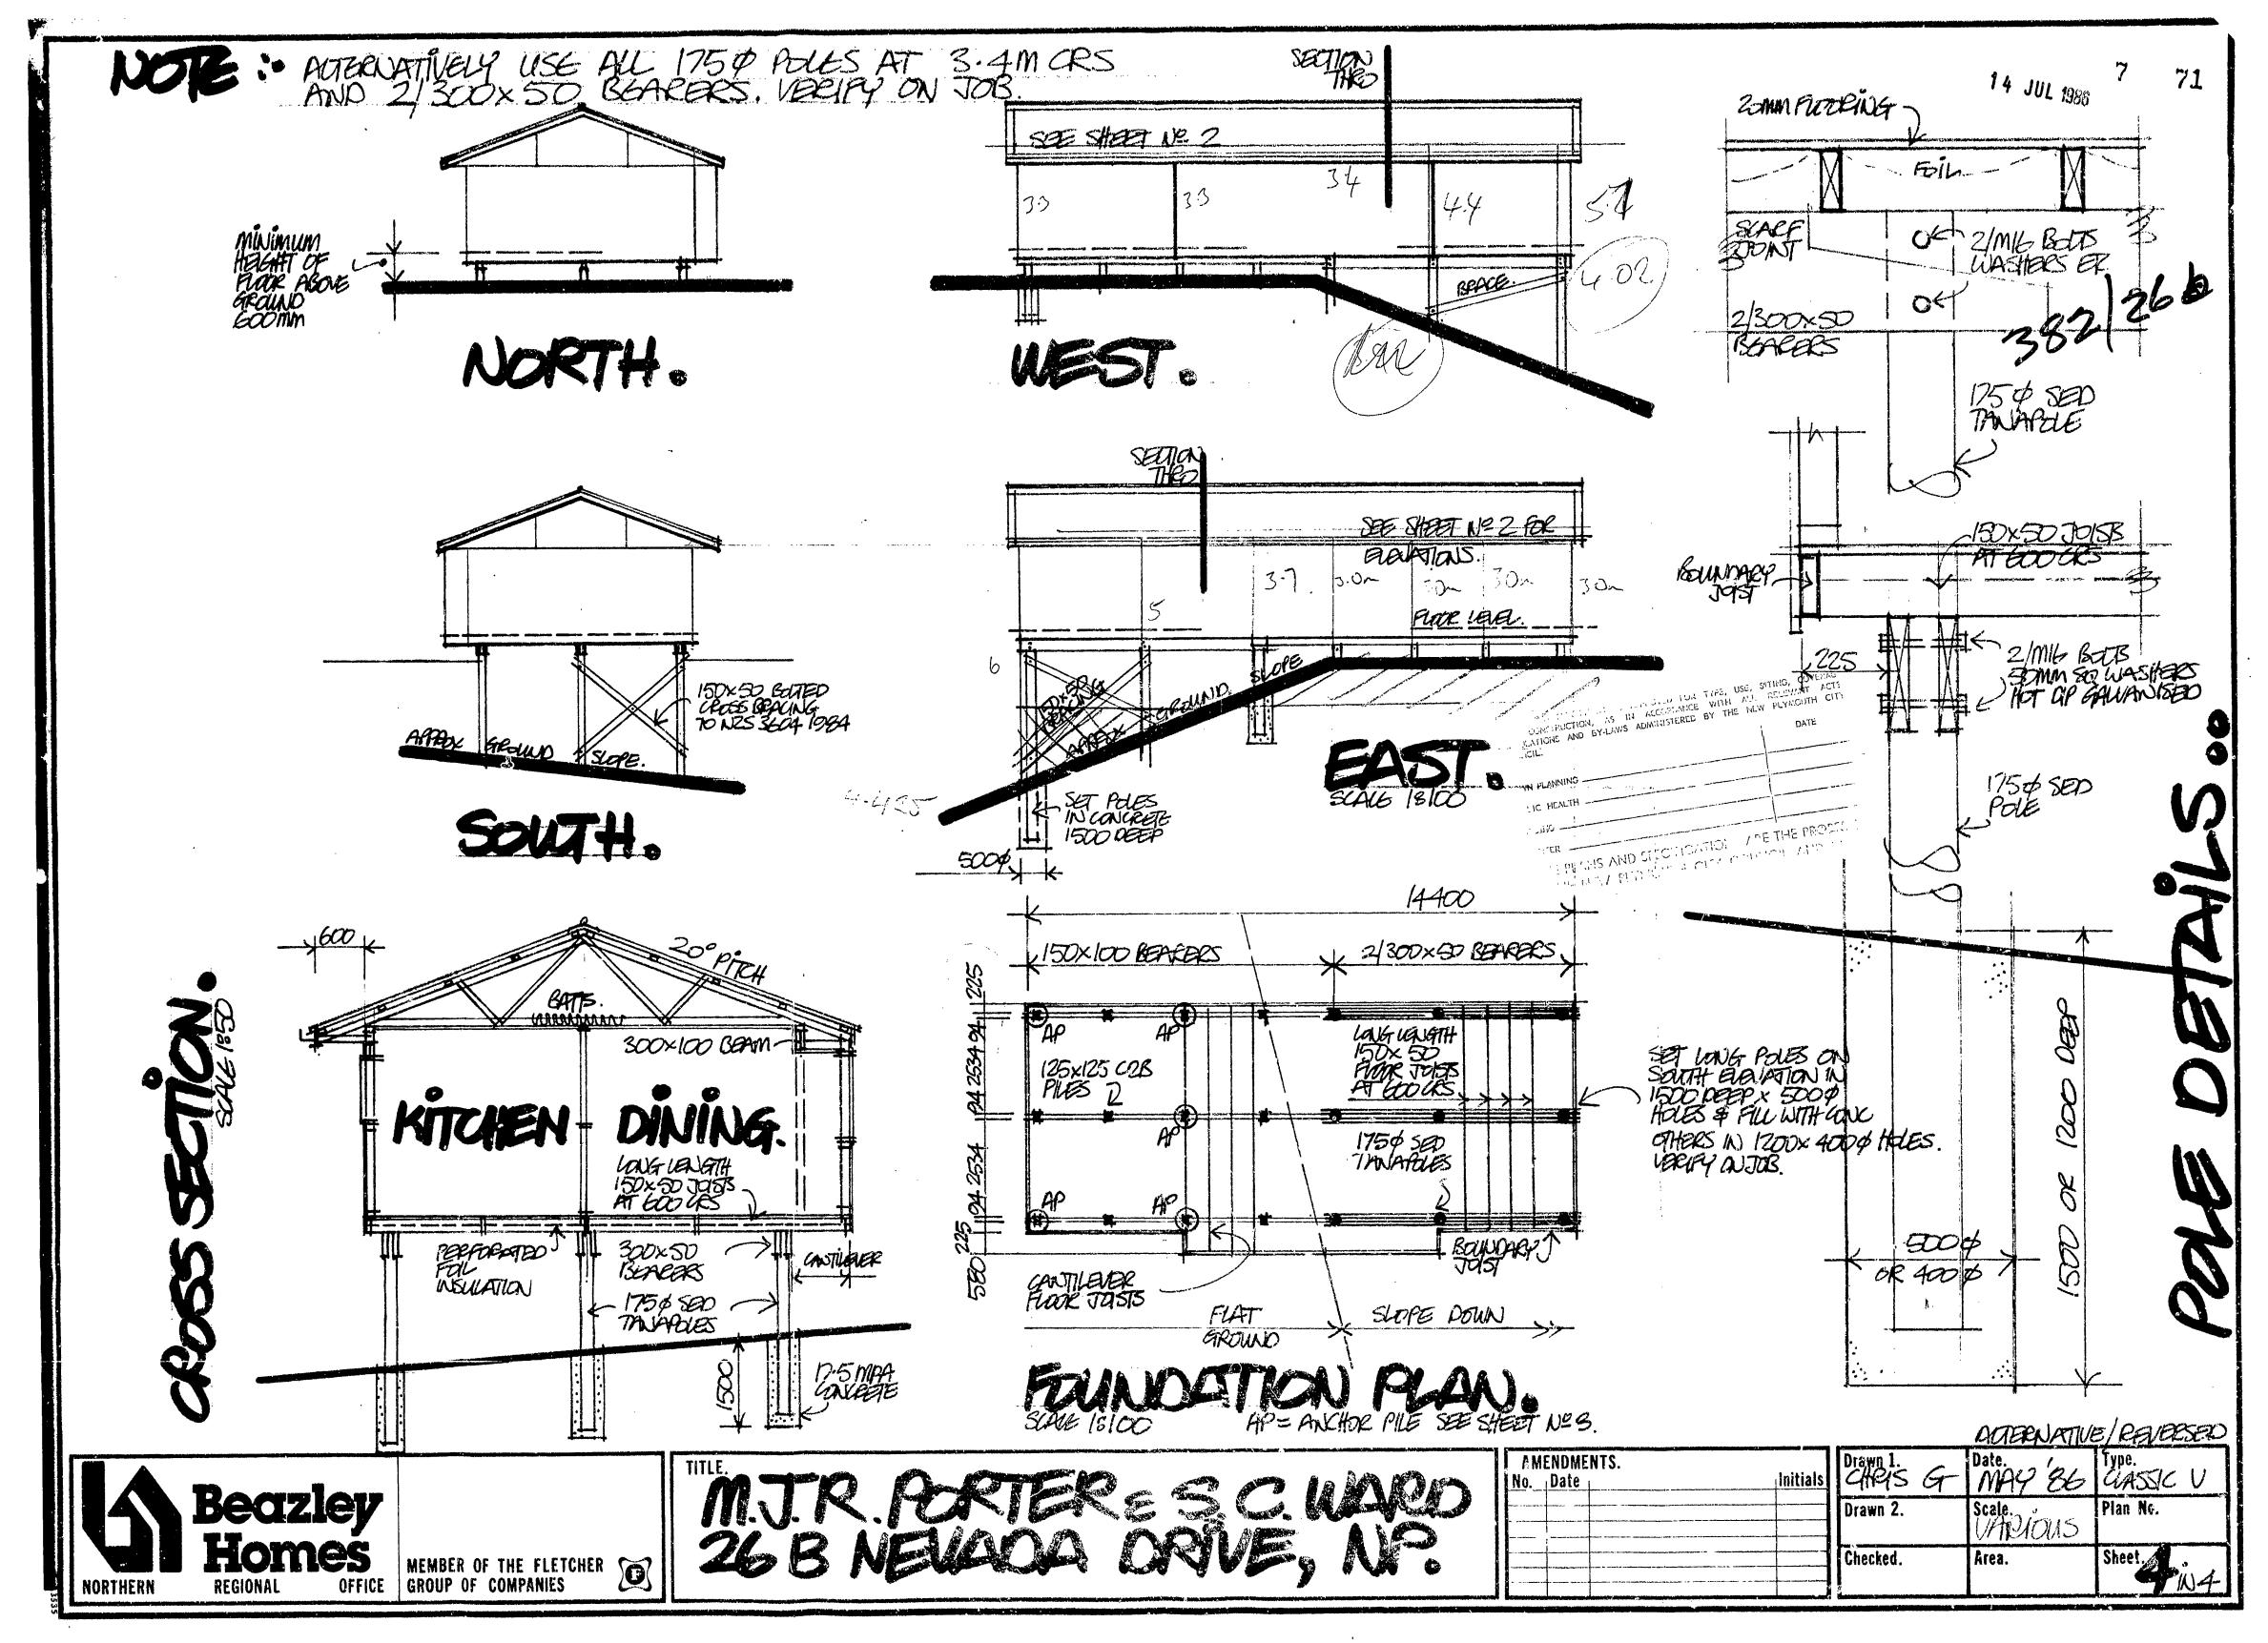

16 mm 35 mm

BUILDING FILE Code No. 382 / 268 Subject _ GARAGE No. Sheets _ Permit No 30134 Date 15.9.87

CITY ENGINEER'S DEPARTMENT

ASSESSED REQUIREMENTS

			File No	9 67
Project: CARAC	? №	Check Sheet No	30134	XX
Owner JR PORTER	QC WARD	Sower Sheet No	123 A Plotted	(II)
Address: 268 NEU	IANA DR	7000:	Do RI	*/
Lot No D.P.	15452	Con No	Area of Site:	
Lot wo		_ 380. 100	· Valting 12 F	
			COMPLEMED BY	
TOWN PLANNING			27/9	
Designations				
Area of Buildings				
Coverage				Į.
Meximum height				1
Front Yard				i i
Relat. of Bldg. Size: (
ΰρεπ Spacs				
Grassed Areas				i i
Trees				1
Building Lines & Street	-			\
Parking				1
Access to Rear of Site.				<u>I</u>
Accessory Buildings				
Service Lanes & R.O.W				
Crossing Length				
Gross Floor Area of Sho	/ps			
Resid. Accom	SEE SECTION	JN CARD		
Levels of Site	TOWN PLANNING			
Jse of Yards	BUILDING			
Loading	DRAMAGE			
Screening	WATER	SEWER		
Amalgam. of Titles[Semarks:	WALEH			_ _ _
Remarks:	"MUSEUM"			,
Subid 1860 - 5/64	IT The terms of a sec-			<u>,</u>
		<u> </u>		_
			Approved	Les
			Not Approved	
			, ,	

S E R V I C E S

A: SEWER CONNECTION	STORMWATER CONNECTION
Existing Service	
Required Service	
Location	gal and gard state and some some some state of the off
Depth	
Special Requirement	والم المنافعة
Common Drain	المن المن المن المن المن المن المن المن
Fee \$	Fee \$
	FEE \$:
B: WATER CONNECTION	
Existing Service	
-	Height above Datum
Distance: Main to Boundary	J
Boundary to Load	
Required Service	
Weter	
	FEE \$
C: PLUMBING	
3 2 1	2 2 2
to. Fittings W.CsBathsBasinsS	inks Shower:TubsOthers
Total Values	
	V.C. Copper Gal. Iron
Backflow Frev	
Other Fittings	
Istimated Value	Plumbing Fee
DRAINASE	
Existing Required_	
ittings Required	
Cormon urein	
itormwater	Droinnes Sec
POINTER ASTRET T T T T T T T T T T T T T T T T T T	Drainage Fee
Total Estimated Value P. & D. \$:	FEE \$
D: VEHICULAR CROSSINGS	lional
a to the latest and t	
ype of Fcotpath Condition.	2000
	Inst. No
erb & Channel xisting Crossing I food	Inst. No
erb & Channel xisting Crossing I food	Inst. No

REMARKS : CORRESPONDENCE : AGREEMENTS SPECIFIC REQUIREMENTS

Note: G.S.T. is to be excluded from all fees quoted in this Document.


	- 	1 Syndry	4 m	+ 54 (SA)		28/8/2	<u> </u>		Sto. 1, 1	s	>.~.<
<u></u>	Gar.	12 0 St	170	<u> </u>	<u>هُ .</u> ۳ خ ۸	zeloù Treditod Franc	730	St.	nemte,	2000	wall
											-
								Appro	ved		37/9
						· · · · · · · · · · · · · · · · · · ·	Not	Appro	ovéd===	1 - FEA	33
											
				· · · · · · · · · · · · · · · · · · ·							
									oved A		
			<u></u>				Not	Appro	oved		
								<u></u>			
											
									oved		
						1 \	⇒ Not	Appro	oved		
											
									·		
											
								Appro	ved _ Z	Rens	
		. —				<u></u>	= Not				
				·····							
											

E : HEALTH & BY-LAWS		
Areas		* *
Light		•
Ventilation		
Remarks:		
	7. True 11	
	Rec 24/a	· da
	Approved	HC 24/197_
	Not Approved.	
F: DANGEROUS GOODS		
Domestic or Commercial		
Storage Capacity & Location	•	
Licence Required Yes/No		
	Approved	
	Not Approved	
G : BUILDING		
Remarks:		
	FEES:	
		35.00
	Water Bldg.	<u> </u>
	B.R.L.	i
	TOTAL	\$ 35.00
		MA A CO
Building Inspector		18G18-87_
	Not Approved_	
Specification:		
Structural Engineer	A	•
The state of the s	Not Approved_	
Fire Service		
	Not Recommended	
	//	
PERMIT NO. 29213	Mer	Sall
	Approved_	707-
APPROVING ENGINEER	Not Approved 3	0/7/8/
		, ,

FOR OFFICE USE:	File No	766	- 88	Check Sheet No. 123 fl. Sewer Sheet No. 21	4
	MIND		. 70 7040	Date 15 9 5 SEP O.P. 1014 ADDRESS: Mon	; ;387-
NAME OF OWNER O	OF BUILDING: MUM	Crokiek	r. 54 xv.c.4	ADDRESS:	
PROPOSED USE OF		x 51320		ADDRESS: 5 Regard	
For Permission To	Buld by	ruge	I	Documents: attached as part of this application which are applicable:	,
			(Drawings - Two sets See notes on back of sheet)	
				Specifications - Two copies	
			······ 1	Form No. 2 - Structural Design Features Summary Part A and Part B	0
				Form No. 3 - Fire and Egress Features Summary	
DESCRIPTION OF I	POPOSED WORK:			Building Project Authority	
New building	E Conversion		ı	Estimated starting date	
Addition Alteration Hoardings	☐ Den:olition ☐ Mths			Estimated completion date	
New floor area3	2 112	. 4-40	0-00	FOR OFFICE USE Corrected Value	
Total Value of Building	ng Excluding G.S.T.	\$ 500	0-00	CONTOUR	
Sanitary Plumbing an (Ex	d Drainage (Labour on cluding G.S.T.)	ly) \$ ———			
Value of Building for	Permit	\$			
NAME OF APPLICATION Address	Buller		elephone No	5/3206 . (e.g. owner, builder, principal co	onsultant

UILDING INSP IELD SHEET	'ECTOR'S			AUTHO	RITY	Stats	. No. E . 02	9213
			NEW PLYM	OUTH CIT	Y COUNCII		_ No. <u>65</u> 3	30134
spector: M	766		File No	9/6	<u> 7/87 </u>		·	. 00
Receipt No						Date Per	mit Issued	1,88
		770	C King		PUILDER	- / \	~ .	
a	***			Nar	ne		STUN	
lailing Address	LE NO	FUNDA	1)R	Mai	ling Address	, Kiec	FINT /	LAKE
	<u>Ceul</u>	1 - time	1-171-	,	v t	C)Fuc	Permo	CITH
					5132d	0		
PRO	PERTY ON V	VHICH BUILE	DING IS TO BE	ERECTED	DEMOLISHE	 D		
SITE					LEGAL	ESCRIPTION	•	
treet No.	He t	NE OWE	-	Vale	uation Roll No			
treet Name					{	D.B.	1545	2
								l
own/District		,		Sec	tion		Block	
Riding					vey District			
DESCRI		POSED WORK	AND MAIN PUR	POSE OF US		1, AE. /	()	
	<u> </u>					NOFAL.	101 -	Ì
FLOOR	ABSA	DWG14A	G UNITS					
	=,2_	Number	IG UNITS	N	ATURE OF PER		·	
q. Metres		Erected			 1	• •	domestic outbuildings	
TITTLE	Building) _	ESC 23	<u> </u>		FOUNDATIO			
Timated Values	Plumbing					installation of heating	, CONVERTED, RESITED appliances	ĺ
\$	Drainage				MEW CONST	TRUCTION N BUILDINGS inclui	le demolitions	
٠. ــــ ٠	TOTAL			\	DOMESTIC (GARAGES STIC OUTBUILDINGS		J
FEES AF	PPLICABLE							
Building Permit			nnection		S		· · · · · · · · · · · · · · · · · · ·	
Street Damage De Building Rusearch I			rossing Levy		Receipt No	nt	1122	
Plumbing Drainage				\$ \$	Date of Payme	nt/_	1 / 03 03	
Sewer Connection		<u> </u>	TOTAL:	•	Authorised Offi	icer <u>///</u>	معضارير	
ecial Condition	is:	· · · · · · · · · · · · · · · · · · ·				 		
								
							·	
			· · · · · · · · · · · · · · · · · · ·	·				
								
				··				
				· · · · · · · · · · · · · · · · · · ·				
								
Inspected	REMARKS (e.g. stage rea	ched with wor	k)				
3 88	Jacti.	es 7	Jug	gleun	o Fia	٧		
3-88	STEEL	Dr o	cko u	15	TIRO 3	Jan	ns ok	TA !
	1						2	
4.88	THOCK	Insm	- 576	the with	ELL TIPO	OK	TO FORM	UED OVER)


- 3 · 88	TRAMING	In	ROGIAN	, , , , , , , , , , , , , , , , , , ,	DOKE TIS	щ	
	Francing Bracing	ok	Dyna	bonses	Down	at.	
0/6/88	Cony	eleter					
							
-		<u> </u>					
	<u> </u>						
			<u></u>		· · · · · · · · · · · · · · · · · · ·		
			-			<u></u>	
							
	ļ						
	į						
				V			
						·	

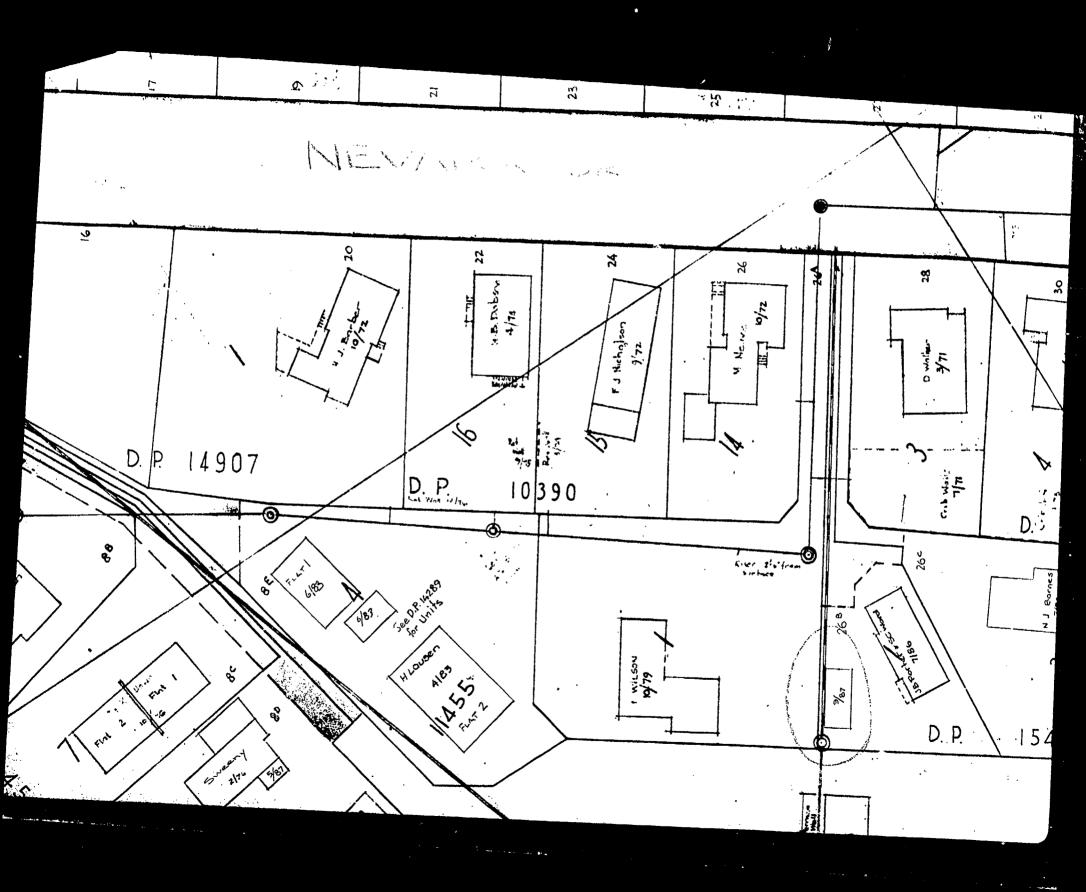


16mm 35mm

BUILDINGFILE Code No. 382 / 268 Subject Sarre No. Sheets 2 Permit No 30134

Date __15.9.87

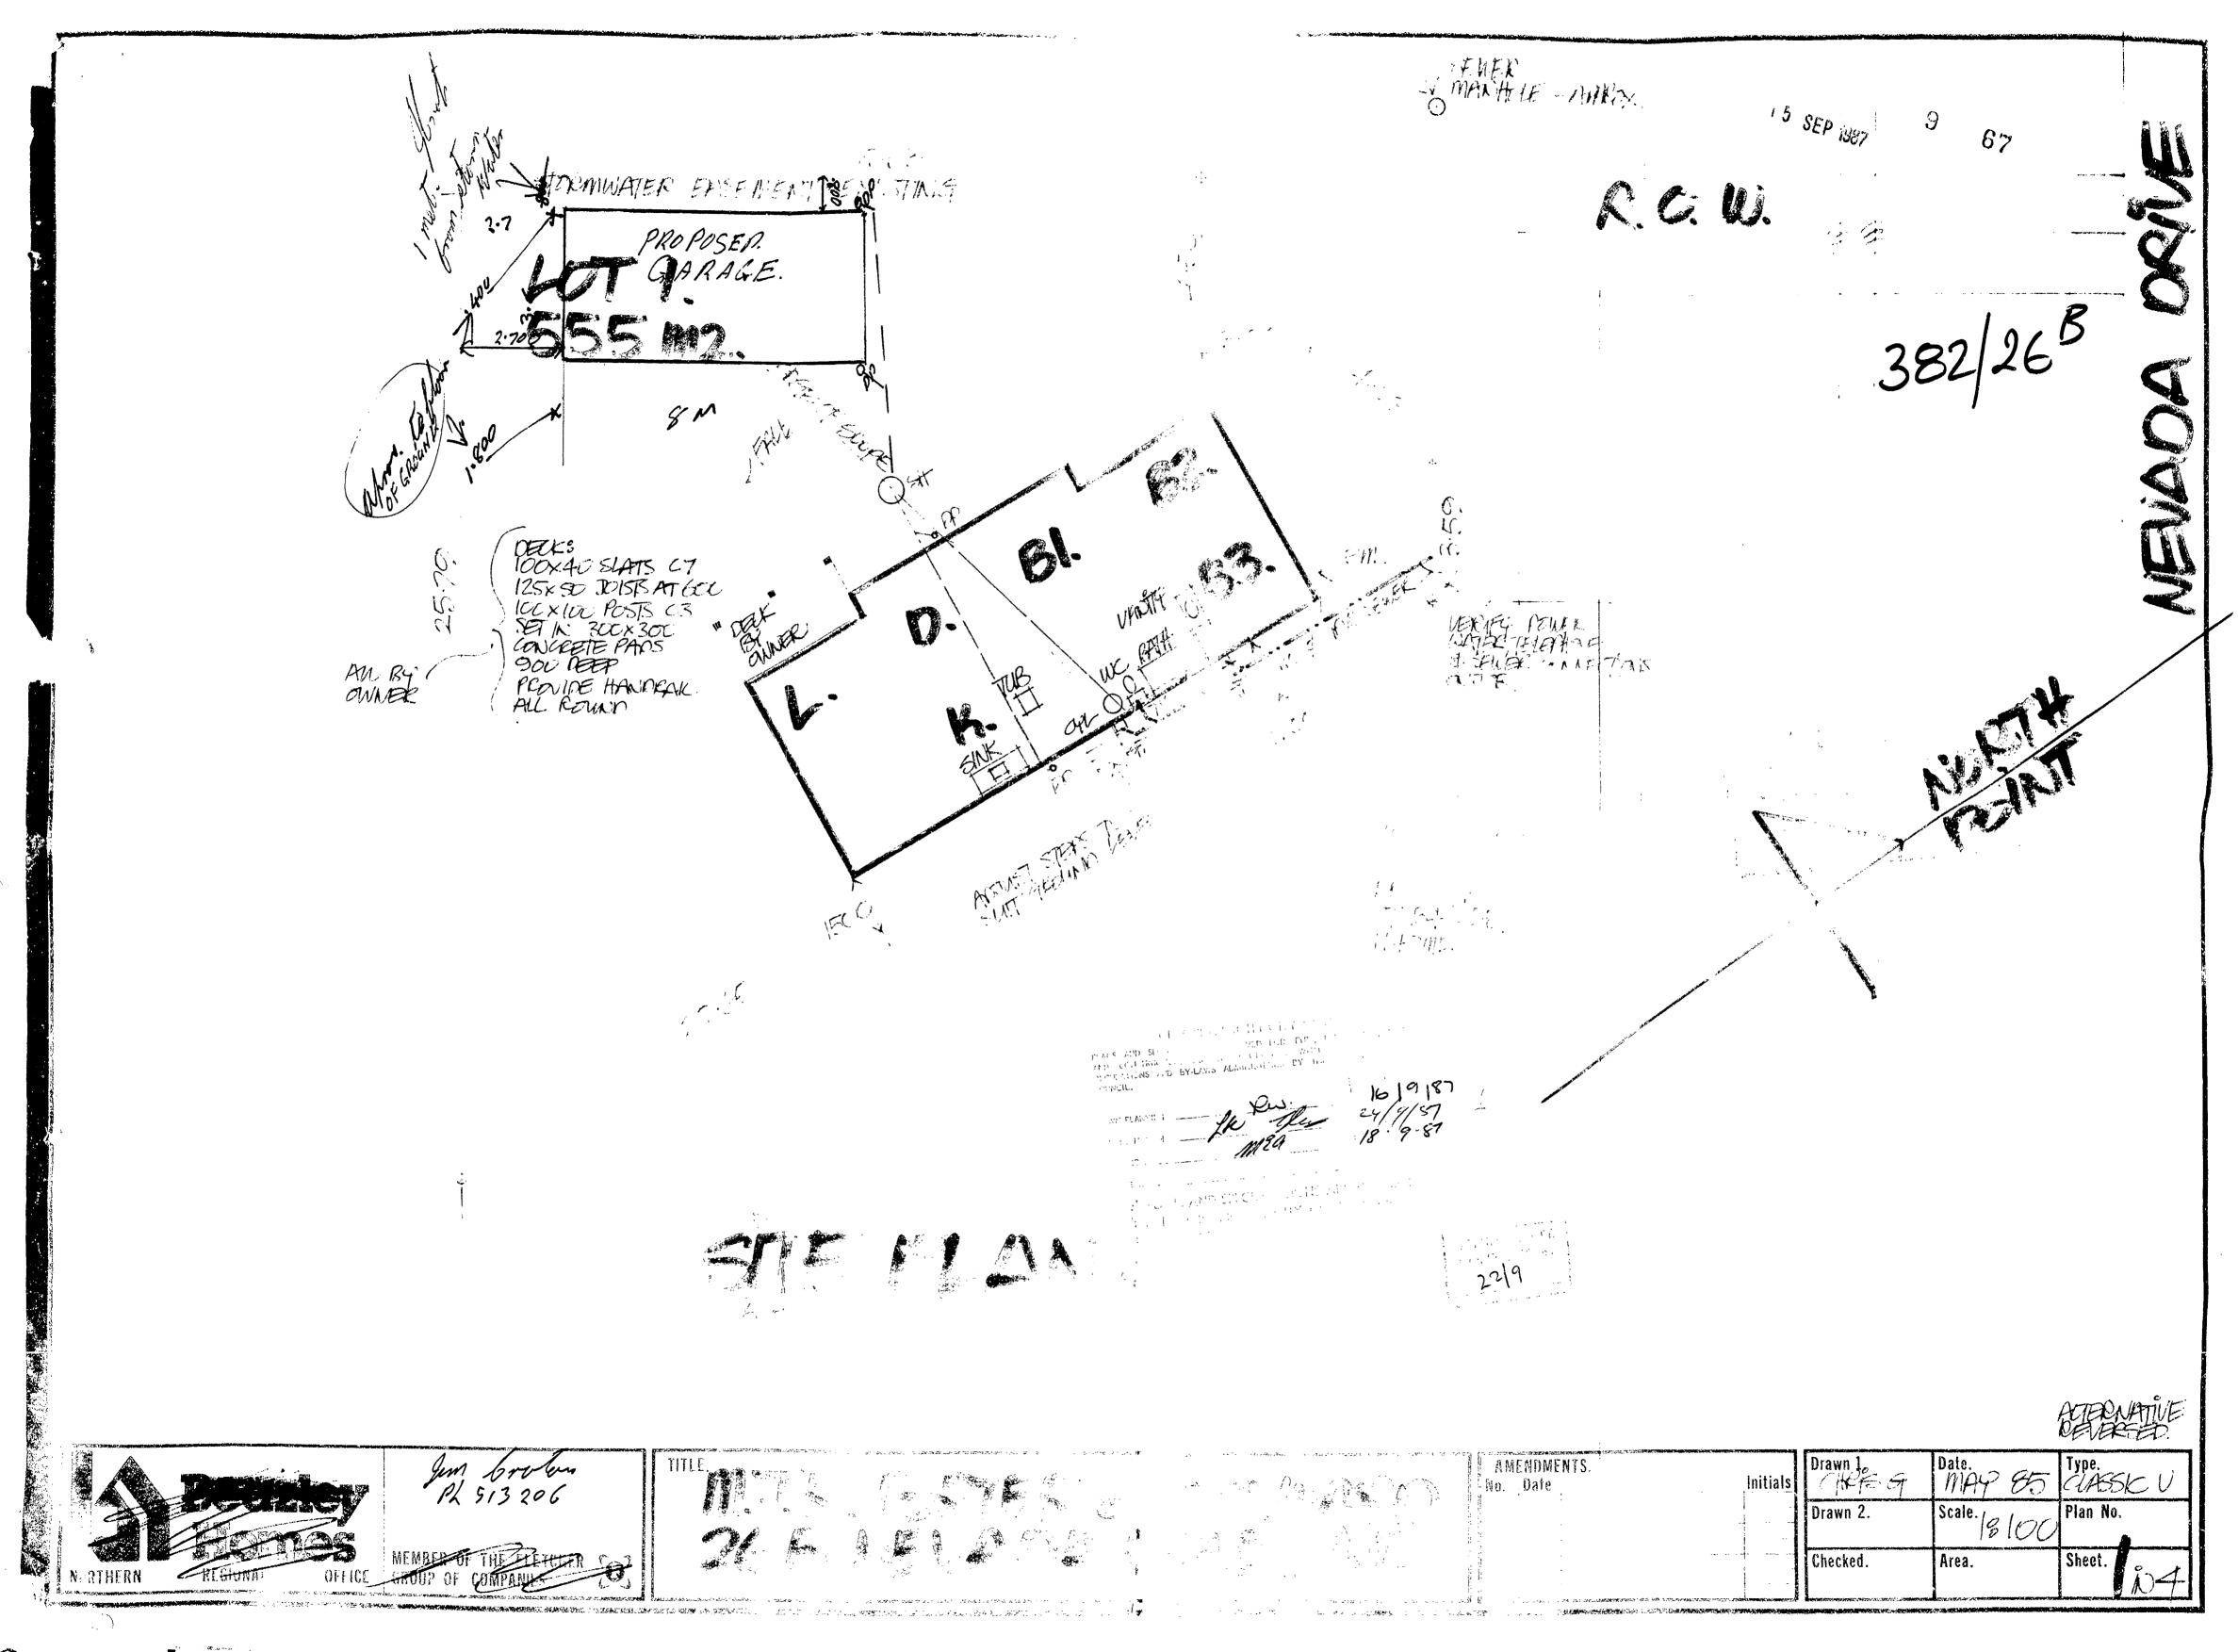

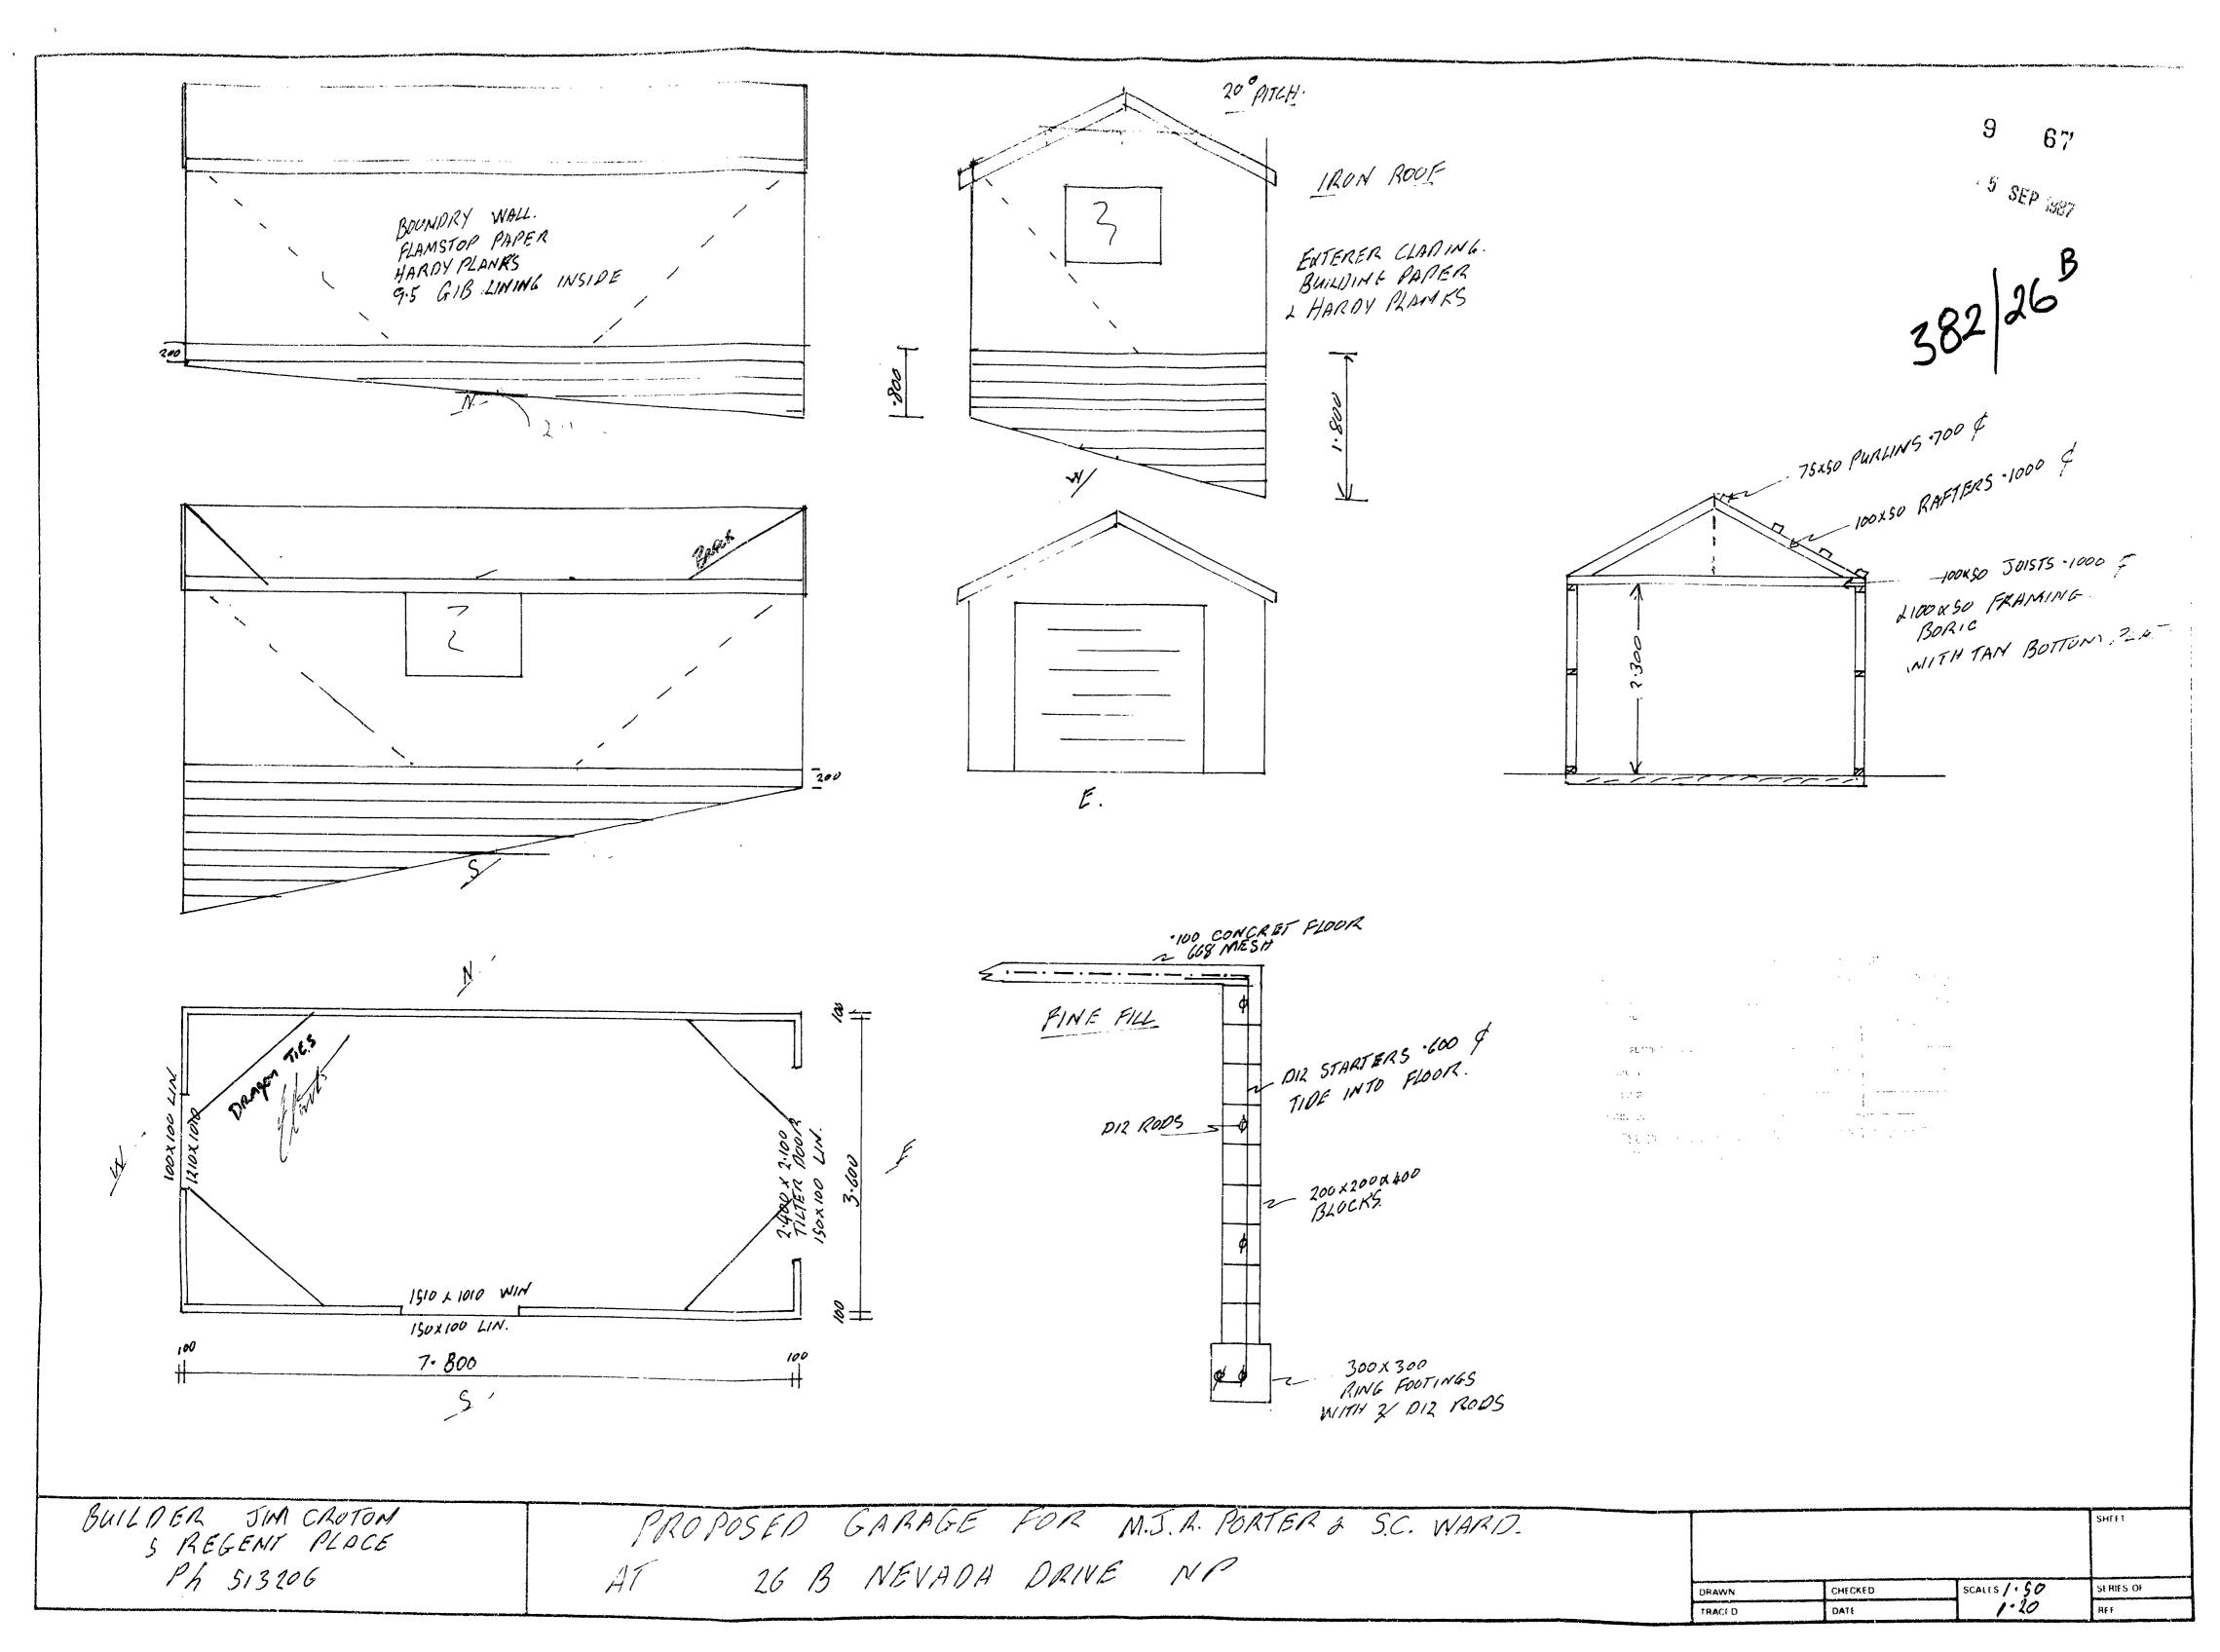

PLANS BC17/121306

Prepared by: TF

BATHROOM ALTERATION FOR **WILSON RESIDENCE**

26c Nevada Drive, New Plymouth

Job No: 5931 February 2017

Consent Issue



This Building Consent is approved under the Building Act and is finited to new work only as shown on these plans and related specifications

BC17/12/306 13/2/17

NPDC Approved for 03 MAR 2017 **Building Consent**

Drawing Index


SITE PLAN

DEMOLITION / PROPOSED FLOOR PLAN

SKYLIGHT DETAILS A3-1 -

CONSTRUCTION DETAILS



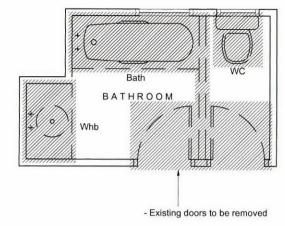

EXISTING / DEMOLITION PLAN

KEY:


Existing walls to remain To be removed

ready for new bathroom fitout, new fittings to be connected in to the existing gully trap, confirm location on site prior to

NOTE:

construction.

Disconnect services temporarily

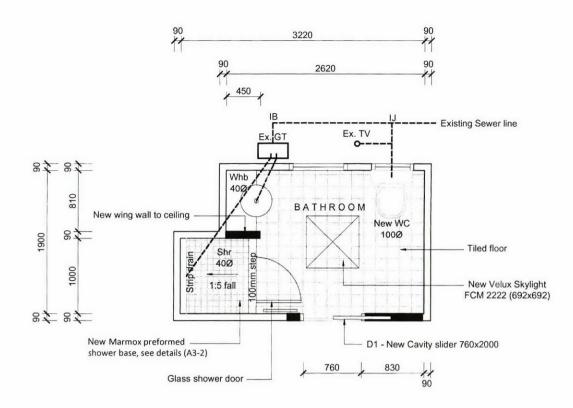

PROPOSED FLOOR PLAN Scale 1:50

Minimum Pipe Gradients

1:100

40Ø

100Ø

KEY

__ __ _ _ 100 Ø Sewer

PLUMBING & DRAINAGE KEY

IJ Inspection Junction

Toilet Pan WC

Whb Wash hand basin

TV Terminal vent

Shr Shower

Gully trap

AAV Air addmittance valve

PLUMBING & DRAINAGE NOTES

Foul Water Sanitary Plumbing shall comply with NZBC G13/AS1 & G13/AS2

Stormwater drainage shall comply with NZBC E1/AS1

Size all wastes & drains to comply with the above, lay all drains to acceptable falls

Water supply & reticulation shall comply with NZBC G12/AS1

All drains shall be pvc All water supply pipes shall be K2 piping

All plumbing and drainage shown as indicative

Plumber to confirm plumbing and drainage layout complying with the New Zealand Building Code

KEY:

WC.

Timber wall framing

Whb = Wash hand basin

= Toilet

Shr = Shower

Htr = Heated towel rail

> = Battery operated Smoke Alarm to be installed within 3m of all

sleeping areas Shower floor to have Marmox preformed tile over base.

Showers to have Gib Aqualine substrate and to be water proofed with "Superflex" or similar BRANZ approved water proofling system, Refer to "Superflex" Spec. attached.

Line bathroom wet areas with Gib Aqualine,

- -10mm Gib to walls
- -13mm ceilings

VENTING:

Mechanically vent shower directly to the outside with a proprietary ventilation ducting system and inline fan run through roof framing space out through wall or soffit



A Building Consent Issue 07.02.17

REVISION :

JOB TITLE :

Bathroom Alteration Wilson Residence 26c Nevada Drive New Plymouth



Ph.: (06) 769 5524 Fax: (06) 769 5525 Mob: 027 2100 564 Email: paul@4sitedesign.co.nz PO Box 569 495a Devon Street East New Plymouth


SCALE:


DRAWN: LK

DATE: February 2017


JOB No. : REVISION: A

SHEET No. :

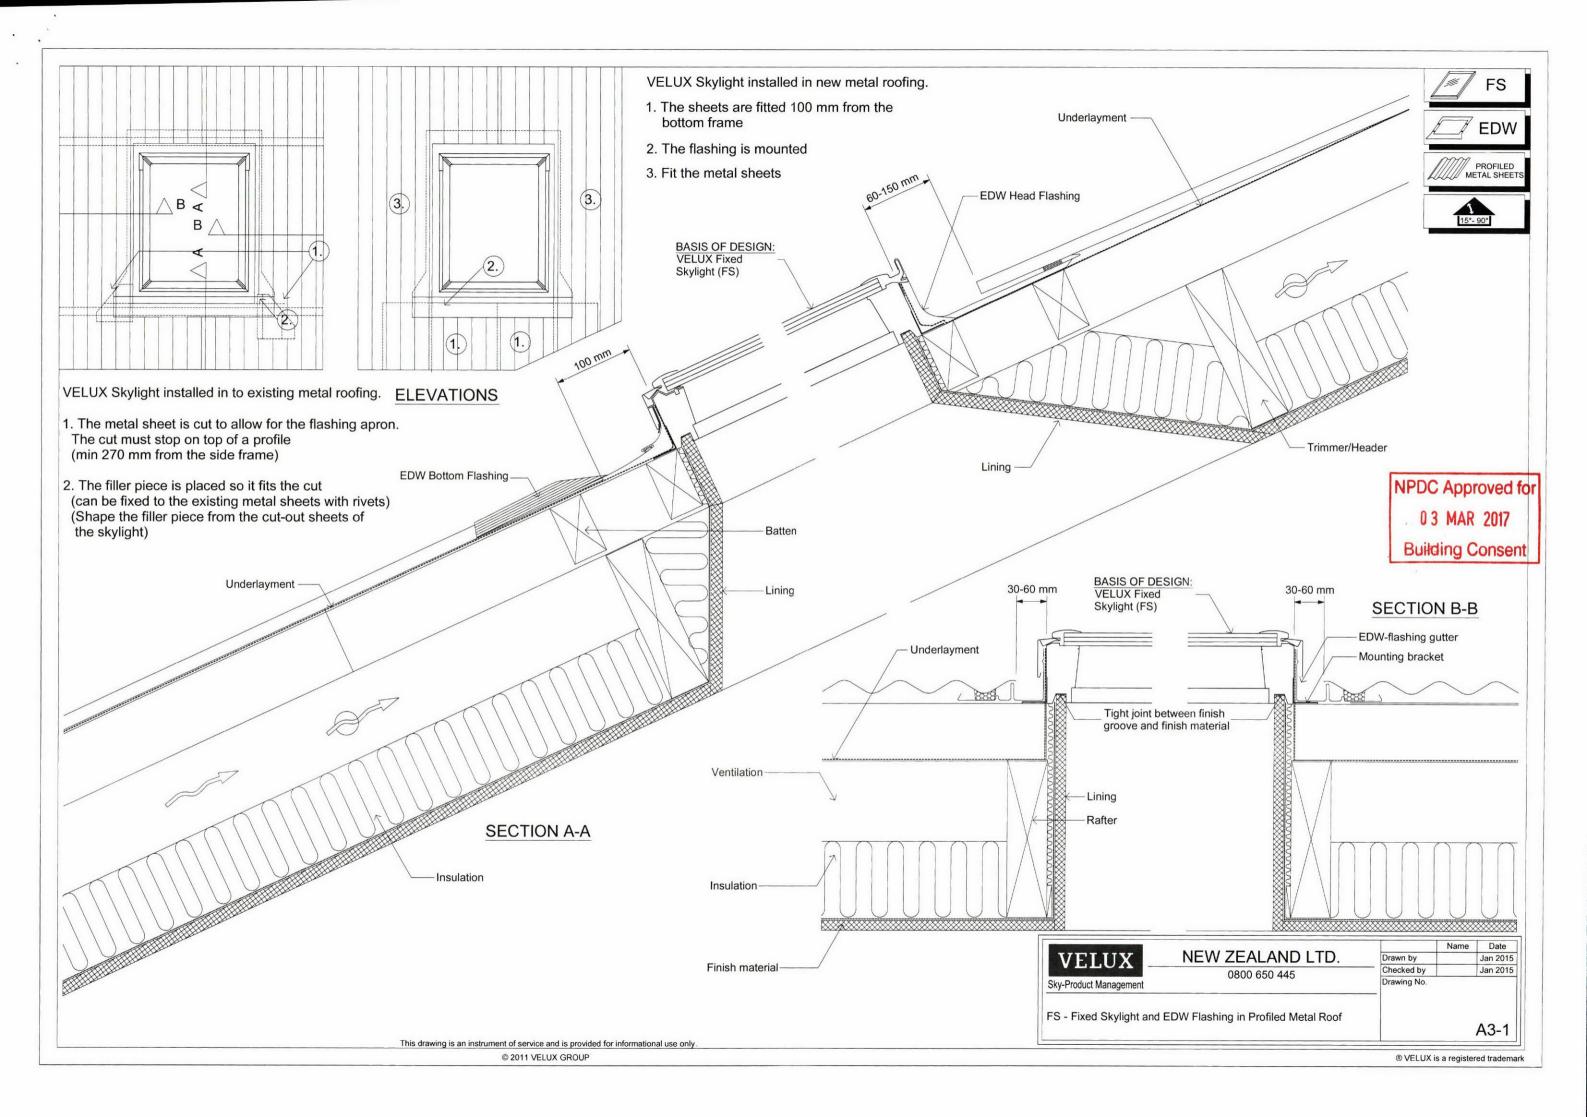


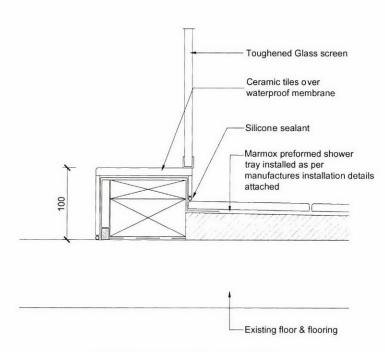


SHOWER NIB DETAIL

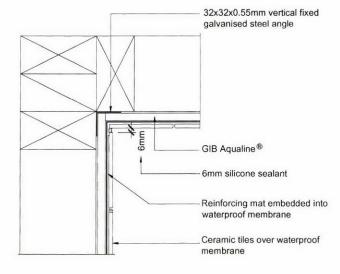

TILED CORNER DETAIL Scale 1:5

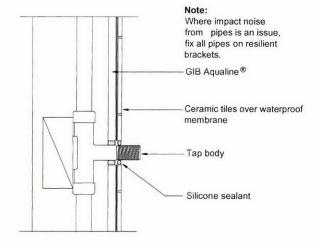

PENETRATION DETAIL Scale 1:5

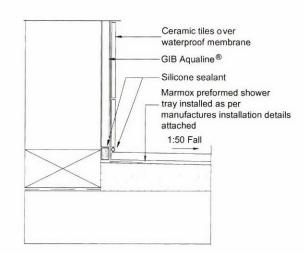

WALL / FLOOR DETAIL Scale 1:5



A Building Consent Issue 07.02.17 REVISION:

JOB TITLE :

Bathroom Alteration Wilson Residence 26c Nevada Drive New Plymouth



Ph.: (06) 769 5524 Mob: 027 2100 564 Email: paul@4sitedesign.co.nz PO Box 589 495A Devon Street East New Plymouth

SCALE: DRAWN: CHECKED:

1:5

DATE: 5931 REVISION : A

JOB No. : SHEET No. :

A3-2

BUILDING CONSENT 110254A

PROPERTY ID

007925





NEW PLYMOUTH DISTRICT COUNCIL

newplymouthnz.com

Code Compliance Certificate

Form 7, Section 95, Building Act 2004

The Building

Street Address of building: 26 C Nevada Drive NEW PLYMOUTH 4312 Legal Description of land where building is located: LOT 1 DP 15452

Current, lawfully established use: Dwelling

Year first constructed: Unknown

The Owner

Name of owner: Rachel Lorraine Wilson

Contact Person: Nova Energy Solar Ltd

Mailing Address: 26C Nevada Drive

NEW PLYMOUTH

Phone number: (Bus.)

(Pvt.)

021 117 0133

Facsimile number:

_

Building Work

Building Consent number:

Description of work:

Issued by:

BC10/110254

Installation of solar hot water heating K250

panel to existing 180L cylinder MP

New Plymouth District Council

Code Compliance


The building consent authority named below is satisfied, on reasonable grounds, that – (a) the building work complies with the building consent.

This is a final code compliance certificate issued in respect of all of the building work under the above building consent.

CODE COMPLIANCE CERTIFICATE

Team Leader Inspectorate

Date Issued: 22 September 2010

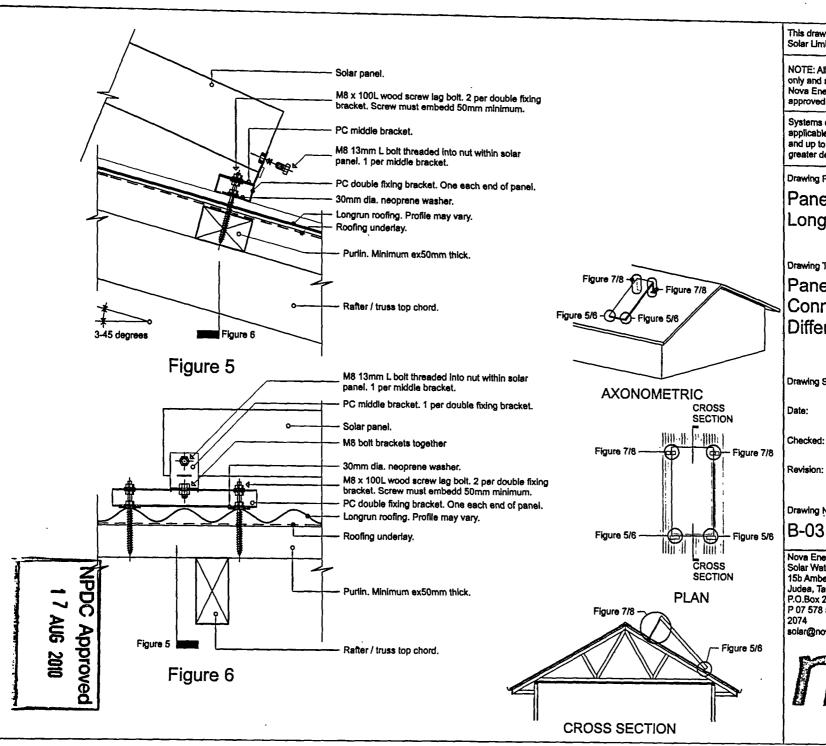

This drawing remains property of Nova Energy Solar Limited.

NOTE: All details and specifications are indicative only and are subject to change without notice. All Nova Energy Solar system are to be installed by approved contractors only.

Systems designed within these documents are applicable up to and including Very High wind zones and up to and including 1KPa snow loading. For greater design loads consult Nova Energy Solar.

Drawing Package:

Panel Installations Longrun Roofing

Drawing Title:

Panel Lower Fixing Roof Connection - Panel At Different Pitch To Roof

Drawing Scale(s) @A4;

1:5, 1:100

Date:

21.04.09


G-14.06.10

Drawing Number:

B-03

Nova Energy Solar Limited Solar Water Heating 15b Amber Crescent Judea, Tauranga 3140 P.O.Box 2310, Tauranga P 07 578 5281, 0800 668 276, F 07 571 solar@novaenergy.co.nz



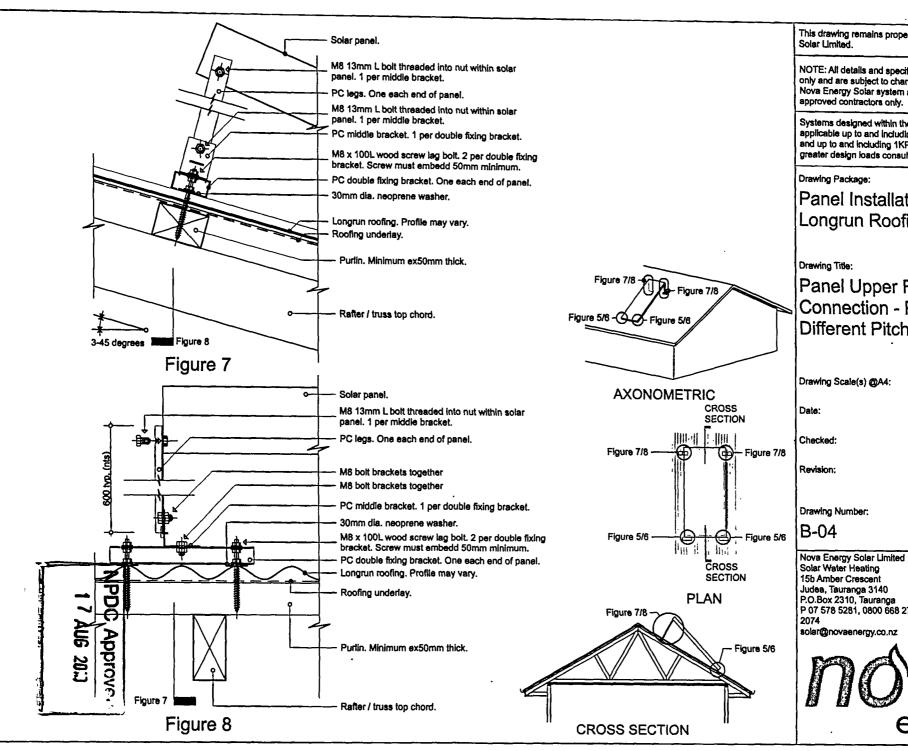

This drawing remains property of Nova Energy

NOTE: All details and specifications are indicative only and are subject to change without notice. All Nova Energy Solar system are to be installed by

Systems designed within these documents are applicable up to and including Very High wind zones and up to and including 1KPa snow loading. For greater design loads consult Nova Energy Solar.

Panel Installations Longrun Roofing

Panel Upper Fixing Roof Connection - Panel At Different Pitch To Roof


1:100, 1:5

21.04.09

G - 14.06.10

P 07 578 5281, 0800 668 278, F 07 571



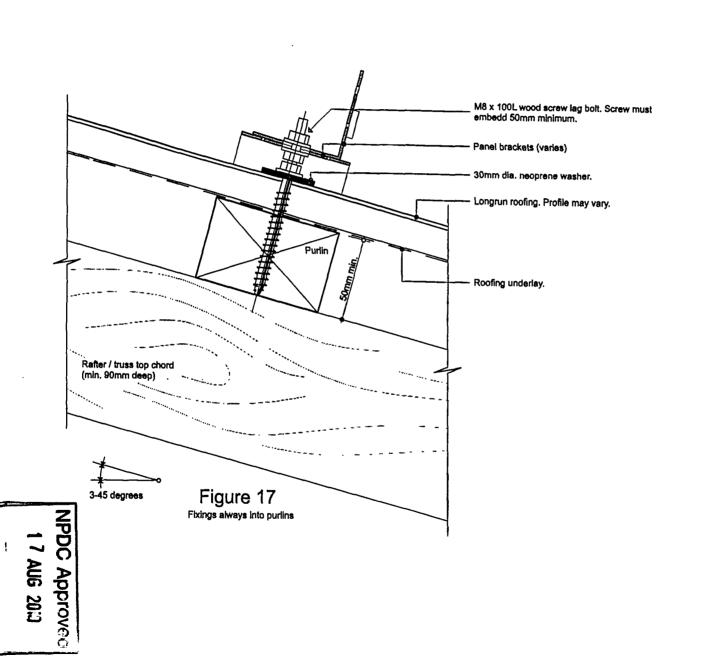

This drawing remains property of Nova Energy Solar Limited.

NOTE: All details and specifications are indicative only and are subject to change without notice. All Nova Energy Solar system are to be installed by approved contractors only.

Systems designed within these documents are applicable up to and including Very High wind zones and up to and including 1KPa snow loading. For greater design loads consult Nova Energy Solar.

Drawing Package:

Panel Installations Longrun Roofing

Drawing Title:

Panel Fixing Detail Into Purlin

Drawing Scale(s) @A4:

1:2

Date:

21.04.09

Checked:

MP

Revision:


G - 14.06.10


Drawing Number:

B-07

Nova Energy Solar Limited Solar Water Heating 15b Amber Crescent Judea, Tauranga 3140 P.O.Box 2310, Tauranga P 07 578 5281, 0800 668 278, F 07 571 -2074 solar@novaenergy.co.nz



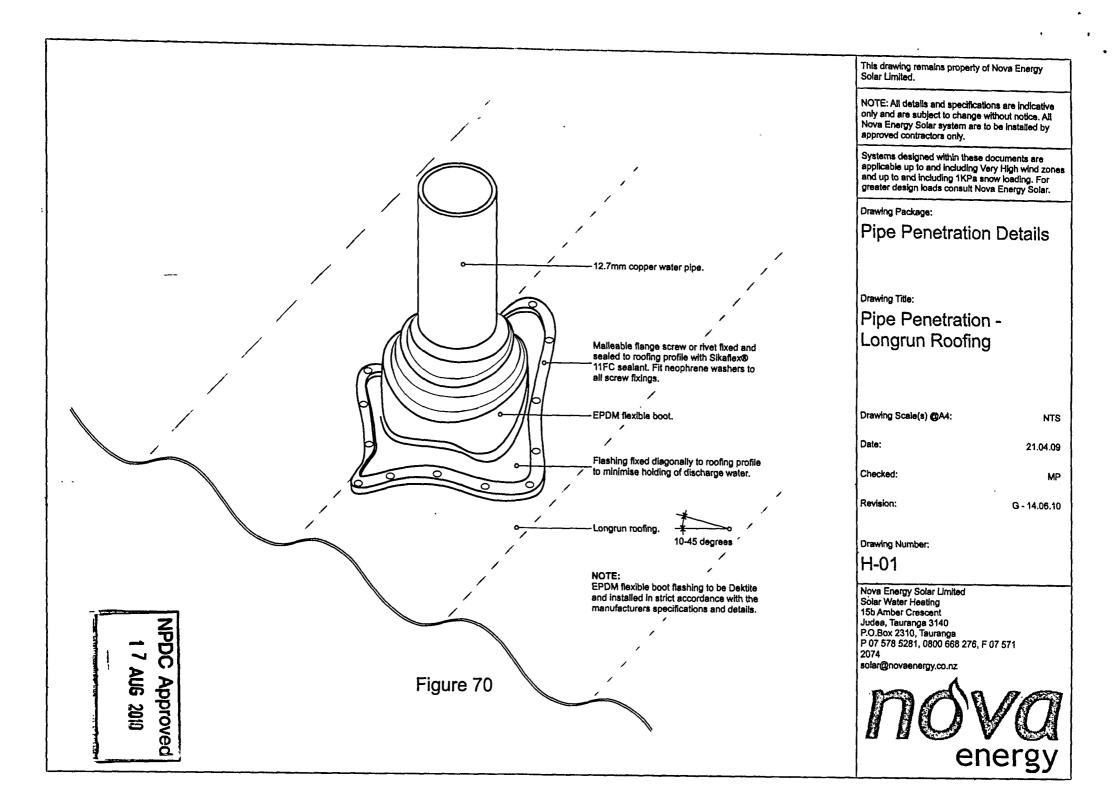

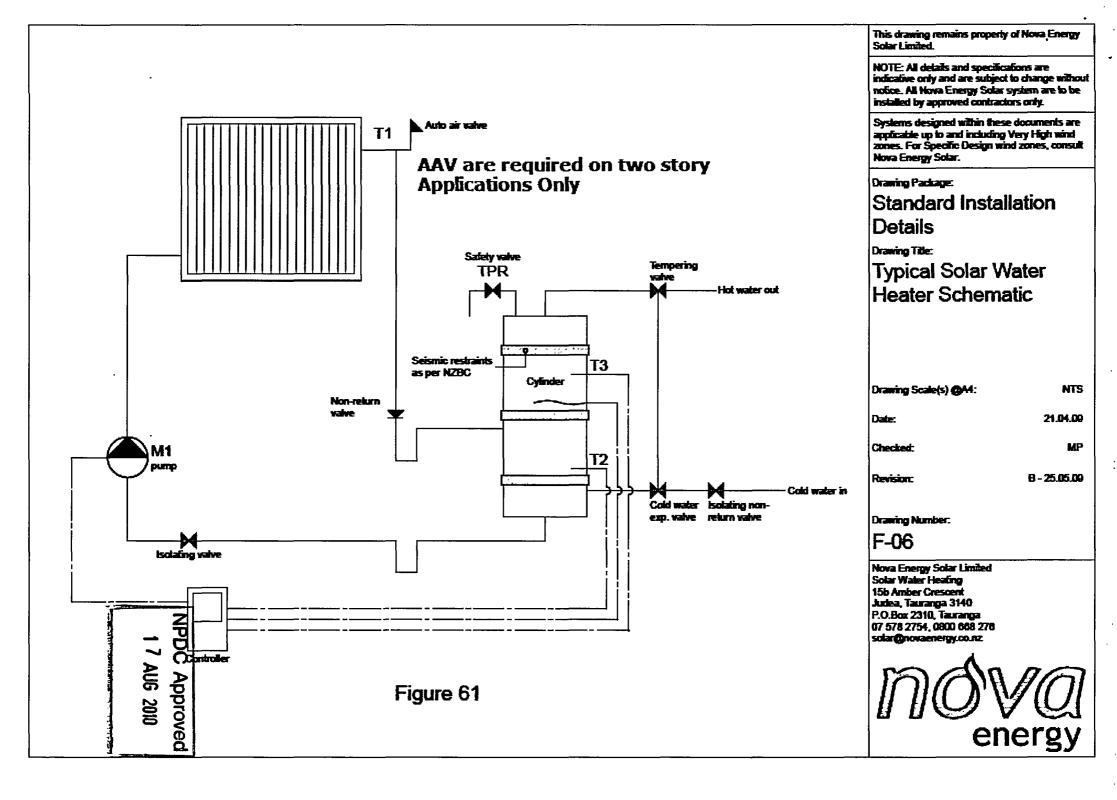



VIPAC ENGINEERS & SCIENTISTS

Vipac Engineers & Scientists Limited

A.B.N. 33 005 453 627

The Victorian Technology Centre
279 Normanby Road, Port Melbourne, VIC, 3207, AUSTRALIA
Telephone +61 3 9647 9700, Facsimile +61 3 9646 4370, www.vipac.com.au

Doc: 412812-1

Ref: 30S-08-0002-SOW-412812-1

27th November 2008

Todd Energy
PO Box 3141
95 Customhouse Quay Wellington, New Zealand
Attention: Dudley Maritz

Todd Energy K-series collector testing to AS/NZS 2712:2007

Dear Dudley Maritz

I hereby inform you that we have completed all the required testing on your K250L hot water system and K-250L solar collector.

You can certify the collector K-series, L type to AS/NZS 2712:2007.

· Please contact me if you have any further queries regarding the test results.

Yours sincerely

Kumar Lingam

do- Fund

Kumarl@Vipac.com.au

NPDC Approved

Melbourne • Sydney • Adelaide • Perth • Brisbane • Hunter Valley • Tasmania • Singapore • Dubai • Hong Kong 2010

Commercial In Confidence

intelligent measurement technology

SENZTEK

1/41 Egrisford Cres, Avoodale, Auckland 0600, New Zealand PO Box 80093 Green Bay Waitakere 0643, New Zealand

PHONE +64'9.828'5327'
FAX +64'9.828'4217'
ENISE OfficeOSSE(256K)COM

www.senizfek.com.

To whom it may concern:

Senztek New Zealand limited is the manufacturer of SolaStat products and owns the SolaStat brandname.

SolaStatiphoducts are designed and manufacturered within an accredited. AS/NZ ISO9001:1994 quality control system.

Solarstat Controllers conform to the appropriate requirements of:
EU Directive 89/336/EEC, amended by 92/31/EEC; Article 10, Paragraph 1, relating to Electromagnetic Compatibility, and to the appropriate requirements of Directive 73/23/EEC, Article 2, Paragraph 1, relating to Safety of Electrical Equipment.


SolarStat Controllers conform to Ctick regulations required under New Zealand law (Section 134(1)(g) Radiocommunications Act 1989 and in accordance with Regulation 101A of the Electricity Regulations 1997) and are labeled with either Z495 or Z985 supplier codes.

All declarations are on file and viewable at our company offices as per the regulations.

Lance Allen Technical Manager pp Senztek Limited

NPDC Approved

Basic SolaStat-Plus-2 Installation.
The SolaStat-2 controlling the Solar Collector circulating pump and the SolaStat-Rly Regy Module.

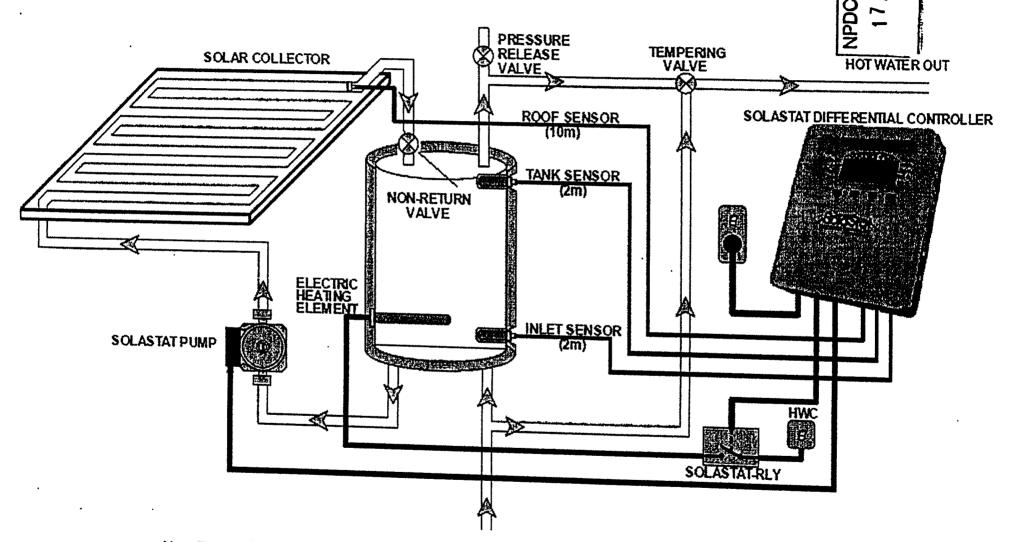

Note. This diagram is only to be used as a general guide and not all the required components are shown. Each installation needs to be customised to suit its situation. Always use best plumbing practices, and comply to any regulatory requirements.



TEMPERING VALVE

Application

· High and low pressure hot water systems

Standards

- Complies with NZ Building Code G12 (2001)
- Complies with NZS 4617:1989
- NZ Patent No. 517764, Aust. Patent No. 2003200856
 RSA. Patent No. 2003/1992

Specifications

· Length:

TV15 110mm

TV20 105mm

TV20D . 130mm

TV12 110mm

- · Thermostatically controlled safety valve to prevent scalding.
- Factory set to give 55°C outlet. Can be adjusted from 35°C to 60°C.
- · Inlet hot water supply 65°C to 99°C.

· Inlet water pressures:

TV15.....30 to 1000 kPa (3m head)

TV20.....20 to 1000 kPa (2m head)

· Flow rates:


TV15.....20 L/min at 20 kPa inlet pressure.

TV20......20 L/min at 20 kPa inlet pressure.

Operating Pressure:


Balanced hot and cold pressure. For unequal water pressure of up to 5:1 (Cold to Hot), non-return must be fitted to hot inlet.

- Extremely high flow rate makes the TV20 suited to low pressure systems.
- TV15P, designed for installation within close proximity to bathroom fixtures.

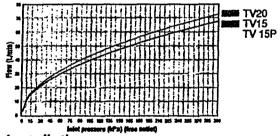


Installation

- · Refer page 19 for installation guide
- · Valve must be fitted by a qualified plumber.
- · Installation must comply with local authority requirements.
- Valve may be installed in any orientation.
- Flush pipes prior to fitting.
- · Valve must be protected by a line strainer.
- Non-return valves are required at hot and cold inlets in Ring Main Installations.
- Connections are H (hot inlet), C (cold inlet) and OUT (mixed temperature outlet).
- Do not apply heat near valve during installation this may damage the mechanism.
- · Do NOT install valve directly into outlet of cylinder.
- Use TV15P at point of use.

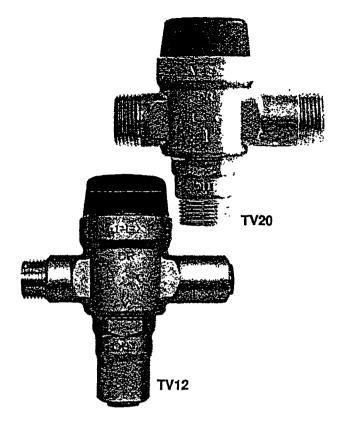


Temperature Adjustment


Remove cap. Use screwdrivet to adjust to desired temperature. To increase, turn anti-clockwise (H). To decrease, turn clockwise (C). Replace cap. Maximum delivered hot water temperature at any sanitary fixture used for personal hygiene shall not exceed 55°C. For childhood centres, schools, old peoples homes and hospitals, outlet must be set to 45°C.

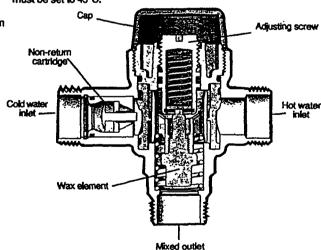


Product Codes


TV15 15mm
TV15P 15mm Point of use Tempering Value C Approved
TV20 20mm
TV20D 20mm Ring main installation (Non-return of book likets)
TV12 15mm BSP Hot
12mm John Guest cold and Nix

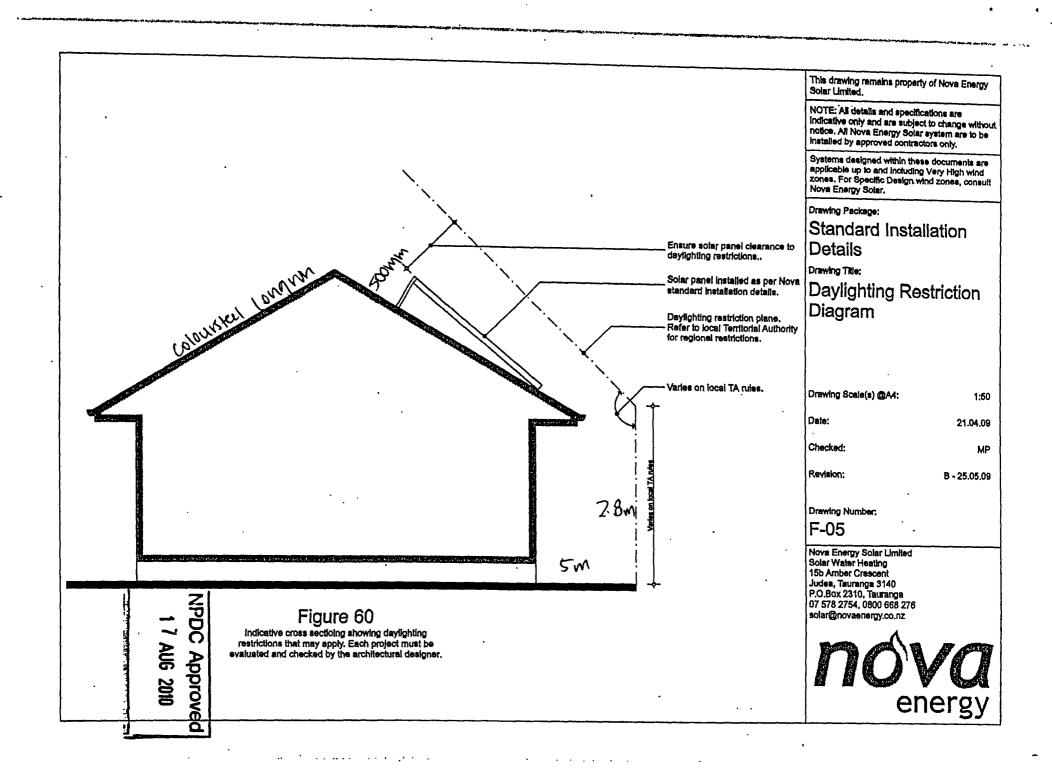

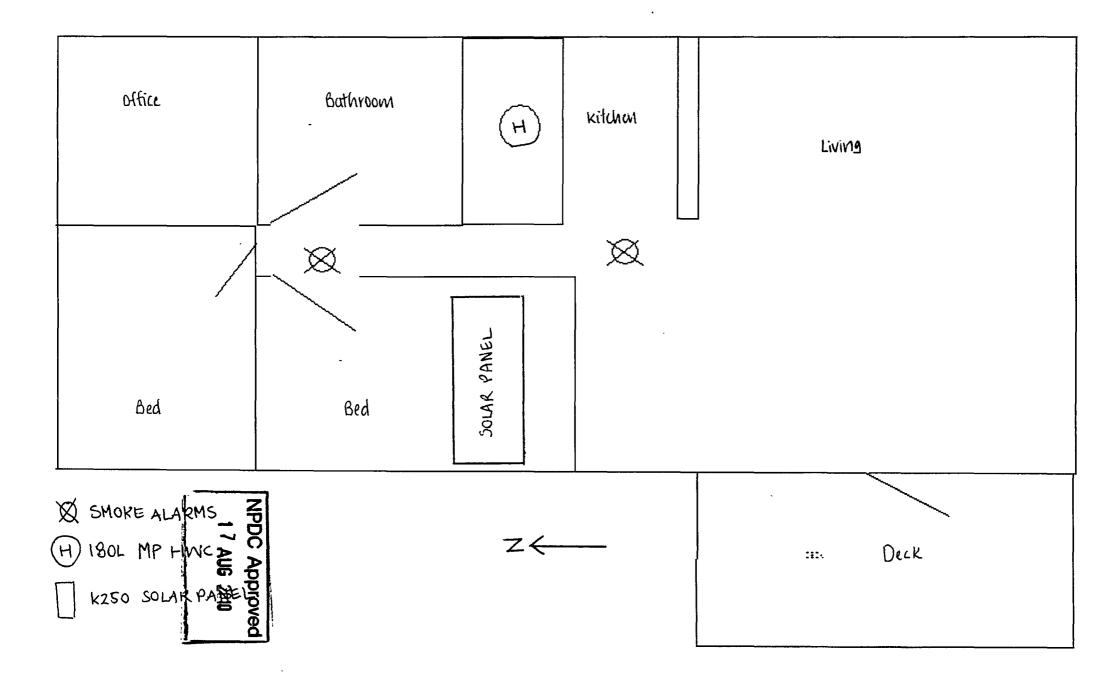

NPDC Approved 1 7 AUG 2010 K250 Pavel on 500mm legs. facing north,

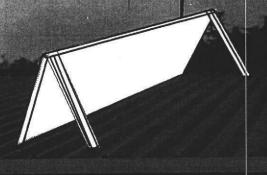

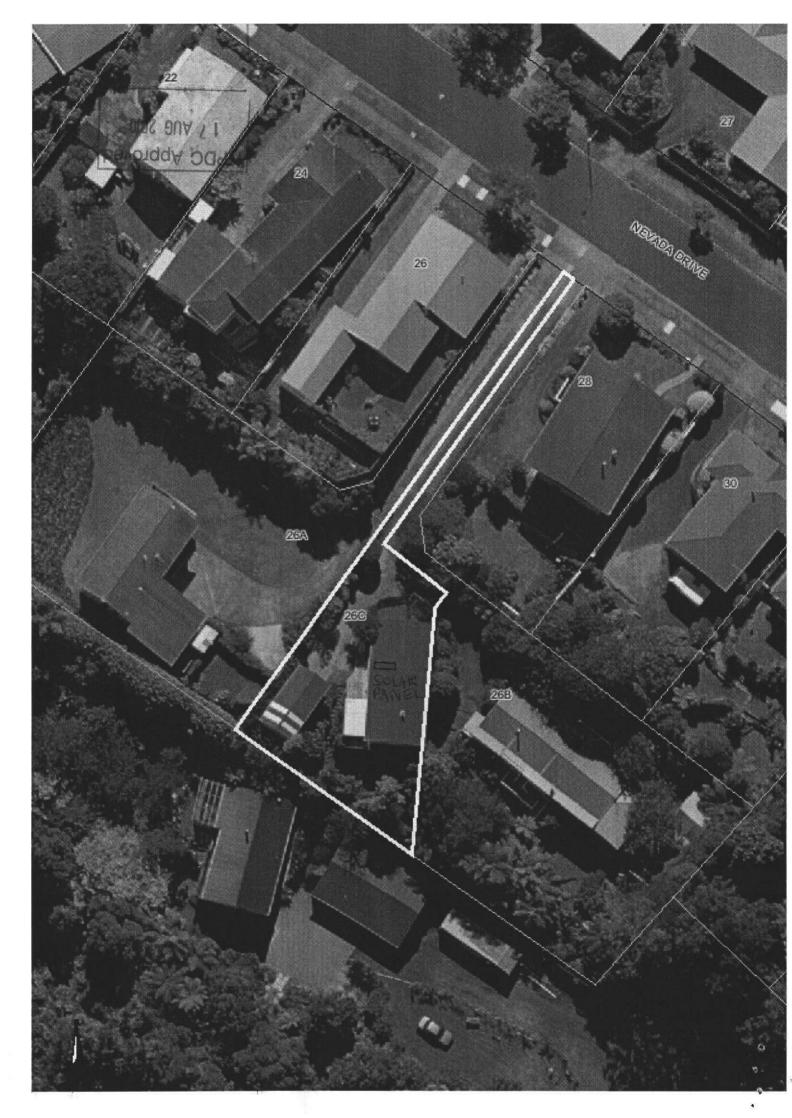



Code Compliance Certificate

Form 7, Section 95, Building Act 2004

The Building

Street Address of building: 26 C Nevada Drive NEW PLYMOUTH 4312 Legal Description of land where building is located: LOT 1 DP 15452

Current, lawfully established use: Dwelling

Year first constructed: Unknown

The Owner

Name of owner: Rachel Lorraine Wilson

Contact Person: Nova Energy Solar Ltd

Mailing Address: 26C Nevada Drive

NEW PLYMOUTH

Phone number: (Bus.)

(Pvt.) 021 117 0133

Facsimile number: -

Building Work

Building Consent number: BC10/110254

Description of work: Installation of solar hot water heating K250

panel to existing 180L cylinder MP

Issued by: New Plymouth District Council

Code Compliance

The building consent authority named below is satisfied, on reasonable grounds, that – (a) the building work complies with the building consent.

This is a final code compliance certificate issued in respect of all of the building work under the above building consent.

CODE COMPLIANCE CERTIFICATE

Team Leader Inspectorate

Date Issued: 22 September 2010

TARANAKI



Code Compliance Certificate

Form 7, Section 95, Building Act 2004

The Building

Street Address of building: 26 C Nevada Drive NEW PLYMOUTH 4312 Legal Description of land where building is located: LOT 1 DP 15452

Current, lawfully established use: Dwelling

Year first constructed: 2017

The Owner

Name of owner: Rachel Lorraine Wilson Ph

Applicant: 4 Site Design

Mail Address: Rachel Wilson

26C Nevada Drive

NEW PLYMOUTH 4312

Phone number: (Pvt.) 021 117 0133 Email address: winkhug@hotmail.com

Building Work

Building Consent number: BC17/121306
Description of work: Bathroom

Issued by: New Plymouth District Council

Code Compliance

The building consent authority named below is satisfied, on reasonable grounds, that – (a) The building work complies with the building consent.

This is a final code compliance certificate issued in respect of all of the building work under the above building consent.

CODE COMPLIANCE CERTIFICATE

Building Administration Officer

On behalf of: New Plymouth District Council

Date Issued: 26 June 2017











Te Kaunihera-å-Rohe o Ngamotu


New Plymouth

COPYRIGHT: Cadastral informations ourced from Land Information New Zealand data. Crown Copyright Reserved. DIS CLAIMER: NPDC assumes no responsibility for the completeness or accuracy of the data displayed on the plot. To be used for indicative purposes only.

District Council

HORIZONTAL DATUM

MAP PROJECTION New Zealand Transverse Mercator

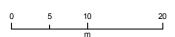

MILES Print Map

New Zealand Geodetic Datum 2000



Date: 9/5/2022