

· (型) (型)

Council Records

These records were obtained in March 2023. NPDC is currently undergoing a review of the property search report content. As such the documentation provided by the NPDC may not be a complete full record. We suggest you get your own professional advice on the provided content and in fact any NPDC files for this property.

48mm 35mm


BUILDING FILE Code No. 473 | 5 Subject ADD TO DOG/ADD TO DOG CARPORT.


No. Sheets ____3

Permit NO R4409/R11367/48171

Date

14.8.68/9.12.74/22.10.81

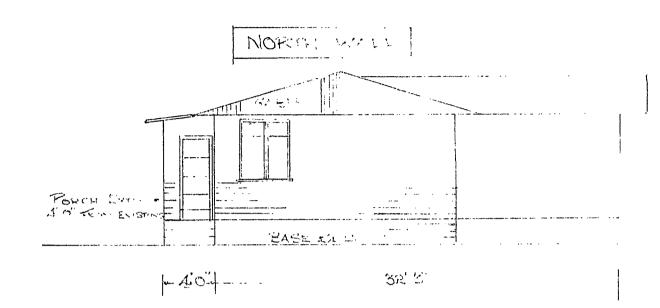


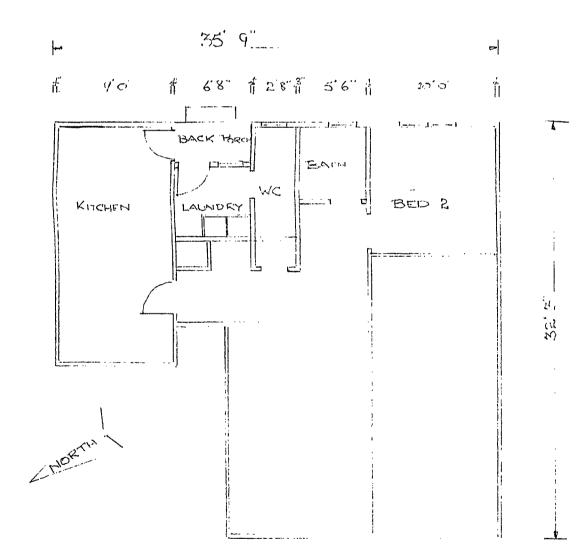

EXISTING FLOOR PRAIS SCALE 1" = 8' 0"

PROPOSED ADDITION TO PORCH

MR. D. B. ARMETROMA A KAMPINE AND SHO

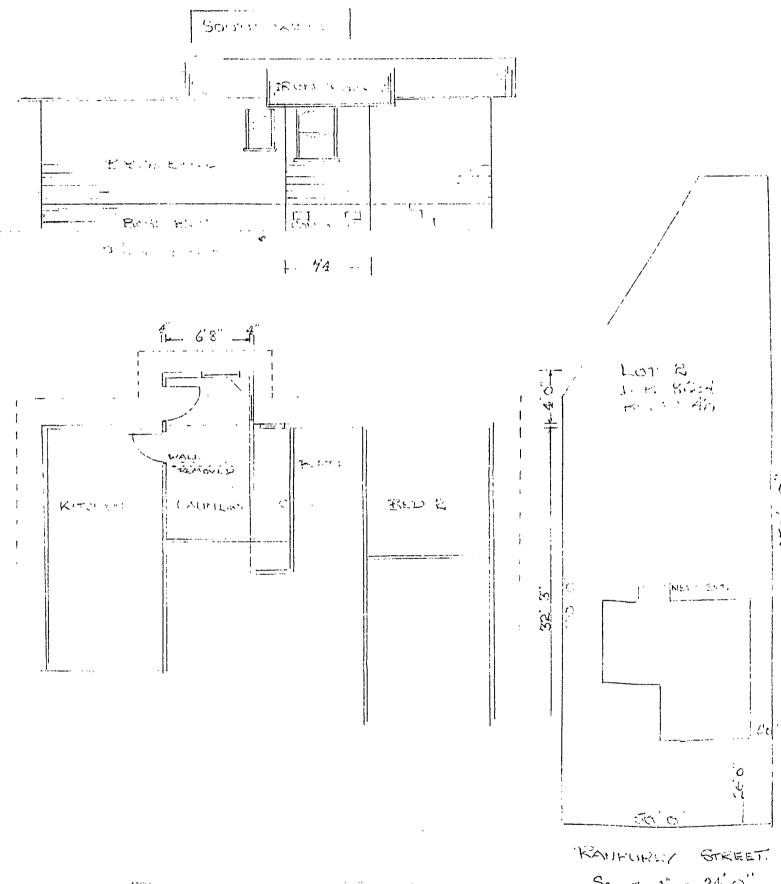

Scale 1" + 24 0" TROPONEL AUTOR


SPERMICATURE

FOR THE THE ST CONCRETE WALLS STATE OF THE S


17000 THORNERS SOLD THEN TO THE STATE OF THE STATE Planting Conin Intent

九 市政公司

8 65 5

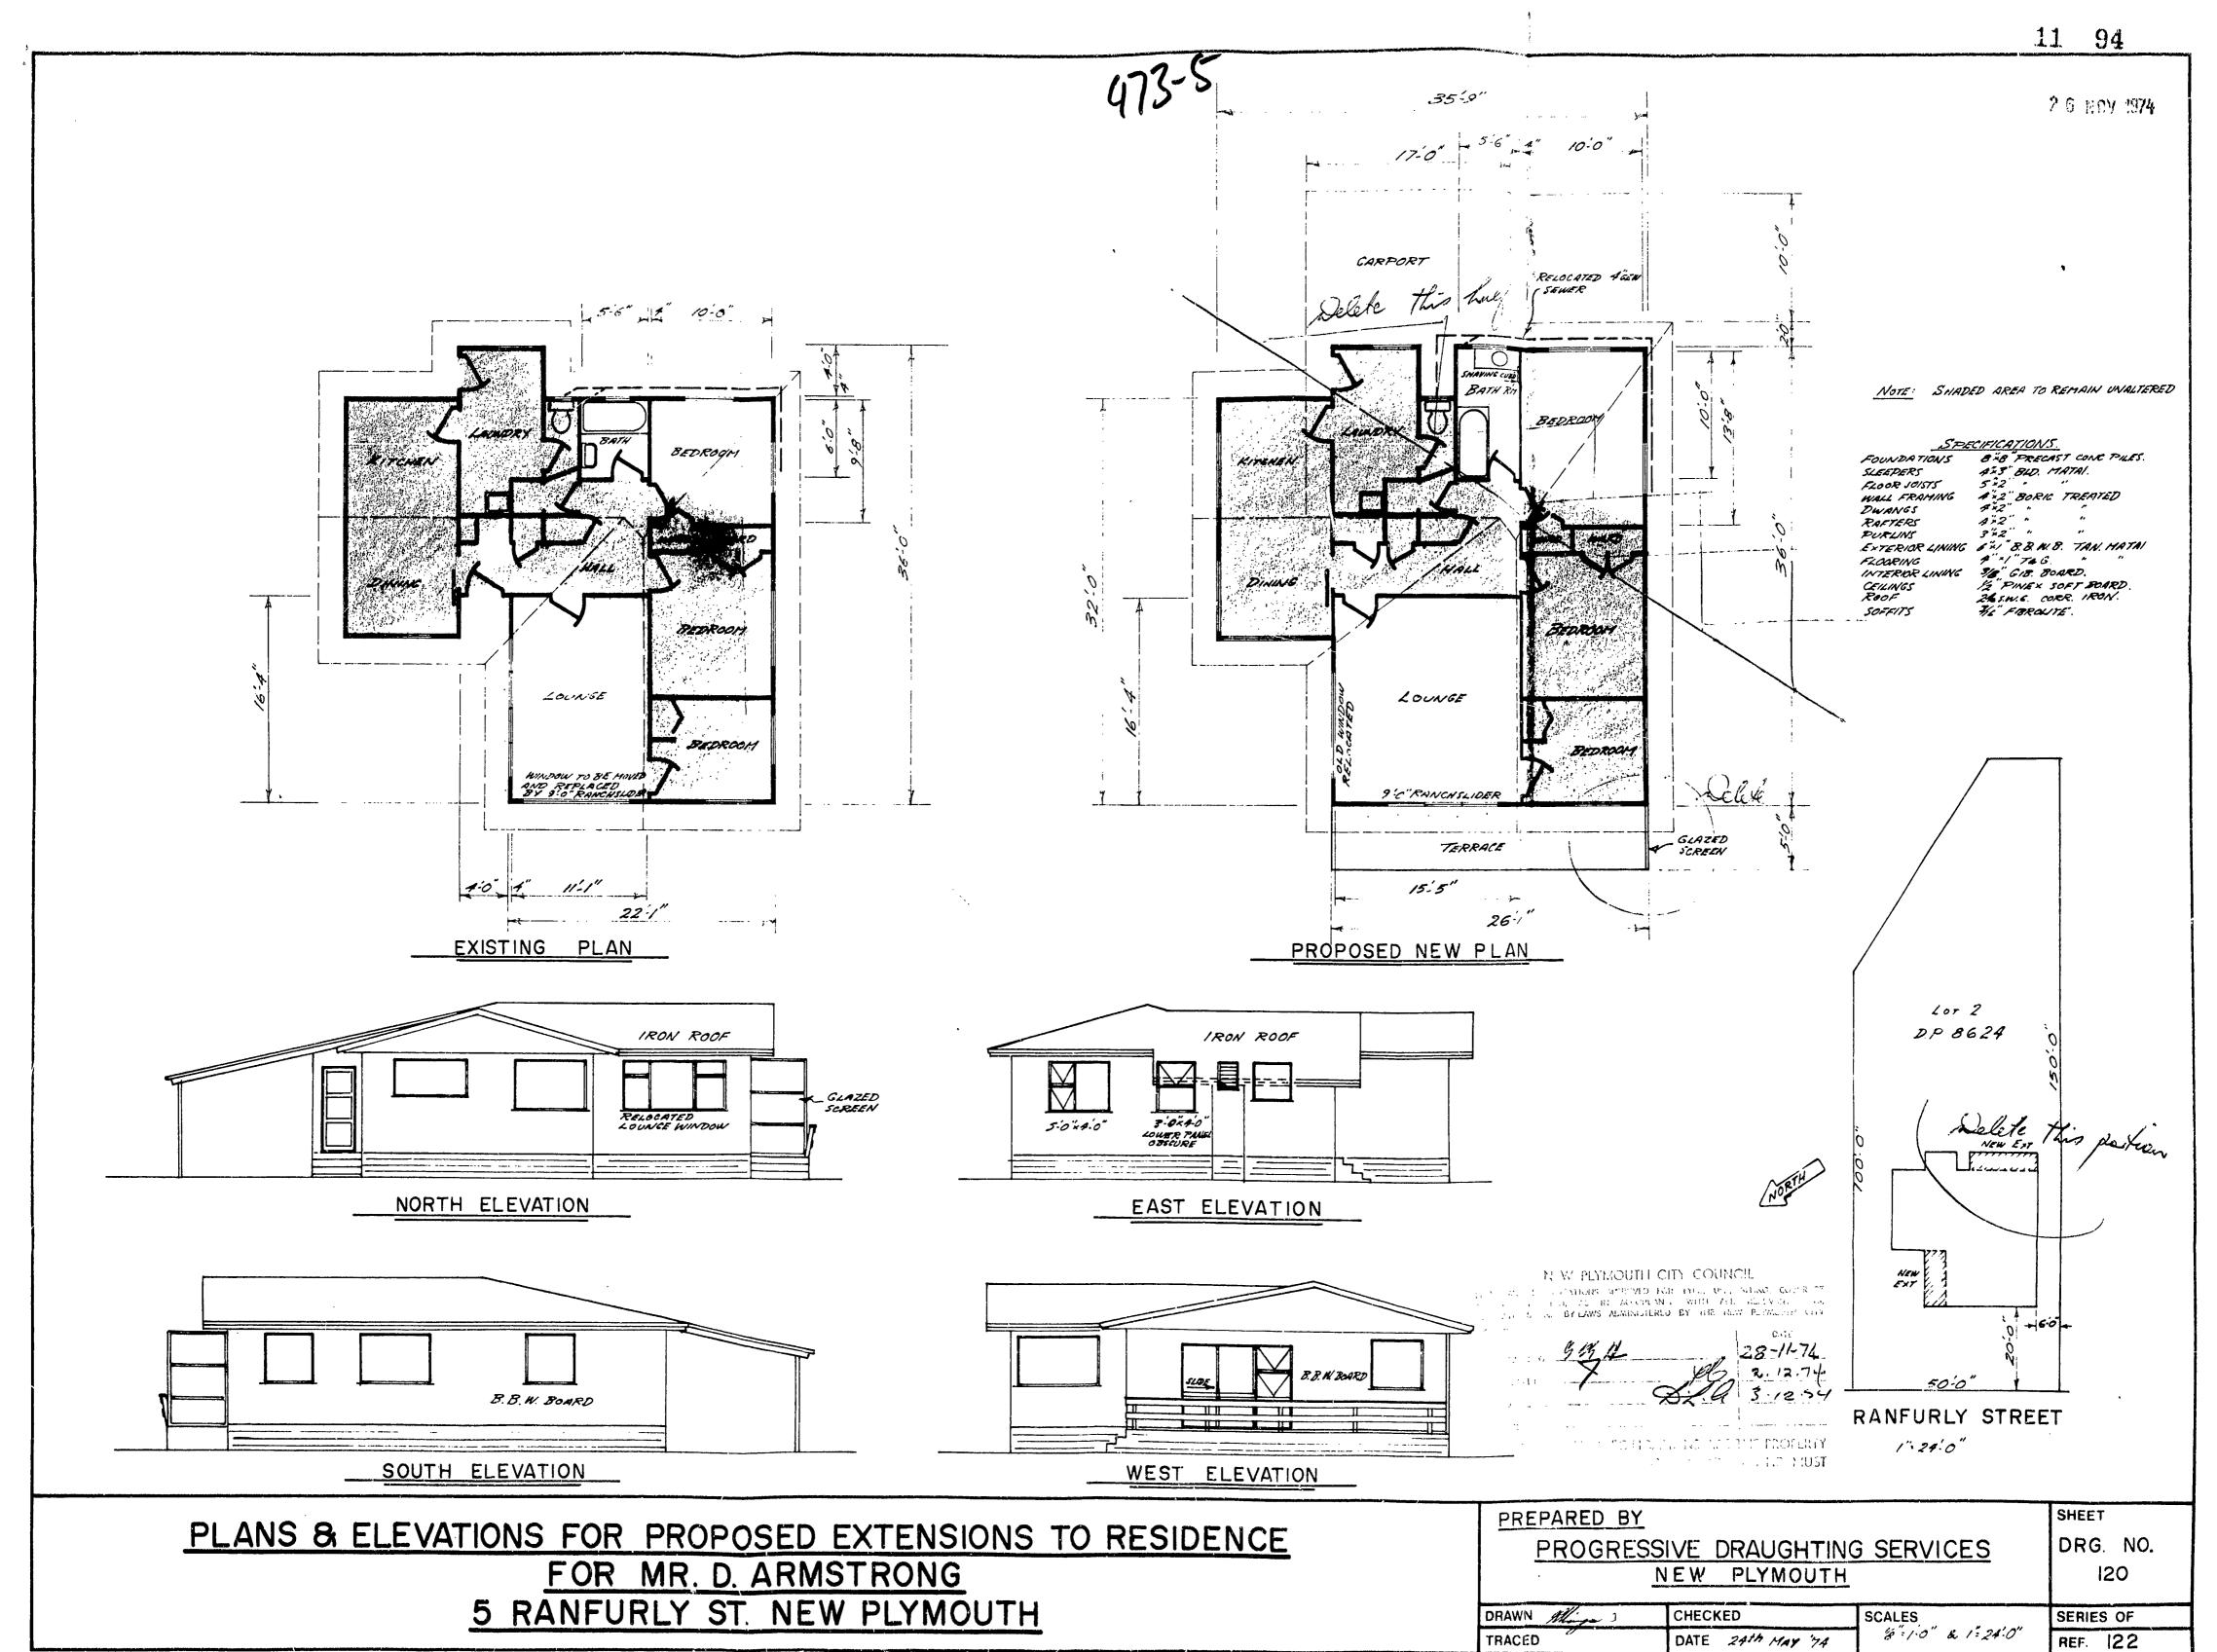

* * * * *

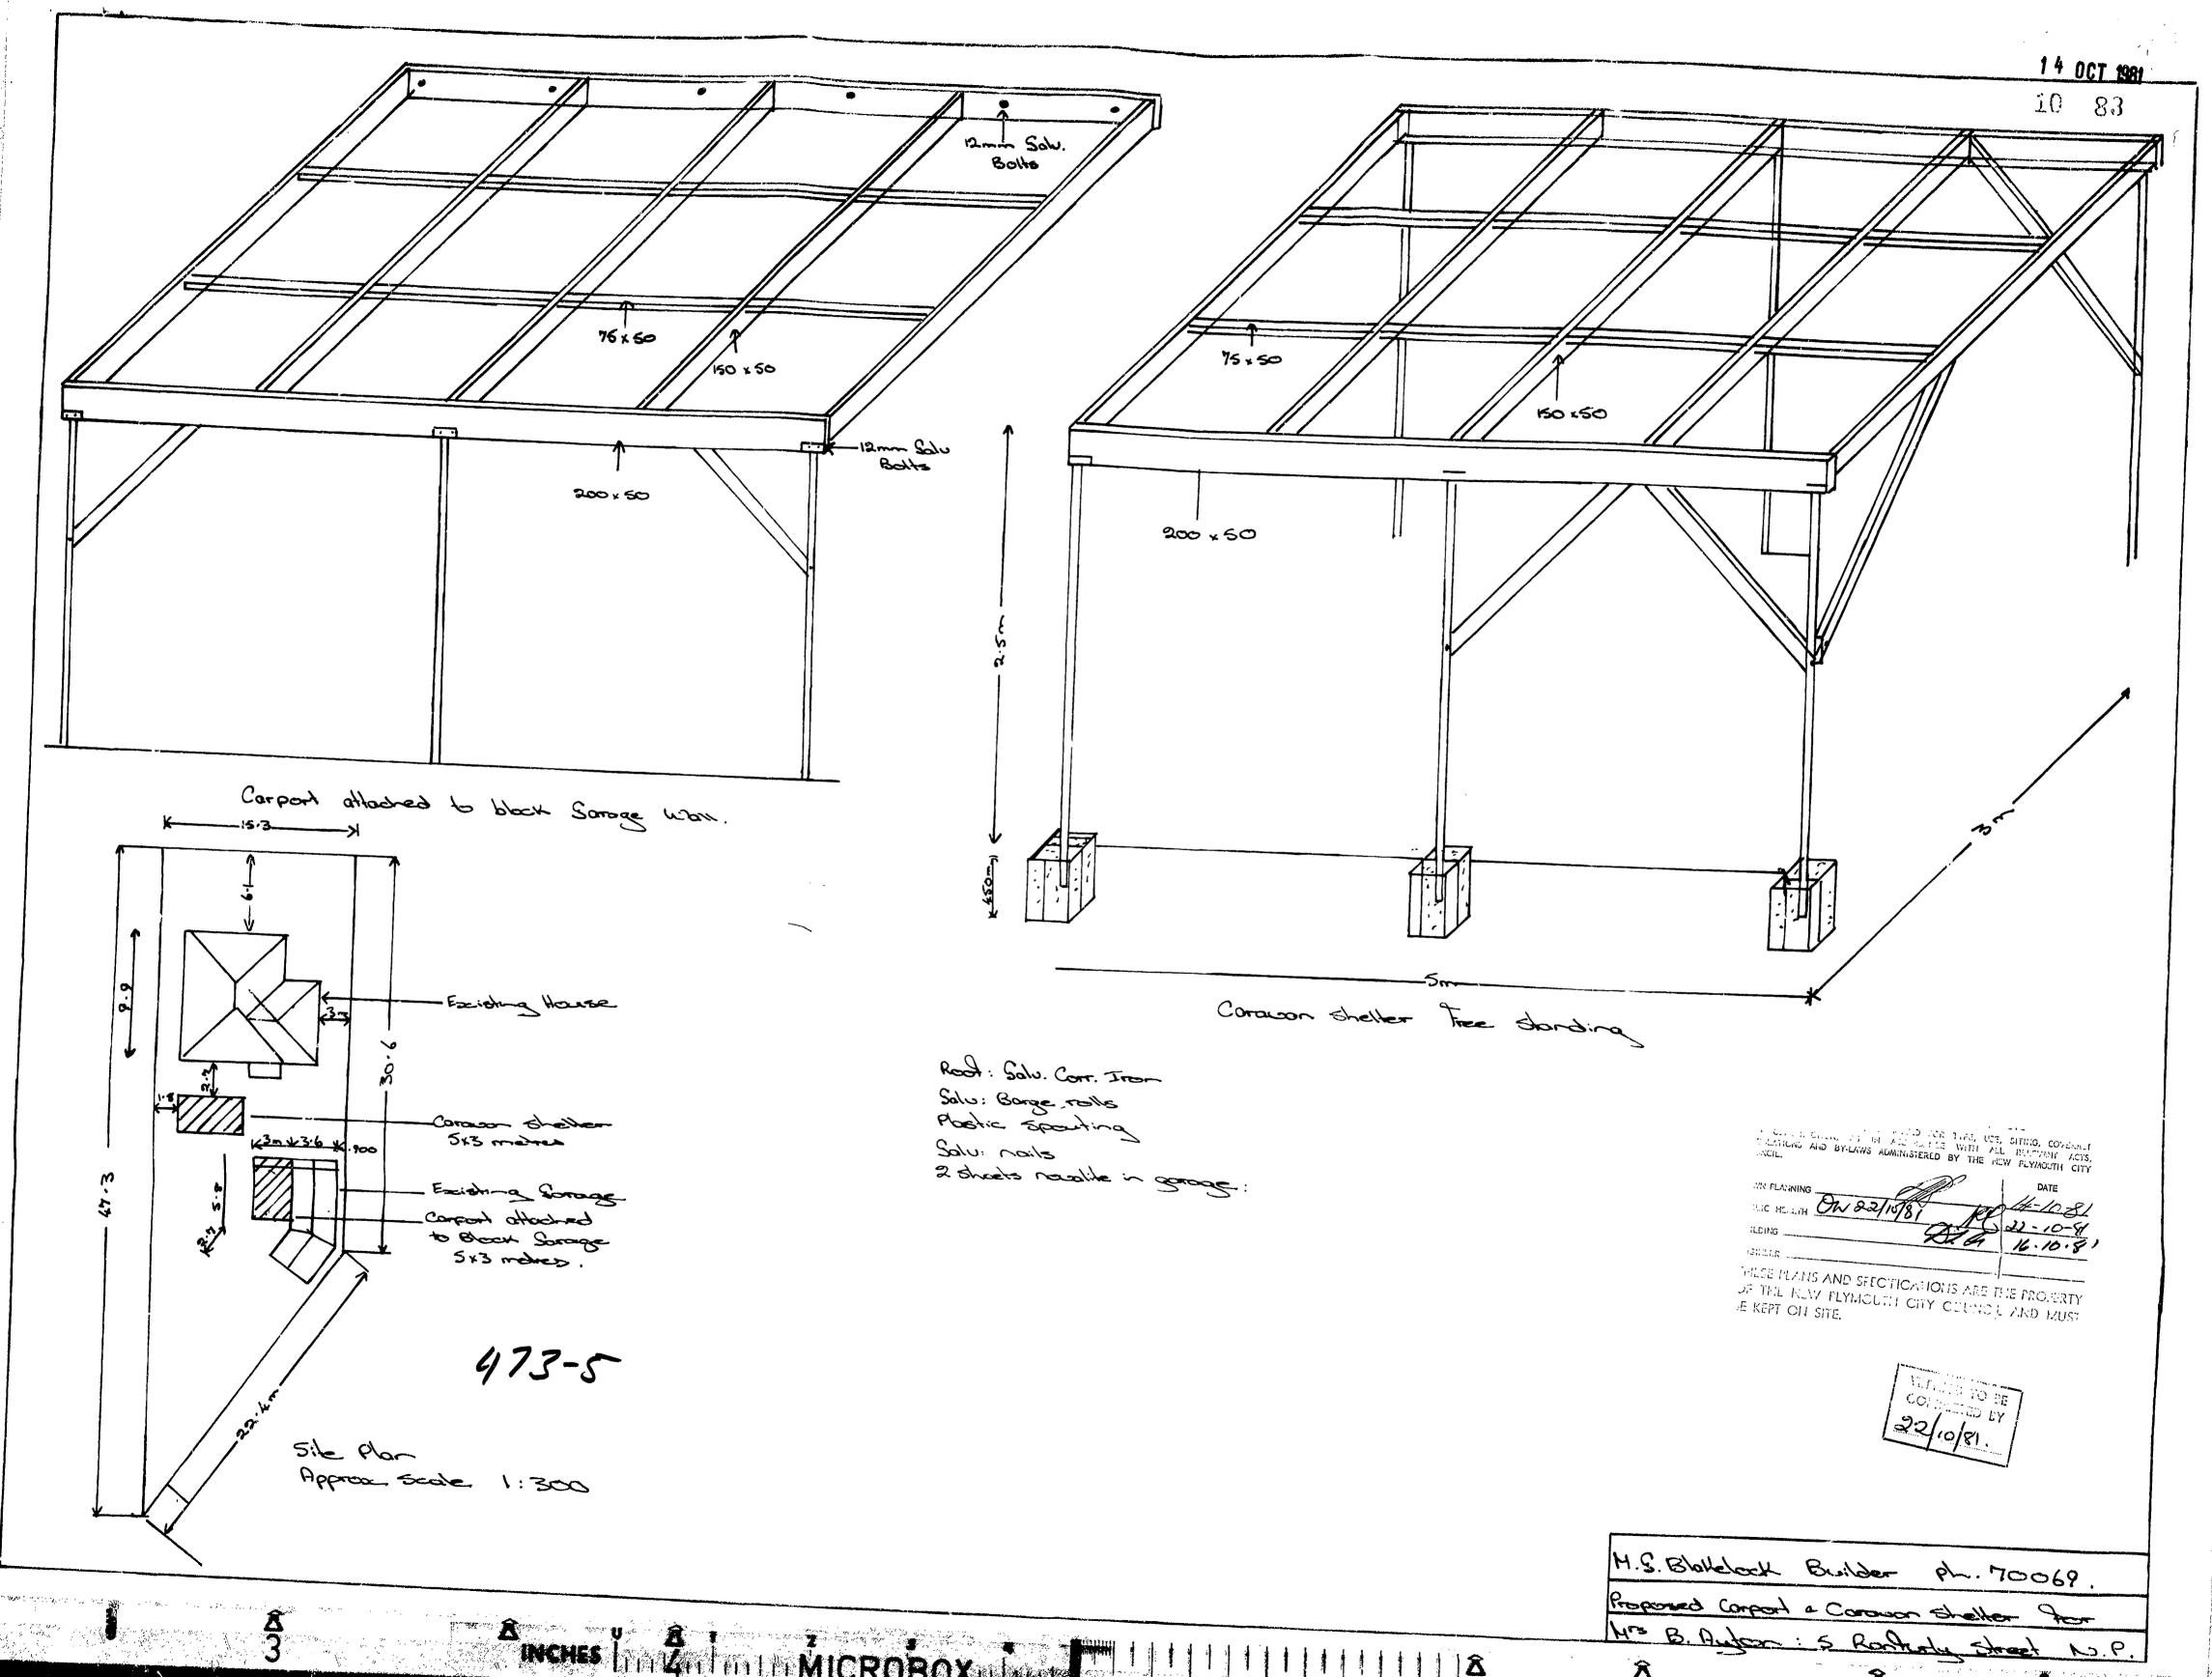

16 mm 35 mg

BUILDING FILE Code No. 473 / 5 Subject Disg/GARAGE + SHED/ ADD TO DISG/ADD TO DISG/CARPORT


Date 1-3-60 (7.2.67/14.8-68/ 9.12.74/22.10.81 NEW PLYMOUTH CITY COUNCIL

, MAP is

[P.T.O.

Building Application Form

	Date 1/3/60 19
To the City Engineer. NEW PLYMOUTH.	Date to say the same to the sa
S:-	et dwelling
at (House No & Street) Pour List	et of welling leg Attor (Owner) Scoancel Hon
of (Address) Frankly Not	according to locality plan and detailed plans
elevations, cross-sections, and specifications of	building deposited herewith in duplicate.
Particulars of land: Lot No. 2.	Deposited plan No.
Section No.	•
Length of frontage	Area
Particulars of buildings: Foundations	les
Walls alessee	Roof Constant
○ 4 × △	square feet
Area of outbuildings	. square feet
	£2\$28 ~ -
Sanitary Plumbing	Salar
Sanitary Drainage	
	£27/8 4:-
roposed purpose for which every part of build uch part intended for use or occupation for a s	ing is to be used or occupied (describe separately separate purpose):
	• • •
roposed use or occupancy of other part of buil-	ding:
	Yours faithfully.
198 frankling	I Service Storment
ostal address / 4 0 / Harring Roy //	y unauch of the der
A-1, -0001-4 formad n= do-001	is of plans is NOT a possis

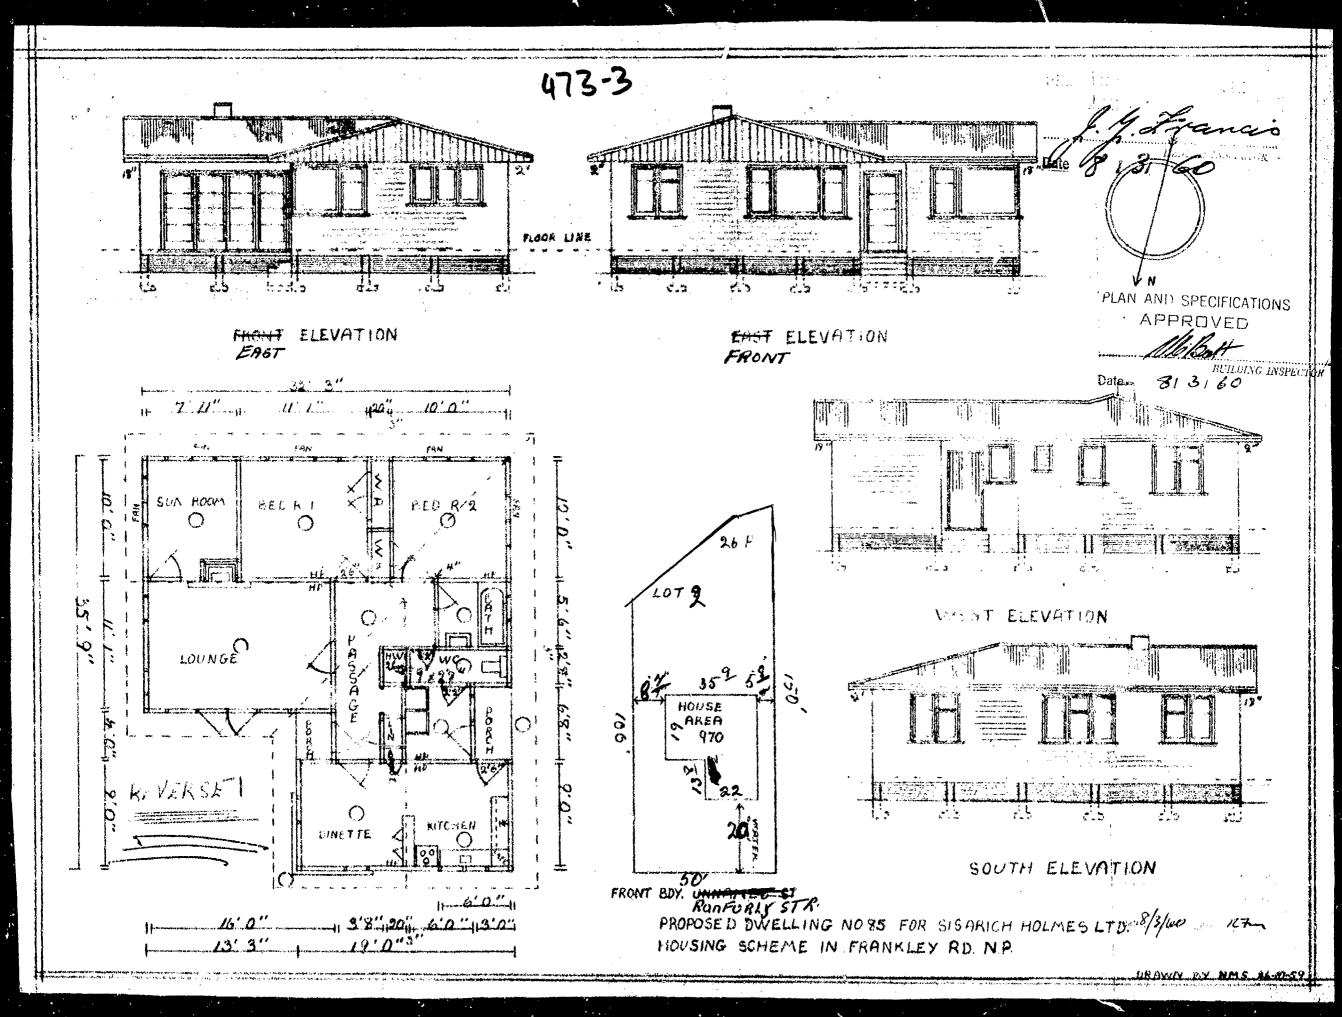

5 RANFURLY ST

SISARICH HOMES

DMELLING

7216

473-5

1240

OR OFFICE USE :	
ile No. 2 4 Receipt No. 54 Date	of Receipt
NEW PLYMOUTH CITY COUNCIL	Date
o: The City Engineer.	Lot No. 2
PPLICATION FOR Building Permit and/or Services	D.P. No. 8624
0	Section No.
	Zone Residential
on enection of GARKE AND JOED	Area of Site
WIER: D.B. Armstronky	
DDRESS: 5 RANFURLY St. No.s PLYMOUTH.	
hoposed use: Carage and workship	
oundation: Concluse.	
2115 CONGETTE BLOCKS ROOF CORRUGATED	• • • • • • • • • • • • • • • • • • • •
EEA or Existing Buildings 970 sq. ft	
	FEES
EEA of Existing Accessory sq. ft	• • • • • • • • • • • • • • • • • • • •
REA of Building in Applic- 3.70 sq. ft	•
STIMETED FINISHED VALUES	
Edilding £370; O: O.	£_£:_:_
nively FIGURE & Thinage \pounds : .: FOR ALL £ 370: 0.: 0.	ت - السيسيد ، السيسيد
TWEE TOOLS TO	•
Pistance from left boundary	
Depth of Sewer at boundary	£
Size of Service ATER CONNECTION :	
Distance from left boundary	
Size of Service	£:
ATER (Building)	£:
EHICLE CROSSING: When Required EXISTING.	
Distance from left boundary	
Type of Footpath	
Depth of Channel	
Type of Crossing	£::_
EPOSIT for Damage to Path :	£;
Ourdings: Months	£:
MSPECTION of Second-hand Buildings or Materials _	£ : :
TOTAL :	£ 2: -:
EGISTERED PLUMBER:	
EGISTELE) DRAIMIAYER :	
WILDER:	
TAKE & ADDAESS OF AFPLICANT: D.B. ARMSTRONG 5	RANFURLY ST, NEW RYMONE
I	Phone: 36469

(Sée Over)

RAMORKE JE

P. S. J. M. John Comiting.

FROPOSED. 84ED. 49AXAGE.

473-5

Spe Fell

-7. FEB. 1987

12" AN THORN STEEL FOR FOR THE

Dames has her to thing 256"

473-5	२	·4 ·67
412		57
FOR OFFICE USE:	Check Sheet No. 9/2	
Zone Keside trat	Sewer Sheet No. 240)
File No. 8 53 Receipt No. 4409 D	ate of Receipt 14/8/65	
NEW PLYMOUTH CITY COUNCIL		
To: The City Engineer.	Date 4	
ARDITCICION FOR Building Permit and/or Services	Lot No. 21 0.286	24
AT (House No. and St.) 5- KANFURLY STA.	Section No. 1. Sec 42	
For erection of Appitter to Duchika.	Area of Site	
OWNER: MR. D.S. ARINSTRONG	D. P. 462	24
ADDRESS: 5 KANFURNY STR.		
Proposed use: Application To Residence.		<u> </u>
Foundation: CONCRETÉ		
Walls B.B GEATHER SO ROOF CERR. D	RON	
AREA of Existing Buildings 970.	gq. ft.	
AREA of Existing Accessory Buildings	sq. ft.	
AREA of Building in Application 22	sq. ft.	
	FEES	
ESTIMATED FINISHED VALUES Building \$ \$000 :000	· · · · · · · · · · · · · · · · · · ·	:00
Sanitary Plumbing & Drainage \$:	\$	•
2		
TOTAL 3 SCC CCC		
SEWER CONVECTION:		
Distance from left boundary		
Depth of Sewer at boundary		
Size of Service	<u> </u>	-
WATER CONNECTION:		
Distance from left boundary	<u> </u>	
Size of Service	\$	
WATER (Building)	\$	
VEHICLE CROSSING: When required]	
Distance from left boundary		
Type of Footpath		
Depth of Channel		
Type of Crossing	\$	
DEPOSIT for Damage to Path:	\$	
HOARDINGS: Months	\$	
INSPECTION: of Second-hand Buildings or Materials	Ś	<u>.</u>
TOTA	AL: \$ 5	2 : 00.
Starting Date	•	
Completion Date 31-8-68		
RIGISTERED PLUMBER:		
RIGISTERED DRAINLAYER:		
BUILDER: SIMONULIN Y WILLIAMS		
NAME & ADDRESS OF APPLICANT: 7 7 TASMAN S	Manual RKRKS	
NEW THOUSEN.	Phone 35353	
Signa	ture: Mimasor	
	(see over)	

NEW PLYMOUTH CITY COUNCIL 8/53/68

FOR OFFICE USE:	11 94 File No.	Check Sheet N	io 7240	·•
		7 Sewer Sheet N		anne.
		2.74 Zone Res		
TO THE CITY ENGIN	EER			07 1874 25- 11-74
	BUILDING PERMIT			2
At (House Sail 5	Rougherly St.		D.P.	8624
For erection of A	dolition to a	welling	Sec. No	• a, a a trasper o paragaga per hamora pada mai beas per hamilia
OWNER D. C	Ums Hang	welling ADDRESS	as above	
Proposed Use			. providence of a selection and the best of the contract of th	
Foundation Poles		Walls weather &	ed. Roof ca	v. ison
ARmA of Site			. yang magaadha (mi) sans,	
AREA of existing build	ings		,,,,,,,,,,,,,,,,,,,,,,,,,,,,,,,,,,,,,,,	
AREA of existing access	sory buildings			
AREA of Bailding in a	ipplication GREGORY,	65-32	sg fl.	
Builder	46 SANDERS AVE., NEW PLYMOUTH.	Address	According to Accord Series 15	ما يعدون و المعارض المعارض و ا
Designer	and the second s	Address		
Structural Eng		Address		na com a cinho do e frago del quado de podenção e frago e quado de que de la
Building Projects Author	rity Required Yes/ No	Supplied Yes / No		
			FOR OFFICE	USE
Total Value of Building		\$ 2700.00	Corrected Valu	e Fees
Sanitary Plumbing and	Drainage	5		
Value of Building for P	ermit	\$ 2700.00		14-00
Water for Building				
Building Research Levy	on	s		
Hoardings N	Iths @			
-		TOTAL	FEES BUILDING	
Starting Date JA	<u>/</u>	Finishing Date	FRB 75	na e e e e e e e e e e e e e e e e e e e
		T E CHECORY		
	S OF APPLICANT	PHONE 33:483 46 SANDERS AVE., NEW PLYMOUTH.	Phone	
		Signature of Appli	120	<i>f</i> ·
		Signature of Own	er	ing and a state of the state of

PRECLESCATIONS

27 6 19 1974

for translate for something and the first ordered th The Carry of the American Street Stre

GERAL

The ork involves sidening the lounge on the forth side, extensions to the cost against the bathroom and the adjacent accreant provintion of an and a 45% carport attended to the rear of the lower a concrete terrace end sereen to the front; and sundry minor items listed below.

The owner shall extend his "House Owners" policy INSURANCES!t: cover the new work.

The builder shall carry a "Public Mish" policy for the furnition of the contract for a minimum value of 50,000.00.

The main contractor is to obtain local authority permits for any phase of the job regularing them, except for electrical work. All electrical work shall be the responsibility of the other.

Mo deviction from the plans and specifications is Vallations: No deviation from the plans and spectited the temperature of the denored Discrepancies and omissions shall be referred to the pener for a decision.

Duilder an agreed sum for each shase of construction. Such sum to be puld not later than the 18th day of the month in which the secount is resented.

Decomes apparent ithin 90 days of completion of the vorte

COLUMN T.Z.S.S. 1905 and local authority by-laws.

FOUNDATIONS

one of least '8" in the ground. It will be necessary to remove the existing concrete terroco extending from the front door along the length of the lounge.

is to be provided on the so to care front. Suild two steps on the north and as shown an the stan. MEM STAMORIH CLLA CONNCIF

PROVICE 4" X 7" LONGUIT CHY COUNCIL

PROVICE 4" X 7" LONGUITECCO STATE ACCORDANCE WITH ALL SLEWNS ACCORDANCE OF THE REPORT OF THE STATE to the piles.

Use "nolthid" downcourse at all points widre one D POTABLE - Use "holthold" doubecourse at our times my cone into contact with response of the PROCESSOR

SALED OF SPECER As ly one cost of Asto + coment worter to the monthly nes front terrace one steps and finish smoth. The Day Contact AND NEST

473.5

CARDEDZER

2

The main contractor is to cork in with all subcontractors, and shall carry out any dwanging, notaling atc. replaced by true. Timber sizes shall be as shown in the following and shall match the existing therever possible.

Schools of Timbers

#GMLDE PTV	。近日の大学が大学の大学の大学の大学の大学の大学の大学の大学の大学の大学の大学の大学の大学の大
	Mys ten. rodinte to. 4 a 6 o \$ mox.
Floor joists - 5 x 2	n n a a 484 n n
Franks - 4 x 2	Thoric of the party of the part
Precing - 4" x 7"	galv. perforated proceed steel angle.
<u>linecis</u> - ex 4" :	Wick No. 4 boric rediate. Depth as led la 1.1.5.5. 4900 Cn. 6.4.26.4 Table 6.
	le G. trouted native timbor, to be sanded acree and fine papers after all other work isseed.
FOSCIO - (x -)	ogs treated native timber to match existing.
301 1t 20100 - 3/46"	.ordicflex.
Celling bene in lornce -	- 40" x 4" eregen or 41" x 4" redicte No.4.
SACCIONAL SERVICIONAL SERVICIO	- 30 x 30 rodicto Fo. *
- 11 1111 105 1 1 2 1 1 1 1 1 1 1 1 1 1 1 1 1 1 1 1	
	- Uff n W tracted G.B.C. to mater enisting.
A CONTRACTOR OF THE PROPERTY O	dibrolter board plastaged scooth.
3.02 f - 26 g. (guiv. corrugated iron over netting and paper.
SOUTH CONTRACTOR AND A STATE OF THE STATE OF	truted G.A.A. to moter exlating.
C. I. Director	Poštio neto den de tra tenperio ja il del to
24"x12" plain -	The later is the leading of the later
pinex panels	- Carlotter of the state of the

Bridge Bridge Control of the Control

Cant Cuphoers in tall - Provide and fit a 6'0 x 2'0 Ho. 4 O.B.
fluor door, complete with jombs, label, hinges
cto. Fit 4/45" recives evenly spaced.

Lowest door - we the existing lounge dear to the position on the class sense the existing front door and the order good.

ciaminist elidic a new 9'0" wide, three panel ciaminists elidics door as shown on the plan, and fit late the front wall of the lowage.

A full longth flush poince is to behilt in over this wisdow.

leade it have c - leaded the existing chiden from the front of the laws o to the north wall. Remove the existing franch doors from this position. Build in a light winct ending clear of the hall door.

Cities in John 1999 - Sawido and instal a non-five ingo by

Giorn on the instal anning or giorn on the

Diors, Lindows & Sundries (Ctd.)

edroid - Replace the existing window with a or to in

Fravide and fix a single, white the plant of the plant 42 law the Paca sum - Ener di in item.

Tito the Fil. out of SOO, No for the engly on Of the "And romite" "thodestone 43" Vente unit. Instal in the best room in the position shows on

-t. Re-locate the existing bath in the no-position-shown an the plan. Build in with flush side and

et poor site - Re-lin the entire bothroom walls with "Land-doint and comer manidings.

- Provide and fix standard, 26g. Calv. iron suchers over all mitred, exterior, weatherboard corners including the existing corners. exterior consers

The lounge extension is to be reafed over by re-pitching the rafters from the existing ridge backet to the mer exterior plate. This will involve noving, and longthening the existing valley, and the re-liming the longe half of the gable end. (beby corrected from) and providing 4'0 of sight colling in the lounge, The betteron before extension is to be realed over-by means
of the constanting from the original top whate cight on the fer side of the cusport.

Control of the state of the superts. 3/3" galv. plue set 24" into the ground

Kafter: 6 x 2 N/S borie rudicto a 36" / max. Purlies 3 x 2 " " " " " 33" g "

PLUSDER & DRAINLAYER

The wais combrator will be responsible for the payment The water community to the section.

irring

taryteen weeto pipes fro . bath etc. - - the now gully . - tes - Josition.

e-use the existing bringon tops on the buth and ****** Vanite united in their nor positions, Reticulate hot but dula neter, and pressure test before interior

10 miles - Windy Ne. 26 Sr Sulva iron sometag along the entrance and bedroom and provide - Re-use existing spouting and downpipe

NEW PLYMOUTH CITY COUNCIL

CITY ENGINEER'S DEPARTMENT

REQUIREMENTS 11 ASSESSED

Not Approved _ _ _ _


	0
Project: Addition to Owelling Check Sheet No. 7240	
Owner: D _ Armstrong Sewer Sheet No. 240 _ Plotted	
Uwner: U _ Hrm arong sewer sheet No. 242 _ Flotted	•
Address: 5 Ranfurly Street Zone: _ Rea Ri	
Lot No2 D.P 862H Sec. No Area of Site:	
Town Distance	
TOWN PLANNING	
Designations	
Area of Buildings	
Coverage	
Yaximum Haight	, i
Front Yero	
Relet. of Bldg. Size: (1) Rear Yard	
(2) 5ide Yard	1 3
Span Space	
Grassed Areas	
Traes	1 2
Building Lines & Street Widening	
Parking	
Access to Rear of Site	
Accessory Buildings	1 1
	1 1
Service Lanes & R.D.W	1 2
Trassing Length	, ,
Gross Floor Area of Shops	
Resid. Accom.	1 1
Levels of Site	
-ss of Yards	1 1
_cading	
Screening	
Amalgam. of Titles	
Ramarks:	İ
20	٠. يو ده
Approved £	24

A: SEWER CONNECTION	STORMWATER CONNECTION
Existing Service	
Required Service	
Location	
Depth	
Special Requirement	·
Common Brain	• • • • • • • • • • • • • • • • • • • •
Fee \$	
	FEE \$:
B: WATER CONNECTION	
Existing Service	
Distance from _/Boundary	
Distance: Yain to Boundary	
Boundary to Load	
Pecuireo Service	
Meterological companies and a	
	FEE \$:
C : PLUMBING	
3 2 1	2 2 2
	nsSinks ShowersTubsOthers
Total Valuesullullullullullul	
Supply Pipe Sizes_ 4 Eackflow Prev Emily	P.V.C. Copper L.JGal. Iron L.J
Strer Fittings	
Estimated Veluel	Plumbing Fee
TRAIT AGE	
<u>DPAINAGE</u>	
Evisting Redu	
Fittings Required	
Sermon Brain	
Septic Tank&	
Stormaster	
Estimatad Value	- Drainage Fee
Total Estimated Value P. & D. \$:	FEE \$ 1/1/;
D: VEHICULAR CROSSINGS	
Type of Footpath Cond	dition
(erp & Cheanel	
Existing Crossing	
lew Crossing Posi	tion
otrengthen Path Sq.Yds Leve	
rations and the property of th	t ac noningary
STREET WORKS FEE S :	DEPOSIT DAMAGE FEE \$.


REMARKS : CORRESPONDENCE : AGREEMENTS SPECIFIC REQUIREMENTS

	the second of th
	N
	Approved
Not	Approved
 -	
	Approved
5	
j ⊂ %	Approved
	ApprovedyB
	Approved
Not	Approved
	. 1
	Approved #6
Not	
	F # =
	_
	Approved
Not	: Approvea

E : HEALTH & BY-LAWS			•
Areas			
-ight			
Ventiletion			
Serarks:			
		1	
	Approved	7-3.1	2.74
	Not Approved		
F: DANGEROUS GOODS			
Domastic or Commercial		· · · · · · · · · · · · · · · · · · ·	
Storage Dapacity & Location			
Licence Required Yes/No			
	Approved		
	Not Approved		
G : BUILDING			
C. DOLLDING			
Perarks:			
			
	 1 Self off and approximations of paper personnel and paper paper. 		
	-		
	FEES:	Τ	
		2700-00	14-60
	Water Bldg.	<u>i</u>	
	B.R.L.	<u> </u>	
	TOTAL		14-00
Building Inspector	Approved	VI ha	land.
	Not Approved		
Specification:	was ubbiored.		
Structurel Engineer	Approved_		
	Not Approved_		
Fire Service	Recommended_		
	necommended_ : Recommended_		
INDI	. Necemberged_		
		MA	
	Approved_	#82 -	
APPROVING ENGINEER	Not Approved		

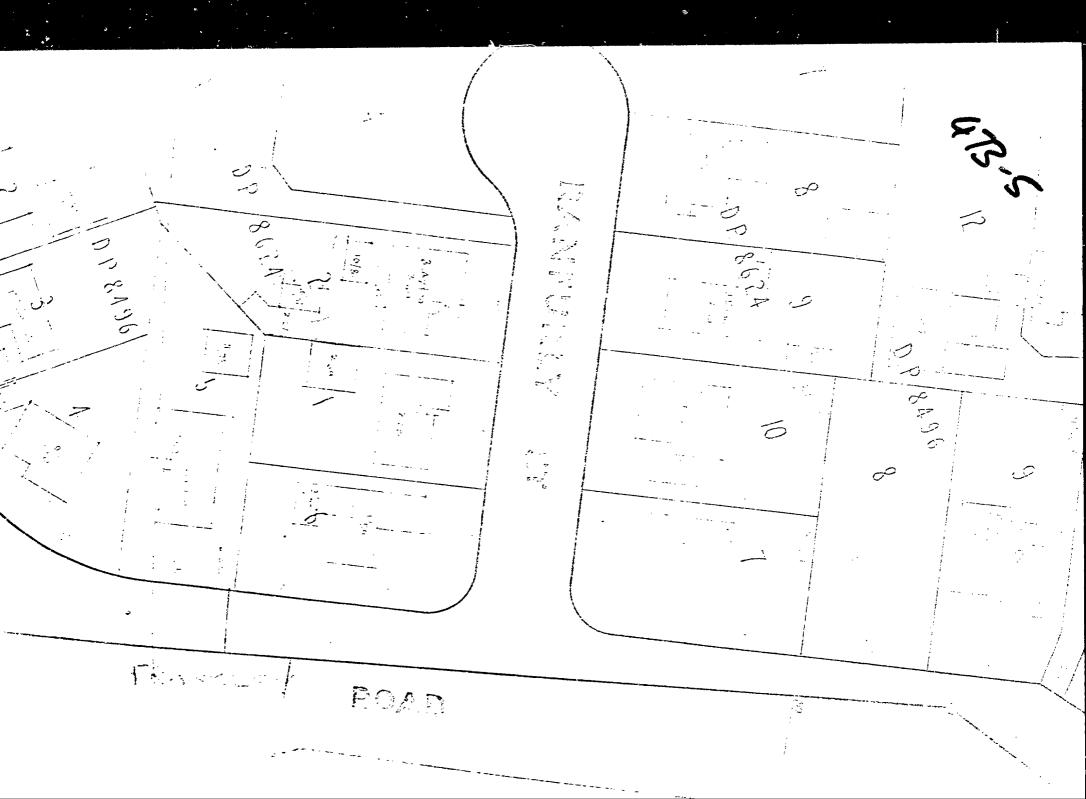

ं पा	zs	ATMIT ATM		
	NEW PLYM			.
FOR OFFICE USE:	File No	とう	Sheet No.	07
	Receipt No. 22			
	Date of Receipt	10 . 81 <u>-</u>	0- 01	
	Date of Receipt.	Zone		<u> </u>
TO THE CITY ENGINE	FR	14	OCT 1981	Date 14 - 10 - 81
APPLICATION FOR E				Lot No. 2
4: (House No.t	Ranfarts S	Street	NP .	D.P. 8624
For exection of Cart	port T Care	van Shelt	**************************************	Sec. No
OWNER B AV	ton	ADDR	ess above	Advess
Proposed Use 615				
Foundation. Consci.		Walls Stal	of the most Roof	Corr Iron
AREA of Site			m²	
ARFA of existing building	<u>ę</u> s	Horris	46 71 M2	
AREA of existing accesso	ry buildings	Garage	32·5 M2	
AREA of Building in app	akelock	Address	3 Te Rima	Place
Designer				
Structural Eng		Address	No. of the second secon	
Building Projects Authority	y Required Yes / No	Supplied Y	es / No	
The second second second second second		\$ 759 15	i .	OFFICE USE ed Value Fees
Total Value of Building	cinaga	\$ 121.12	20370010	1 1 1 1 1 1 1 1 1 1 1 1 1 1 1 1 1 1 1 1
Sanitary Plumbing and Dr Value of Building for Pern		\$		
Water for Building		J		
Building Research Levy o	ព	\$		
Heardings Mth		•		
		1	OTAL FEES BUIL	DING
Starting Date 21-	10-51			L
NAME AND ADDRESS				
	Simy Plac	_		
D 16 1	71014 146			
		Signature of	Applicant.	iBlablock.
		Signature o	f Owner 74	Ty to a

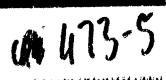

NEW PLYMOUTH CITY COUNCIL. - CITY ENGINEER'S DEPARTMENT

APPLICATION FOR SERVICES, PLUMBING & DRAINAGE

to the City Engineer	Phone No
I wish to apply for permission to carry out the work descri-	hed to the plans and specifications deposited herewith at:
House No. 5 Street Party	D.P. 3624
OWNER Town C. Obergrand	Area of Site
ADDRESS CARLS A SCHARLENGER	Signature of Applicant
Proposed the Clear energy the delight is a	Signature of Owner La Reyle
VEHICULAR CROSSING	When required
Proposed # 27 minutes and many	Position
WATER CONNECTION	
Size of Existing Connection	
Size of Requested Connection	
Distance from L/Boundary	
No. Units served	
SEWER CONNECTION & (STORMWATER)	Floor level of the lowest sanitary fittings ismutres
Size of Existing Connection	*below/above the ground level of the point where the sewer connection
Size of Requested Connection	is required. "Strike out whichever is inapplicable.
Distance from L/Boundary	Depth of sewer req'd
Common Drain	. Yes / No
Stormwater Disposal (specify)	
PLUMBING AND DRAINAGE	
Name of Registered Plumber / Orainlayer	
Value of Proposed Work, Labour Only	Plumbing
Water Supply Materials	P.V.C. Copper Galvanised Iron
Drainage	
Size of Existing Drainage	
Size of Proposed Drainage	
Other Works Proposed	
Stormwater Disposal (specify)	
FOR OFFICE USE	22107
File No. 14 OCT 1981	Check Sht. No FEES Sewer
Date Zone K	Sewer Sht. No. 240 Water
	Veh. Crg

NEW PLYMOUTH CITY COUNCIL

473-5 ASSESSED REQUIREMENTS CITY ENGINEER'S

	415-6		file No.	10 83
Project: Control Corrol Owner: Lily Corrol Address: La Borra 24	Sewer	Sheet No<2	22 <u>10</u> 7_	
Lot No D.P 25	Pite Sec. No.	/	Area of Site:_	
				,
Designations				
Designations = = = = = = = = = = = = = =				
Area of Buildings				
Coverage				
Maximum Height	and wash goods physic plans ". " accepts someth solves .		ng maga datag lama ar-at sarat pray data	
front Mard				
Relat. of Bldg. Size: (1) Rear				
	Yard			i i
Open Space				
Grassed Areas				
Trees	turn grier tire was our only band darb		F. 1 V2	
Building Lines & Street Widenir				
Parking				
Access to Rear of Site				
Accessory Buildings				1
Service Lames & R.O.W				
Erossing Length				
Gross Floor Area of Shops				
Pasid. Accom.				
Le/els of Site				
Las of Yards	SEC-SECTION	GARD	}	
Loading	TOWN PLANNING			
Screening	BUILDING			
Amalgam. of Titles	ORAMAGE			
Remarks:	WATER		1	
			4	
And the second s				
A STATE OF THE STA				
			Approved_ (2)	
		Not	Approved	

S E R V I C E S

A: SEWER CONNECTION	STORMWATER CONNECTION
Existing Service	and the state of t
Required Service	
Location	خلامه مه مه چنو منه چنو نبت بند بند بند بند در د
Depth	
Special Requirement	
Common Drain	
Fee \$	Fee \$
	FEE \$
B: WATER CONNECTION	
Existing Service	
Distance from L/Boundary	Height above Datum
Distance: Main to Boundary	
Boundary to Load	
Required Service	
Meter	
	FEE S-
C: PLUMBING	
3 2 1	2 2 2
	Sinks ShowersTubsOthers
Total Values	P.V.C. Copper Gal. Iron
Supply Pipe Sizes	P.V.C. Copper Gai. Iron
Backflow Prev	
Sther FittingsEstimated Value	Plumbing Fee
ESULMATED VALUEL L.	, sampling i bould a label a label a
DRAINAGE	
Existing Require	
Fittings RequiredCommon Brain	
Septic Tank	
Stormwater	
Estimated Value	Drainage Fee
	gramman
Total Estimated Value P. & D. \$:	FEE \$
TOTAL BOSTONIA TOTAL TOTAL	
D: VEHICULAR CROSSINGS	
Type of Footpath Condit.	ion
Kerb & Channel	
Existing Crossing Lordel	
New Crossing Position	on
Strengthen Path Sq.Ycs Level	
OTREET WORKS SEE	DEPOSIT DAMAGE FEE S :


REMARKS : CORRESPONDENCE : AGREEMENTS SPECIFIC REQUIREMENTS

	ApprovedNot Approved
	Approved Maijan Not Approved
Licewed 31/19kl	Approved Approved Not Approved
fish broken in several flam	Approved Not Approved
	Approved Not Approved

E : HEALTH & BY-LAWS		•	
Areas			
Light			
Ventilation			
Remarks:			
	emakan kalimanan matuuri kan sahadi kan sahadi kansalangan dagata () ka kanpa sahaya sa da		
			
	C. alo Angroyed	OW 2	2/10/81
	Reid 22/10 Approved		·
	• • • • • • • • • • • • • • • • • • • •		
F: DANGEROUS GOODS			
Domestic or Commercial			
Storage Capacity & Location			
Licence RequiredYee/No			_
	Approved	//	
	Not Approved		
• • • • • • • • • • • • • • • • • • • •			
G : BUILDING			
Remarks:			
	_		
			_
	turking mendengan termenangan di mendelakan di mendelakan di mengengan di mengengan di mendelakan di mendelakan		
			
	hangamata (1966-1966-1967) — 1971 — 1971 — 1981 — 1 — anthrophophophophophophophophophophophophopho		
	FEES:	~	
	Bldg.	76C 459	10.00
	Water Bldg.	<u></u>	70.00
	B.R.L.	<u> </u>	
	TOTAL	\$	10.00
			
Uilding Inspector	Approved	BIAN	18:01
	Approved_ Not Approved_		
panification.	Not Approved_		
pecification:		·	
tructural Engineer	A		
tructural Engineer	Approved_		
ies Sarvice	Not Approved_		
ite Service	Recommended_		
	Not Recommended_	-/	
PERMIT NO. 48171	2		
23.40	El Approved_	M	
APPROVING ENGINEER	Not Approved_	27/10/8	7.
	o Approved	- +	

DRAINAGE AND PLUM	ABING REGISTER
OWNER / V. SISARICH. ADDRESS BUILDER SELF. PLUMBER / L. MURCH. DRAINLAYER DITTO. NATURE OF WORK NEW ~	PERMITS PLUMBING DRAINAGE VALUE 227/8.
DRAIN TESTED 3 / 5 / 60. PLUI FALL AND DESCRIPTION NORMA	

DRAINAGE PLAN SCALE

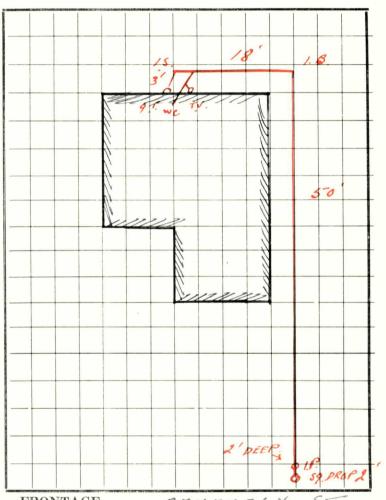

FRONTAGE

14 Images.

BUILDING CONSENT 51494A

PROPERTY ID

023498

ADVICE OF COMPLETION OF BUILDING WORK

SECTION 43(1) - BUILDING ACT 1991

Under Section 43 of the Building Act 1991 the owner of a building is required to notify us when the work has been completed to the extent required by a Building Consent. Upon completion of the work please complete this form and return it to the New Plymouth District Council in the postage paid envelope attached.

On receipt of the form the Council will, if it is satisfied that the work complies with the Building Code, issue a Code of Compliance Certificate. Where any work is found not to comply a Notice to Rectify will be issued.


The Code of Compliance Certificate is an important part of the building process as well as being required by law it helps determine that not only has the work been completed but it also complies with the requirements of the Building Act.

Depending on the extent of the work covered under the Building Consent it may be necessary to make arrangements to obtain access to the site or building.

Under Building Consent No: 51494

Final inspection required: (Day/Date)	Street, New Plymouth
Project Location Street Address 5 Ronfu	ly Street, New Plymath
(Cross each applicable box and attacl	n relevant documents)
You are hereby advised that:	Part only as specified in the attached particulars of the building work under above Building Consent is believed to have been completed to the extent required by that Consent
You are requested to issue:	A Final An Interim
Code Compliance Certificate according below)	ly (except where a Code Compliance Certificate has been issued by a Building Certifier see
The attached particulars include:	Building Certificates Producer Statement A Code Compliance Certificate issued by a Building Certifier
FORMAL DECLARATION - (Plea	
This request for CCC is made by me a. Signature:	Date: 30-5-03
	en authorised by the owner to make this request for CCC
Signature:	Date:
1	

Joanne Dodunski 5 Ronfurly Street, New Plynoutin.

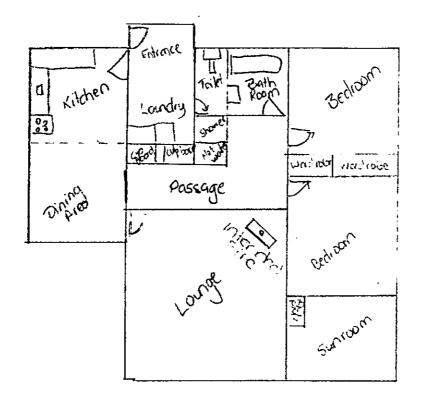


No well-Bock or word Rooter included
Metro-Promeer Fire with Flucthield.

Single Story Dwelling

		4
PLANS AND SPT WEIGHTING AFFORM AND CONSTRUCTION AS IN A REGULATIONS OF WEIGHTING AFFORM AND REGULATIONS AFFORM AND RESULTATIONS AFFORM AND REGULATIONS AFFORM AN		HINGARIA DI LA Perendia Puli Bund Occidina
DISTRICT COUNCIL	(H	2ATES

THESE PLANS AND SPECIFICATIONS ARE THE PROPERTY OF THE NEW PLYMOUTH DISTRICT COUNCIL.

DRAINAGE PLAN SCALE

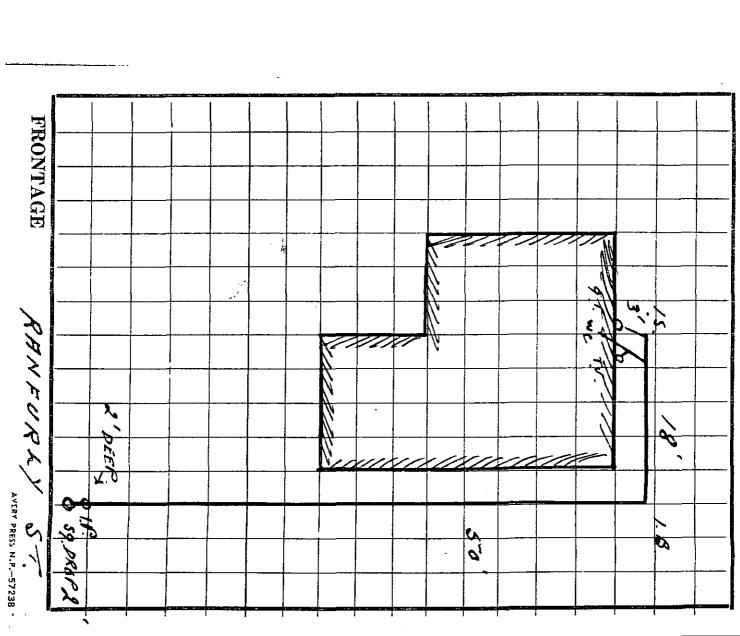

PRE INSTALLATION

Prior to installing your Metro insert into a masonry chimney, it is important that certain clearances and other requirements are complied with as detailed below:-.

Chimney - The chimney must be swept and checked for: -

- Cracks and general overall condition, with repairs carried out if necessary by a suitably qualified person.
- Cavity dimensions to ensure the fireplace insert will fit, it is usually necessary to remove the fire bricks from the lower chimney cavity.
- The base of the chimney cavity on which the Metro fireplace insert will rest must be level, if it is not, it should be levelled using mortar.
- If an ash removal door exists in the base of the chimney it should be sealed shut to prevent air entering the cavity.

Mantle – If a timber or combustible mantle shelf exists above the fireplace opening, it should be a minimum distance above the top of the Metro's fascia, minimum distances are:-

- Metro Hi output Insert = 460mm
- Metro Compact Insert = 400mm

If less than the above minimum specified, a deflector or heat shield will be required to be fitted under the mantle.

FLOOR PROTECTOR REQUIREMENTS


Metro fireplace insert's are designed to be installed direct onto a concrete base. A floor protector is required to project in front of the Metro and must extend a minimum of 200mm to each side of the door opening making the minimum floor protector width 825mm. The minimum floor protector projection forward of the Metro is dependant on the height of the fireplace insert above the combustible floor. The following schedule of floor protector projections is measured from behind the Metro fascia being the total floor protector depth as shown in diagram 4 below. Note, the heights specified above the combustible floor can be achieved by:

- The thickness of the floor protector
- Or by raising the fireplace insert
- Or a combination of the two

Insert Raised	Minimum Floor I Metro Compact	Protector projection and Type Metro Hi Output
10mm	439mm insulated	455mm insulated
15mm	425mm insulated	445mm insulated
20mm	417mm insulated	436mm insulated
25mm	403mm insulated	424mm insulated
30mm	392mm insulated	408mm insulated
35mm	381mm insulated	396mm insulated
40mm	367mm insulated	366mm insulated
41mm & above	N/A	260mm ash hearth
45mm	356mm insulated	
50mm & above	260mm insulated	

DIAGRAM 4

Fascia Model	Base Width	Body Width
H.T & V.E Fascia	810mm	810mm
Trad Fascia	900mm	810mm

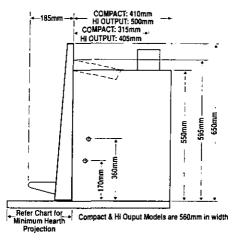

Important

Metro fireplace inserts are tested to and comply with NZS7421:1990 incorporating appendix "J" when installed in accordance with the installation and operation manual supplied with every Metro woodfire.

- A minimum flue length of 4.2 metres of 150mm diameter stainless steel flue is required.
- All flue joints must be sealed and riveted.
- · Metro fireplace inserts are available with optional 3kW or 4kW wetbacks.
- · Seismic restraint of the fireplace insert is required.

PIONEER

MANUFACTURING LIMITED


P.O.Box 11, Inglewood New Zealand Phone 06-756 6520 Fax 06-756 6540


Email: info@woodfire.co.nz Website www.woodfire.co.nz

CLEARANCE CHART

Metro woodfires are tested to and comply with NZS7421:1990 or AS/NZS2918:2001 if installed as detailed in the chart below: -

- Measurements listed below are the minimum required, stated in millimetres. Measurements are taken from the following reference points as illustrated: -
 - From the nearest combustible wall or surface (A, B, D, E,G, H)
 - From the Metro's flue centre (A, B, C, D)
 - From the outermost point of the Metro's cabinet / construction (E, F, G, H)
 - To the edge of the ash Floor Protectors non-combustible surface (C, F, I, J, K, L, M)
- The Metro Tiny-Trad, Metro Pioneer and Metro Pioneer Traditional have also been tested with optional "flueshield side extensions". When fitted into and alcove situation not projecting forward of the Metro with flueshield side extensions fitted, clearances "B" and "G" reduce by 80mm for the Pioneer and Pioneer Traditional and 100mm for the Tiny-Traditional.

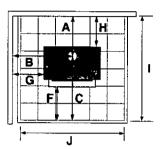


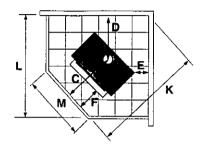

Installation Clea	arances mm	Α	В	С	D	Ε	F	G	Н		J	K	L	М
TINY-TRAD	With Flueshield**	225	445	. 480	305	25	100	200	75	705	650	920	875	. 650
	Without Flueshield	605	545		595	315	100	350	455	1085	0.00	1320	1165	
PIONEER &	With Flueshield**	200	595	480	400	85	100	300	50	680	825	1045	950	. 660
PIONEER TRAD	Without Flueshield	580	595		595	280	100	300	430	1060	02.1	1320	1145	. 000
PIONEER REAR	OUTLET	N/A	565	N/A	N/A	100	100	270	60	690	825	1070	965	660
X-TREME &	With Flueshield**	230	575	525	455	110	100	240	80	, 755	905	1165	1065	740
X-TREME TRAD	Without Flueshield	800		595	250	100 1	240	650	1325	י כטכ	1365	1205	, 40	
ASPIRE &	With Flueshield**	230	575	525	455	110	100	240	80	, 755	905	1165	1065	740
ASPIRE TRAD	Without Flueshield	800	575	223	595	250	100	240	650	1325		1365	1205	′~~
WEE RAD	With Flueshield**	200	555	480	400	80	100	250	50	680	825	1045	950	660
WEE RAD	Without Flueshield	580	555		600	280	100	250	430	1060		1320	1145	. 550
RAD	With Flueshield**	230	575	525	455	. 80	100	200	80	755	905	1165	1065	740
KAD	Without Flueshield	800	575	323	625	250	100	200	650	1325	905	1365	1205	740
MEGA RAD	With Flueshield**	270	675	625	500	125	100 -	300	120	895	905	1325	1175	740
INICON INAD	Without Flueshield	540	675	023	595	220	100	300	390	1165	905	1470	1270	770

^{**} Ensure the flueshield is fitted so that the lower flue is NOT directly exposed to the rear wall, refer to the instructions supplied with the flueshield.

Dimensions mm	N	0	Width	Depth	Height
TINY-TRAD	295	485	490	530	665
PIONEER & PIONEER TRAD	295	485	590	530	665
PIONEER REAR OUTLET	295	485	590	530	660
X-TREME & X-TREME TRAD	340	530	670	575	715
ASPIRE & ASPIRE TRAD	340	530	670	575	715
WEE-RAD	295	485	607	530	665
RAD	353	543	750	575	745
MEGA RAD	353	543	750	675	745

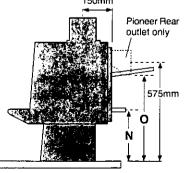

Note: Both wetback connections are 150mm left of the flue centre, facing the Metro / wall.

FLOOR PROTECTORS

Freestanding Metro Woodfires do not require an insulating Floor Protector, as they are tested and comply with the minimum "ash hearth" requirement of NZS7421:1990, being:-

"A non combustible surface extending 200mm in all directions directly below the door opening"

Note: - The minimum Floor Protector sizes are specified in the clearance chart above

- A Floor Protector can include ceramic tiles with grouted joints fixed directly onto a wooden floor, or a sheet of toughened glass, panel steel or any other non combustible material laid directly onto a wooden floor.
- If being installed onto a concrete or other non combustible floor, no Floor Protector is required.







COPYRIGHT: Cadastral information sourced from Land Information New Zealand data. Crown Copyright Reserved.

DISCLAIMER: NPDC as sumes no responsibility for the completeness or accuracy of the data displayed

HORIZONTAL DATUM New Zealand Geodetic Datum 2000

MAP PROJECTION

New Zealand Transverse Mercator

0 4.75 9.5 19 L L L L MILES Print Map



Date: 3/14/2023