

PROPERTY INFO PACK

13 HUNTAWAY LANE, DUNSANDEL

PREPARED BY ANDY WILLIAMS

OFFICE ROAD

13 HUNTAWAY LANE, DUNSANDEL

DEBUTING IN DUNSANDEL ESTATE

FEATURES:



开 150m2



3



1



PROPERTY DETAILS:

Address: 13 Huntaway Lane, Dunsandel

Legal Description: Lot 18 DP 571088

Property Type: House

Sale by: Enquiries over \$699,000 **Close To:** Dunsandel Township

PROPERTY DESCRIPTION:

Streamlined simplicity and effortless style are achieved with significant ease at this brand-new residence delivering instant gratification and enjoyment in Dunsandel Estate.

Enjoying the spaciousness of the country, this generously proportioned 900sqm site serves up backyard expanse, making it a perfect solution for families seeking scale and the relaxed pace of a rural community.

Freshly finished and equipped with a Master Build guarantee, this property has been completed to a superb specification, offering tiled bathrooms and contemporary practicality prerequisites, including a walk-in kitchen pantry.

Together with a separate w/c and a deluxe family bathroom affording a standalone tub and shower, accommodation comes by way of three bedrooms benefiting from in-built storage. The master excels, enjoying a walk-through wardrobe to an ensuite comforted by underfloor heating.

Everyday life unfolds in the thoughtfully configured open-plan living zone, anchored by the modern kitchen and substantial breakfast bar. The dining area and lounge naturally interact with this culinary hub and extend outdoors through a sizeable stacker door to the patio and newly seeded lawn, kept secure by traditional timber fencing.

The internal access double garage is armed with an insulated door and incorporates the laundry as well as outdoor access for elevated functionality.

Peacefully located a few hundred metres from the centre of the township with its domain and selection of amenities, you're also near SH1, presenting straightforward access to Rolleston and placing you within 30 minutes of Christchurch.

This newly constructed home is one opportunity not to be missed.

Visit www.officeroad.co.nz for more information.

Please be aware that this information may have been sourced from RPNZ/Property Guru/Land Information New Zealand/ Local Council and we have not been able to verify the accuracy of the same. Refer to our Passing Over of Information Statement located in the footer menu of www.officeroad.co.nz

Office Road Real Estate Powered by Agent X (2021) Licensed Agent REAA 2008

PROPERTY PHOTOGRAPHY













PROPERTY PHOTOGRAPHY















CERTIFICATE OF TITLE

13 HUNTAWAY LANE, DUNSANDEL

PREPARED BY ANDY WILLIAMS

OFFICE ROAD



RECORD OF TITLE UNDER LAND TRANSFER ACT 2017 FREEHOLD



R.W. Muir Registrar-General of Land

Guaranteed Search Copy issued under Section 60 of the Land Transfer Act 2017

Identifier 1033522

Land Registration District Canterbury

Date Issued 11 April 2022

Prior References CB18F/1468

Estate Fee Simple


Area 900 square metres more or less
Legal Description Lot 18 Deposited Plan 571088

Registered Owners

Marquerite Van Der Helm and Christopher Sean Brown

Interests

Land Covenant in Covenant Instrument 12429578.9 - 11.4.2022 at 12:12 pm

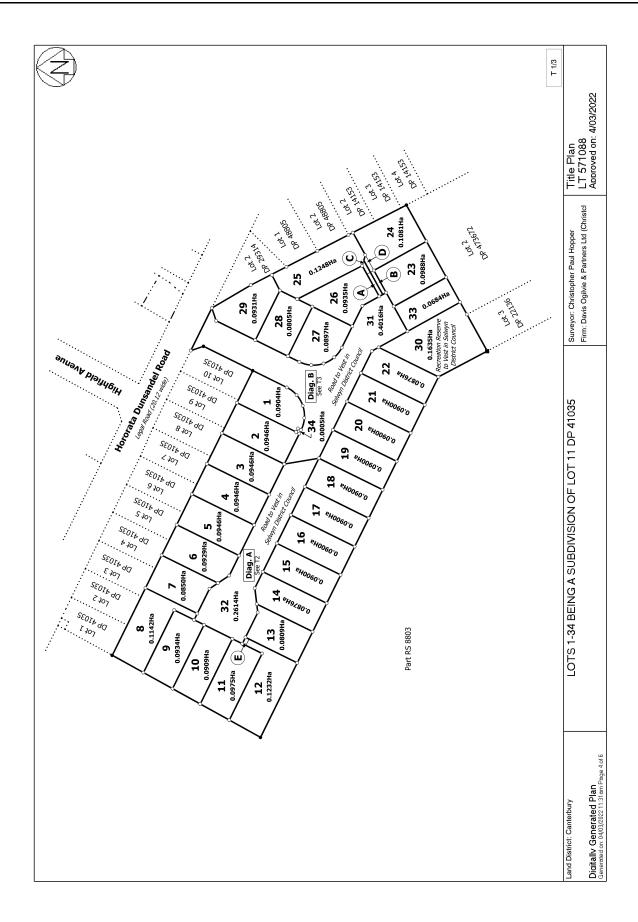



COUNCIL RATES & FEES

13 HUNTAWAY LANE, DUNSANDEL

PREPARED BY ANDY WILLIAMS

OFFICE ROAD

(http://www.selwyn.govt.nz)

Current Rating Year (2022/2023) Make a payment (/rates/properties/pay?valuation_id=2412006331)

Valuation No. 24120-06331

Location 13 Huntaway Lane, Dunsandel

Legal Description Lot 18 DP 571088

Certificate of Title 1033522

Ward No. 3

Zone 9A

Use 99

Category RV

TORAS 111000

Property Area 0.0900

(hectares)

Current Rating Valuation

Land Value \$220,000

Improvements Value \$0

Capital Value \$220,000

Nature of (/rates/improvements)

Improvements

Rates Information

Current Rating Year 2022/2023

Current Year Rates Instalments

Instalment 1. \$65.90

Instalment 2. \$65.90

Instalment 3. \$65.95

Instalment 4. \$65.90

Current Year's Rates \$263.65

Previous Year's Rates \$0.00

Rates for Current Year 2022/2023

Туре	Description (Basis)	Differential	Factor	Rate	Estimated Amt
011	General Purposes Rate (C)	District	220,000.00	0.00074957	\$164.90
123	General (C)	District	220,000.00	0.0003401712	\$74.85
152	Works and Services (C)	District	220,000.00	0.00000705	\$1.55
297	Transport and Development (C)	Greater Christchurch	220,000.00	0.0000032	\$0.70
352	Freshwater Management (C)	Selwyn-Waihora Water Zone	220,000.00	0.00000737	\$1.65
401	Biodiversity Land Drainage & River Works (U)		1.00	20.00	\$20.00
Total					\$263.65

History

Year	Land Value	Capital Value	Annual Rates



PROOF OF INSURANCE

13 HUNTAWAY LANE, DUNSANDEL

PREPARED BY ANDY WILLIAMS

OFFICE ROAD



Contract Works Single Project

CERTIFICATE OF INSURANCE

Attention: Date: 10 August 2022

INSURED

Insured parties: Grant Property Group Itd as principal

AGL Builders Itd as main contractor

Interested parties: BNZ and Chris Brown & Marguerite Van der Helm

Policy number: 15-0275337-CAR

Contract description: New dwelling in the course of construction

Contract site: 13 Huntaway Lane, Dunsandle

PERIOD OF INSURANCE

Construction period: 25/8/2022 to 25/8/2023

Maintenance period: 12 months

SUMS INSURED

Contract price: \$620,000

Value of principal supplied materials \$62,000

Demolition and debris removal \$62,000

Professional fees \$62,000

Increased costs during construction \$31,000

Escalation during reconstruction \$31,000

EXCESSES

Standard \$1,000

Burglary/malicious damage/theft \$ 2,500

Natural disaster 5% of constructed value, minimum \$ 5,000

SPECIAL CONDITIONS (IN ADDITION TO STANDARD POLICY WORDING):

This certificate provides limited details. The insurance in this certificate is subject to the terms, exceptions, conditions and warranties of the NZI Annual Contract Works Policy Wording as modified by the endorsements and clauses noted in the Special Conditions above (if any) and the Policy Schedule. A copy of the Policy Wording is available on request. In the event of inconsistency between this certificate and the Policy Wording and Policy Schedule, the latter two documents will apply.

Signed for NZI - A business division of IAG New Zealand Limited



Signature: Peter Fridd Date: 10/8/2022



ADDITIONAL DOCS

13 HUNTAWAY LANE, DUNSANDEL

PREPARED BY ANDY WILLIAMS

OFFICEROAD

AGENT X (2021) LTD - LICENSED AGENT REAA (2008)

Approved Building Consent Documents

Please Note: A copy of the stamped approved documents must be available on site for all inspections.

Inspection booking timeframes


Call received	before 3pm inspection	after 3pm inspection
	will be done	will be done
Monday	Wednesday	Thursday
Tuesday	Thursday	Friday
Wednesday	Friday	Monday
Thursday	Monday	Tuesday
Friday	Tuesday	Wednesday

Building inspections and enquiries phone: 03 347 2839

Please ensure all work for inspection is ready the day before. Incomplete work requiring re-inspection will incur an additional inspection fee.

Planning Approved

8/08/2022 hillsl

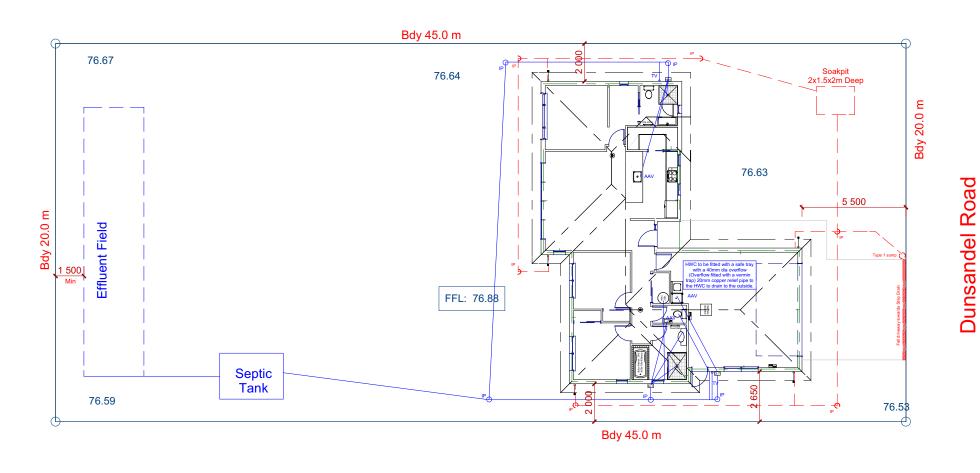

LEGEND LEGEND. Sewer Pipe S/W Pipe Down Pipe GT Gully Trap Terminal Vent

SITE PLAN NOTES

Refer to Drainage Plan for specific drainage

implement where required.

appropriate approved outfall.

SITE INFORMATION

Zone Wind High Earthquake Durability

As Per Truss Design

BUILDING AREA AND SITE COVERAGE

Net Site Area = 727.0 m² 150.0 m² Building Area (O/V) = 20.6 % Actual Site Coverage=

Rock Soakpit scale 1:20









Crown of Road :76.53

Consent Plans

8/08/2022

14

Refer to sediment control plan in specification and Convey surface water from sealed drive areas to an Dimensions are shown to cladding face




ROOF & WALL CLADDING

O/F -148 55 m²

Roof -25° Corrugated Coloursteel Roof

(Clay Bricks)

70mm Brick veneer on a 50mm Cavity Weatherboard over cavity on a 20mm Cavity

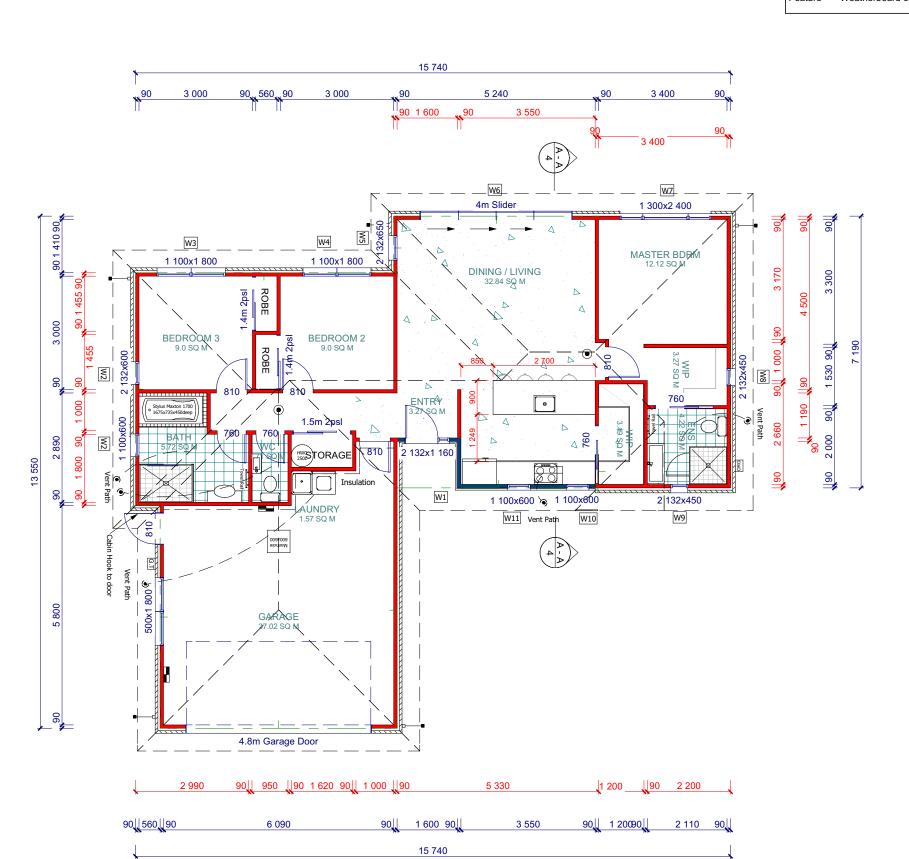

GENERAL FLOOR PLAN NOTES

SMOKE ALARMS



Smoke Alarms to be fitted within 3.0m of sleeping areas and on Escape routes, as indicated on plan. Refer to Construction Schedule (Page 2 & 3) in the Specification for more information.

MISCELLANEOUS:

Dimensions shown are to the frame,

GIB thickness not shown.

Refer to Construction Schedule (Page 2 & 3 of Specification) for additional construction information.

Entry through external doors

Mechanical ventilation

Air Seals to have PEF rod & low expansion foam All windows and doors centered in room unless

FOUNDATION SYSTEM

3604 Single Pour Foundation

WALL FRAMING -designed to high wind zone 2420 mm Stud Height:

Exterior Walls: 90x45mm studs @ 400 mm crs

Interior Loadbearing wall: 90x45mm studs @ 600 mm crs

90x45 @ 800 crs Dwangs Ext:

Non loadbearing: 90x45cmm studs @ 600 mm crs Dwangs Int: 90x45mm @ 1350mm crs max

LINTELS AND BEAMS

Lintels and beams can be found on the Truss Design

Watergate Building Wrap, refer to manufacturers

DOORS

Internal Height:

INSULATION

Pink Batts R2.4 Wall Batts Wall -Ceiling -Pink Batts R3.6 Ceiling Batts

WALL AND CEILING LININGS

Wall -Standard 10mm GIB

(unless required for bracing) Ceiling -Standard 13mm GIB

13mm GIB Aqualine (bathrooms) 10mm GIB Aqualine Bathroom -

Corner Finish -Square

FLOOR FINISHES Carpet, Tiles, Vinyl (Polished Concrete to

Entry/ Kitchen/Dining and Living Areas)

INTERIOR AND EXTERIOR JOINERY

Double Glazed Vantage Joinery -

Standard Aluminium Joinery Shelf and rail to wardrobes

WATER HEATING

Electric Hot water system

KITCHEN COOKTOP Electric Hobb

ROOF CLADDING AND STRUCTURE

Purlins - 70x45 SG8 H1.2 @ 900crs

GUTTER/FASCIA/DOWNPIPES/SOFFITS

Metalline Quad Gutter Gutter -Fascia -Metalline 185 Fascia Marley 80mm Dia PVC Downpipes -

Hardiflex 4.5mm










LBP # 105491

1:100

2315

2 14

8/08/2022

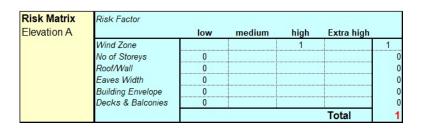



GENERAL ELEVATION NOTES


Air Barrier to unlined wall and gables, refer to the Construction Schedule in the Specification for type

This sheet to be read in conjunction with the Risk

Driveway to fall from 20mm max below garage rebates (By Others).


Key SS: Security Stay SG: Safety Glass

Elevation A

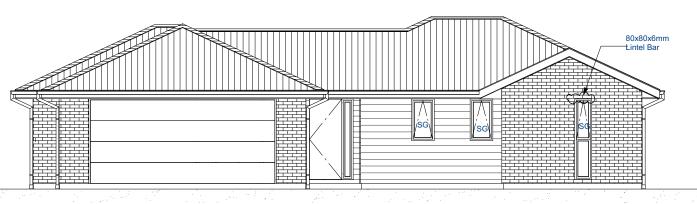

Risk Area 2	Risk Factor					
Elevation B		low	medium	high	Extra high	
	Wind Zone			1		1
	No of Storeys	0				
	Roof/Wall	0				
	Eaves Width		1			
				3		
	Building Envelope Decks & Balconies	0				
					Total	

Elevation B

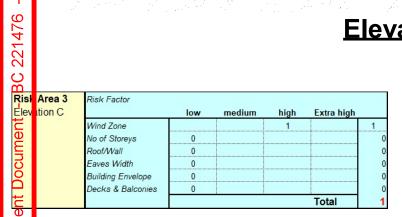



Elevation C



Risk Area 4	Risk Factor					
Elevation D		low	medium	high	Extra high	
	Wind Zone			1		1
	No of Storeys	0				(
	No of Storeys Roof/Wall	0				
	Eaves Width	0				
	Building Envelope	0				
	Building Envelope Decks & Balconies	0				
					Total	1

Elevation D







ect:	C and M Van Der Helm
	Proposed Dwelling At:
	Lot 18
	Dunsandel Road, Dunsandel

Elevations	
Consent Plans	


Drawn: Jeremy Harrison LBP # 105491	
Scale: 1:100	

2315

14 8/08/2022

- Pg 4 of 19 - 8/08/2022

Approved Building Conse<mark>nt Docum</mark>

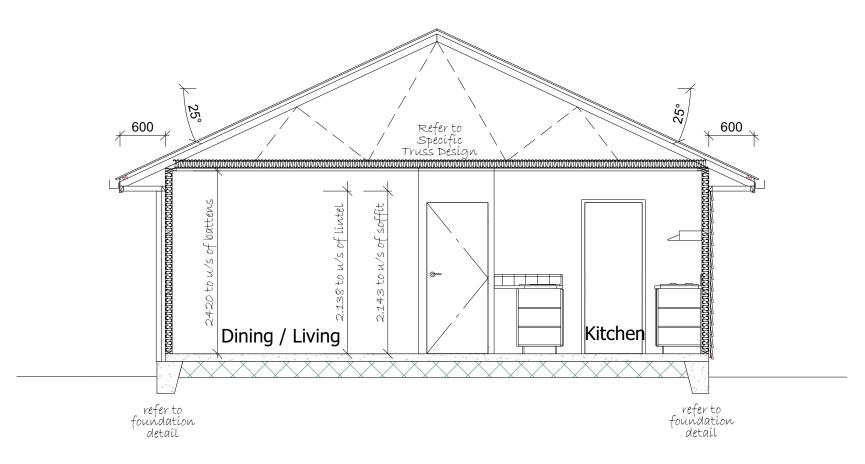

Cross Section A - A









C and M Van Der Helm Proposed Dwelling At:

Cross Section

Consent Plans

1:50

2315

24/07/2022

4 14

LEGEND

Refer to the Construction Schedule (Page 2 & 3) in the Specification for sizing of Building Elements.

1 - Corrugated Colorsteel roofing by Metalcraft on self supporting ThermaKraft 215 roof underlay on 70x45mm SG8 H1.2 Purlins @ 900crs fixings 1/10g self-drilling screw,

2 - Metalcraft fascia & quad gutter system with 4.5mm Hardies soffit lining on 70x35mm H1.2 eaves bearers on edge fixed to ribbon board.

General Notes:

80mm long

building

3 - 4.5mm Hardies Soffit lining 4 - 13mm Standard GIB ceiling lining to underside of Timber ceiling battens @ 600 crs with R3.6 Pink Batts insulation.

(Aqualine to wet areas).

6 - Weatherboard with

of each end of the plate.

5 - 70 Series Brick Veneer on a 50mm cavity (refer to specification) Watergate Plus

wrap on stud framing with R2.4 Pink Batts insulation & 10mm Std. GIB wall lining

20mm cavity (refer to manufacturers details). Watergate Plus building wrap on stud framing with R2.6 Pink Batts insulation &

10mm Std. GIB wall lining (Aqualine to wet

7 - Bottom Plate fixings: Lumberlok bottom plate fixing anchors as per manufacturers spec's @ 900mm crs on all external walls and within 150mm

75mmx4mm dia shot fired fasteners @ 600mm crs and within 150mm of each end of the bottom plate to interior load bearing walls. DPC between bottom plate & floor slab (Refer to Mi


Tek spec's attached for specific bottom plate fixing

8 - Studs 90x45 @ 600crs SG8, Dwangs @ 800crs. (exterior walls) unless otherwise stated

9 - Studs 90x45 @ 600crs SG8, Dwangs @ 800crs. 2 min. (interior loadbearing & non-loadbearing walls) unless otherwise stated

details required for bracing lintels)

7 430

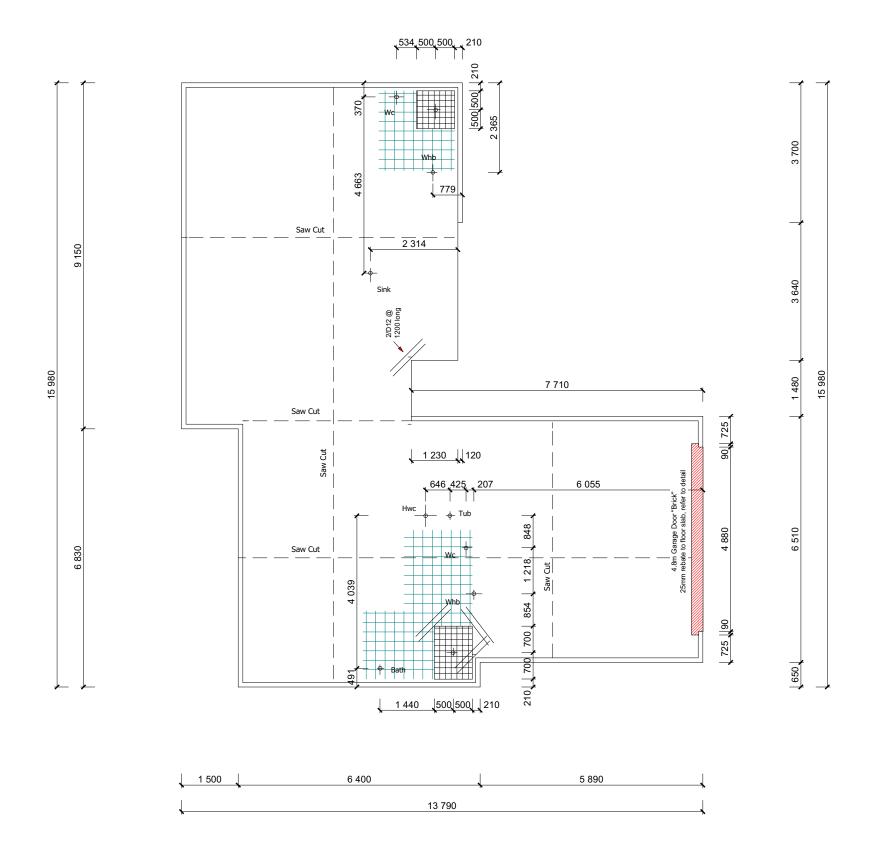









Foundation Plan **Consent Plans**

1:100

2315

GENERAL FOUNDATION NOTES 1) All dimensions over foundation face. Allow 120mm rebate) 70mm veneer & 50mm cavity. 2) No construction joints / shrinkage control joints

5) Supplementary reinforcing to internal corners to comply with NZS 3604:2011 clause 7.5.8.6.4. 6) W/C location indicated on plan has assumed a 160mm offset from internal frame line, please consult manufacturer's documentation to confirm offset. Contractor to consult manufacturer's documentation to determine the correct location for all wastes positioned through floor slabs.

) Gully trap positions indicated on ground floor plan 8) Earth bar to be bonded to the reinforcing mesh 9) Refer to Truss design for exact location of slab

10) Flexible silicone bondage sealer to fill the saw cuts through vinyl floor areas.

BOTTOM PLATE FIXING

Bottom Plate fixings: Lumberlok bottom plate fixing anchors as per manufacturers spec's @ 900mm crs

on all external walls and within 150mm of each end

75mmx4mm dia shot fired fasteners @ 600mm crs and within 150mm of each end of the bottom plate

DPC between bottom plate & floor slab (Refer to Mi Tek spec's attached for specific bottom plate fixing

REINFORCING

PROTECTION OF FIXINGS

Fixings shall comply with NZS 3604:2011 Section 4

CONCRETE STRENGTH

All concrete to comply with NZS3604:2011 Section

All reinforcing is to be Ductility Class E, in

under marked tile areas where possible. 3) The maximum plan dimension of concrete between shrinkage control joints is 6m with mesh to slab. (Standard joint to be formed with 25mm min sawcut & free joint to be at 24m crs max & as per detail CON001AFL). 4) No saw cuts under length of load bearing and bracing walls. (As fixing may not achieve full strengtl

if embedded in sawcuts).

thickenings

of the plate.

to interior load bearing walls.


accordance with NZS 4671

Durability Tables 4.1-4.3

4 Durability Clause 4.5.2

details required for bracing lintels)

24/07/2022

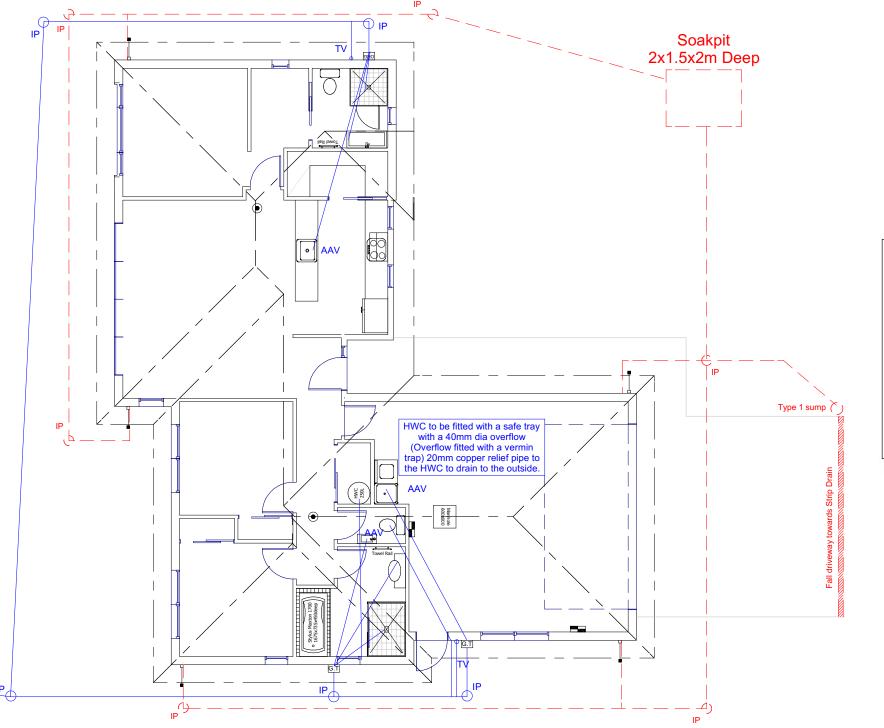



LEGEND.	
Sewer Pipe	
S/W Pipe	
Down Pipe	DP
Gully Trap	GT
Terminal Vent	TV
Vent	V
Inspection Point	IP
Air Admittance Valve	AAV


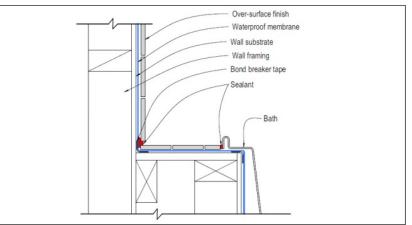


Figure 34: Bath with tiled surround








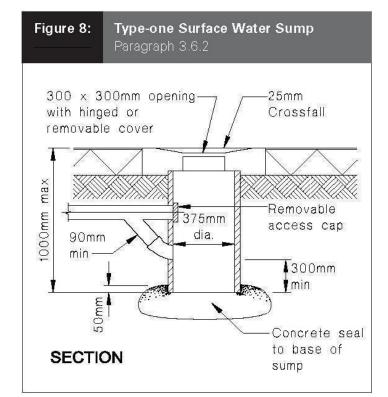



Drainage Plan
Consent Plans

Drawn: Jeremy Harrison LBP # 105491
Scale: 1·100

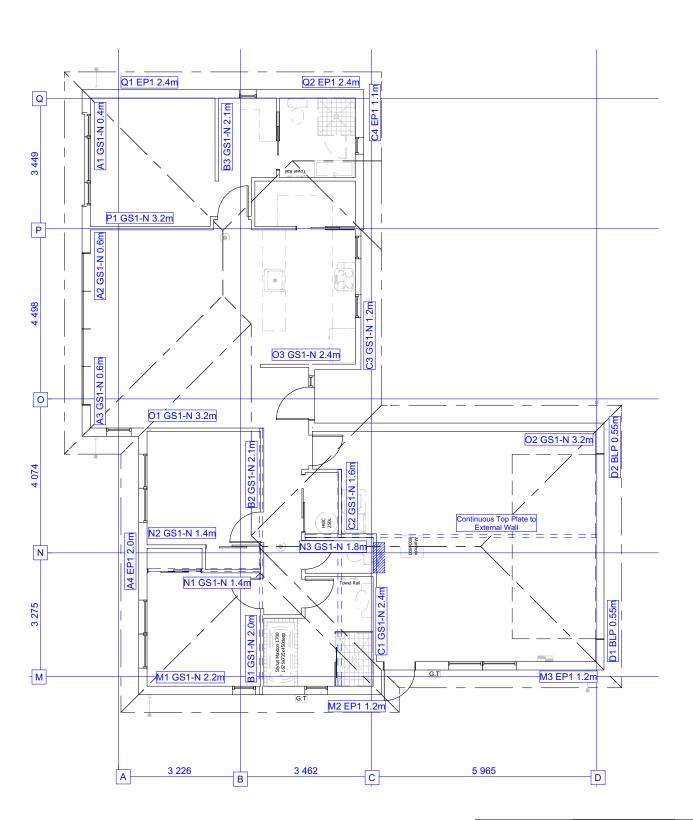

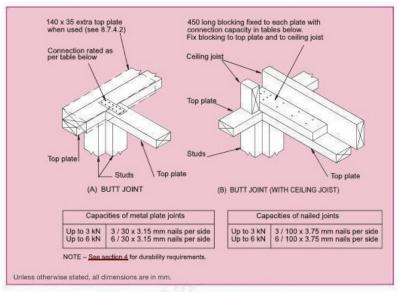


Figure 8.16 - Connecting top plates to external walls at right angles - Walls containing bracing (see 8.7.3.4)

GENERAL BRACING NOTES

Bracing plan to be read in conjunction with supplementary bracing calculations

Refer to the supporting documents in the specification for purlin/batten fixing, truss fixing, stud to top plate fixing & lintel fixing schedules.


To be read in conjunction with minimal length bracing detail TAJ002AWA

BRACING SYSTEM

Wall bracing designed in accordance with NZS 3604:2011 & GIB Ezybrace system

Designed to: Wind:

Earthquake:

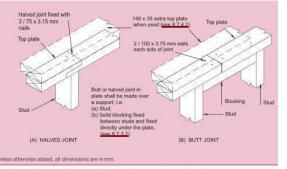



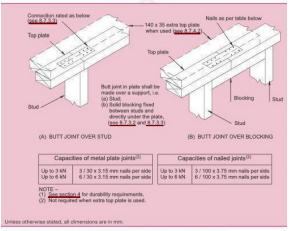


Figure 8.15 - Connecting top plates in line - Walls containing bracing (see 8.7.3.3)

LUMBERLOK® EASY-FIX

A SIMPLE ON-SITE GUIDE FOR 3kN, 6kN & 12kN LOADS AS SPECIFIED IN NZS 3604:2011

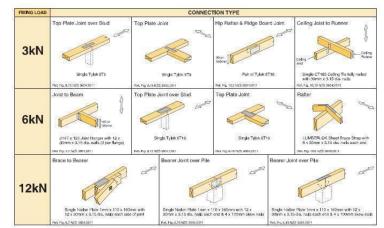

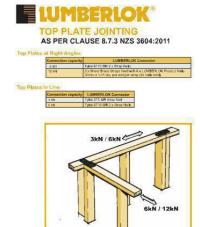





C and M Van Der Helm Proposed Dwelling At: Dunsandel Road, Dunsandel **Bracing Plan**

Jeremy Harrison LBP # 105491

2315

10/06/2022

Consent Plans

1:100



8/08/2022

9 of 19

Pg

221476

BC


Approved Building Consent Document


A pair of tensioned and crossed LUMBERLOK Strip Brace over top chords/rafters installed @ 45° ± 5° to the rafter or purlin line.


1 x 30mm x 3.15 dia. nail at crossing (after tensioning)

When purlin depth above truss chord is 50mm or less, Strip Brace can be installed over top of purlins. Fix with 1 x 30mm x 3.15 dia. nails each end

5 x 30mm x 3.15 dia. nail at the purlin closest to the rafter/truss crossing.

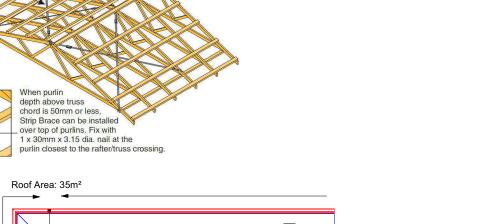

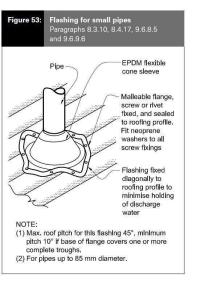

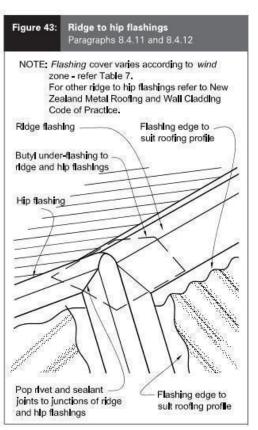

GENERAL ROOF PLAN NOTES

Refer to the Construction Schedule (Page 2 & 3) in the Specification and the manufacturer's specification attached for the gutter and down pipe rainfall catchment area calculations.

LSB - Lumberlok Strip bracing as per Lumberlok Roof Bracing Specification

ROOF CLADDING

Roof - 25° Corrugated Colorsteel Profile on Thermakraft 215 roof underlay

TRUSS FIXINGS

Refer to the Truss design for truss fixings

PURLINS OR BATTENS

Purlins: 70x45 SG8 H1.2 @ 900crs, fixings 1/10g self-drilling screw, 80mm long End span of purlins to be 600 crs as per E2 Table

TOP PLATE FIXING

Use Lumberlock top plate fixing chart attached to the main specifications to determine top plate fixings


TIMBER GRADE


Timber members specified on these drawings are to be a minimum of strength of SG8 graded as per

PROTECTION OF FIXINGS

Fixings shall comply with NZS 3604:2011 Section 4
Durability Tables 4 1-4 3

VALLEY BOARDS		
Thickness:	19mm	
Timber Treatment:	H1.2	

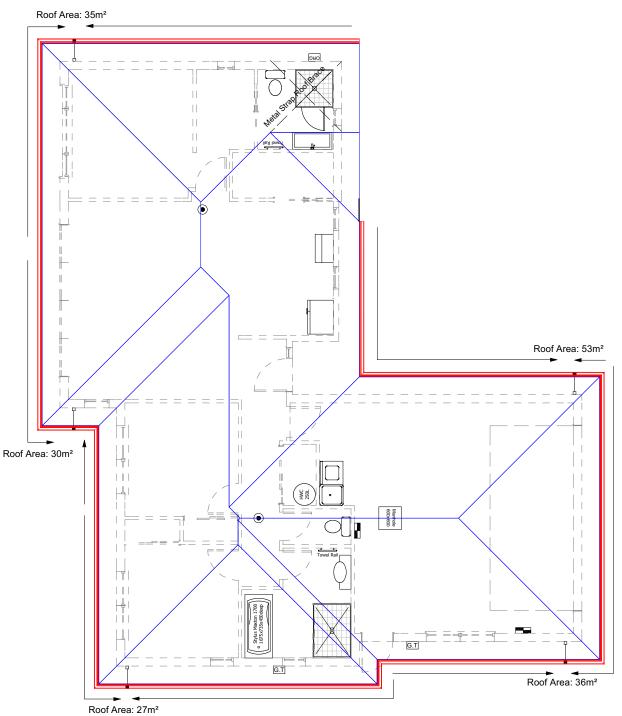


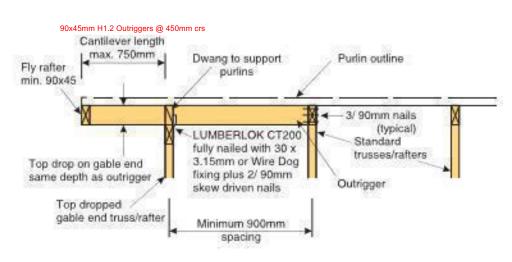



J and A D 12 Murfitt Pegasus 7 Ph: 027 7718 Email: admin

J and A Design Ltd
12 Murfitt St
Pegasus 7612
Ph: 027 7715816
Email: admin@jandadesign.co.nz

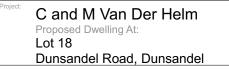

Roof Plan
Consent Plans

Drawn: Jeremy LBP#


Drawn:
Jeremy Harrison
LBP # 105491


1:100

Job Number: **2315**

10/06/2022

8 0F: **14**

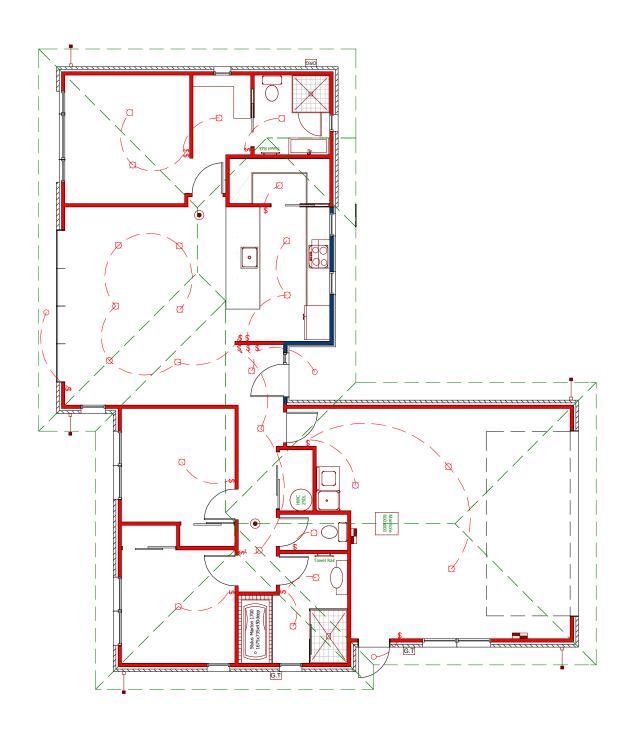

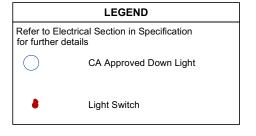

GENERAL ELECTRICAL PLAN NOTES

Electrical Plan in indicative only and is to be confirmed onsite with electrician and client

ELECTRICAL

Refer to Electrical section of the specification for items relating to NZBC G2, G3, G8 & G9.










Electrical Plan

Consent Plans

1:100

2315

10/06/2022

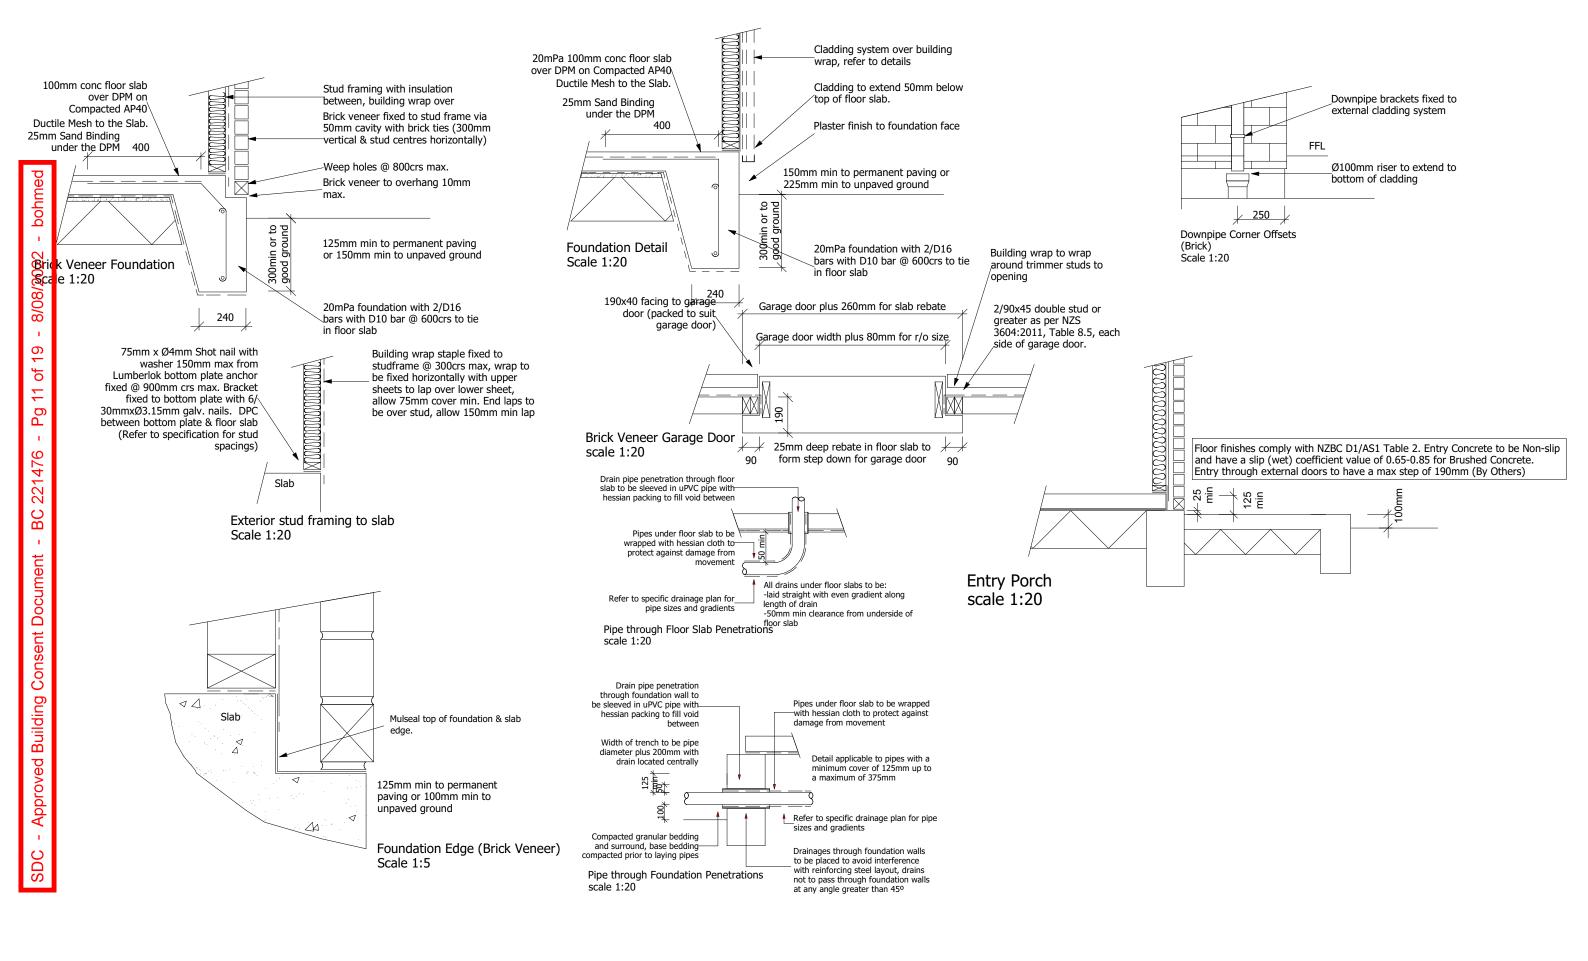










Details

Consent Plans

Jeremy Harrison varies

2315 10 14

24/07/2022

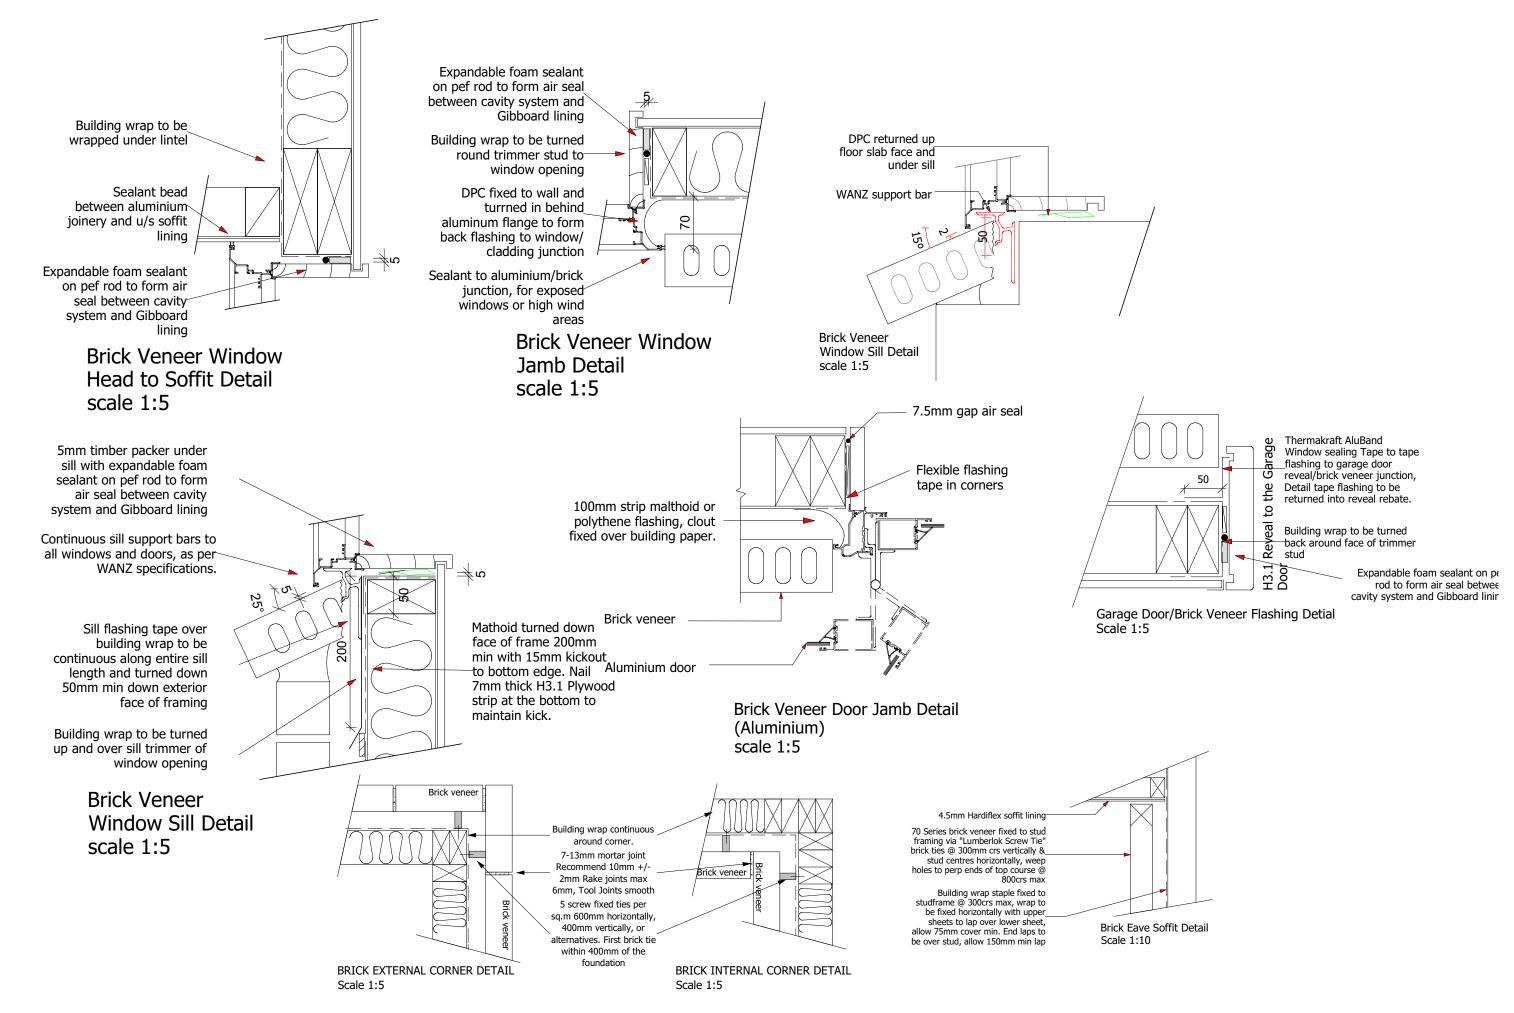









Details


Consent Plans


Jeremy Harrison LBP # 105491

2315


11 14 24/07/2022



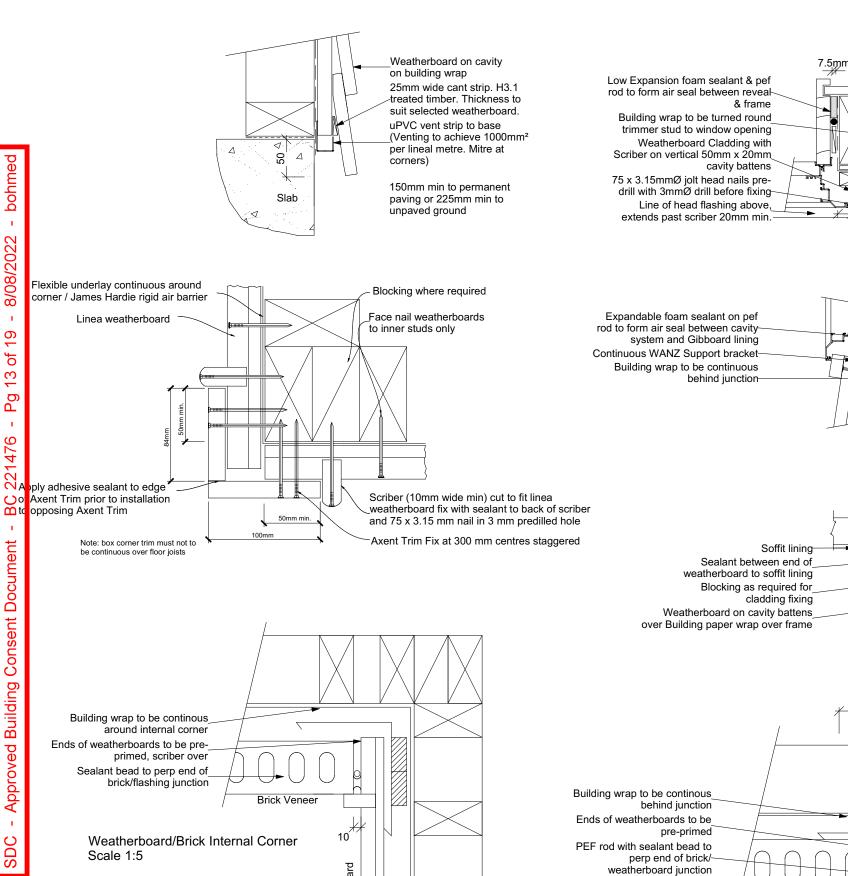

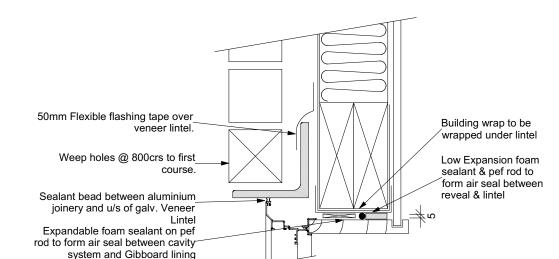

Brick Veneer Window Head to Veneer Lintel Scale 1:5

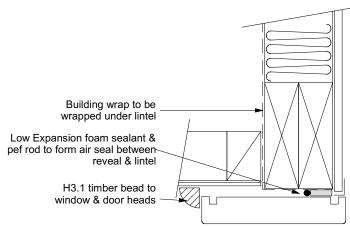

Garage Door Head to Soffit Detail

140 70 Weatherboard Brick Veneer Weatherboard/Brick "vert junction" Scale 1:5

⁴0mm Cover











Details


2315


Consent Plans


12 14 24/07/2022

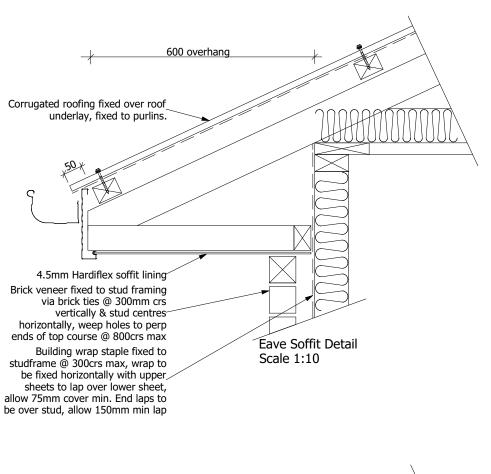

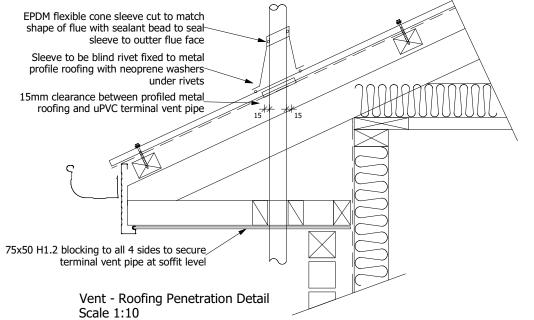

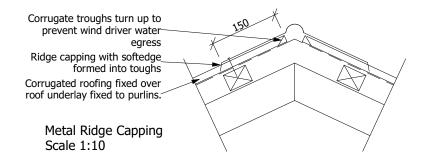

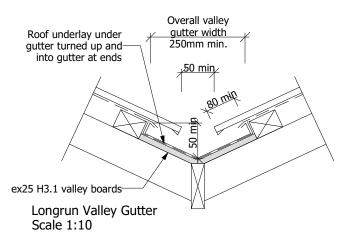

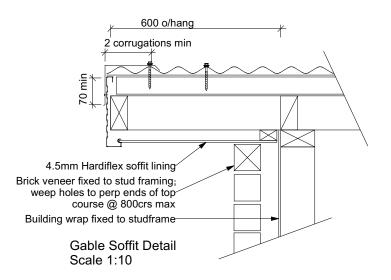











10/06/2022

13

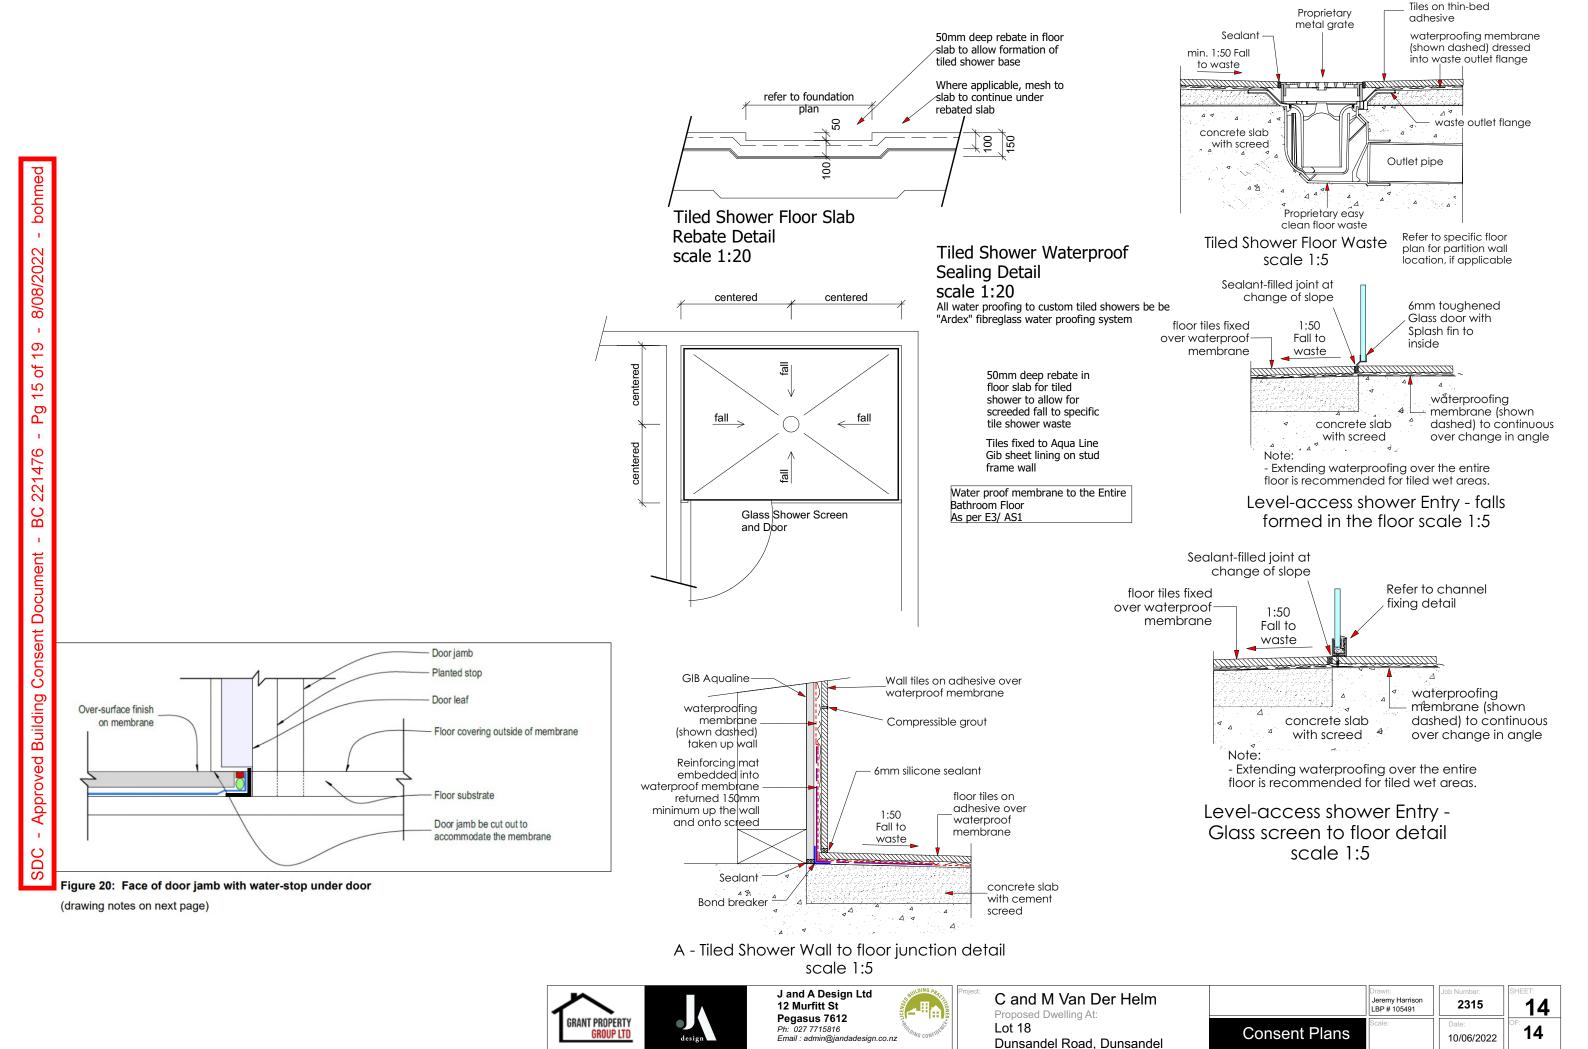

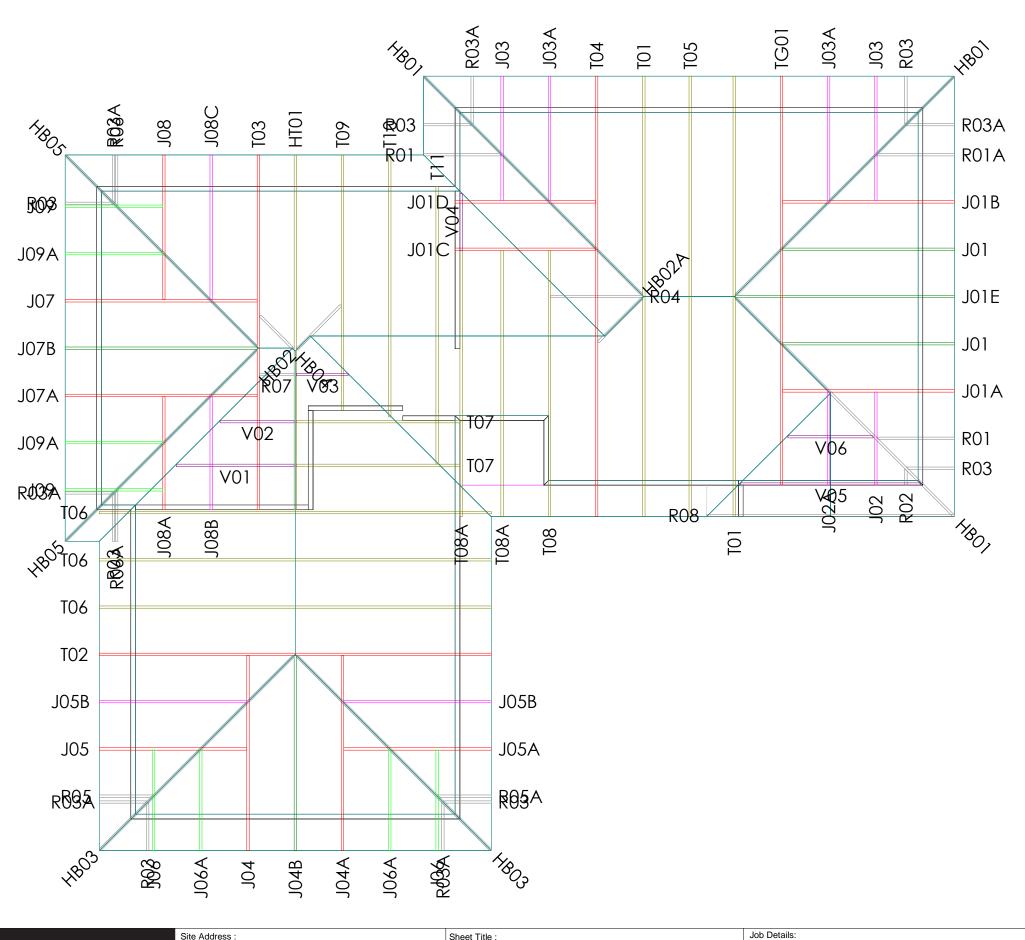



GRANT PROPERTRY GROUP LOT 18 DUNSANDEL RD DUNSANDEL CANTERBURY Buildable Design
Buildable Layouts

 Buildable Layouts

 Date:
 2 Aug,2022
 Drawn: Matthew Hansen

 Scale:
 1: 100
 System: MiTek 20/20

Roof Pitch : 25.00deg
Roof Material : Galv Iron 0.55mm
Coiling Material : Cib Board 10mm

Ceiling Material: Gib Board 10mm Wind Zone: High Roof Snow Load: 0.441kPa Truss Centres : 900mm Roof Live Load : 0.250kPa Floor Live Load : Wind Speed : 44m/s

: 600mm

Overhang

MiTek TM

PrimeCad v4.7.346

Job Title :


QCH0677

Sheet :

1

Revision Number :


Slab Thickening Details

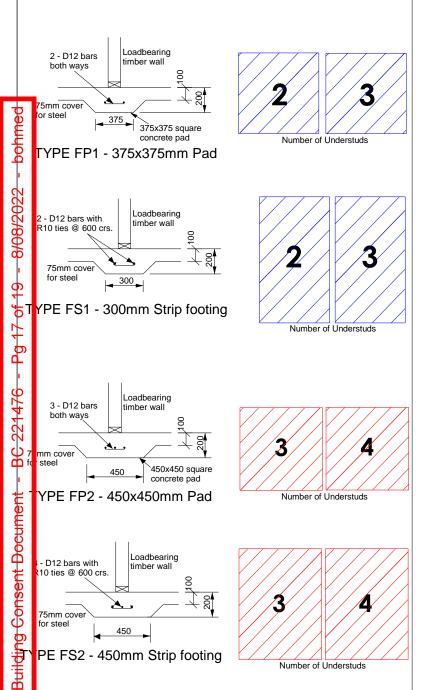

NOTES:

The numbers found within the hatched area are are number of studs required below each truss.
Refer to:

ANG-NAIL Internal Load Bearing on Concrete or Slabs brochure 10/2011

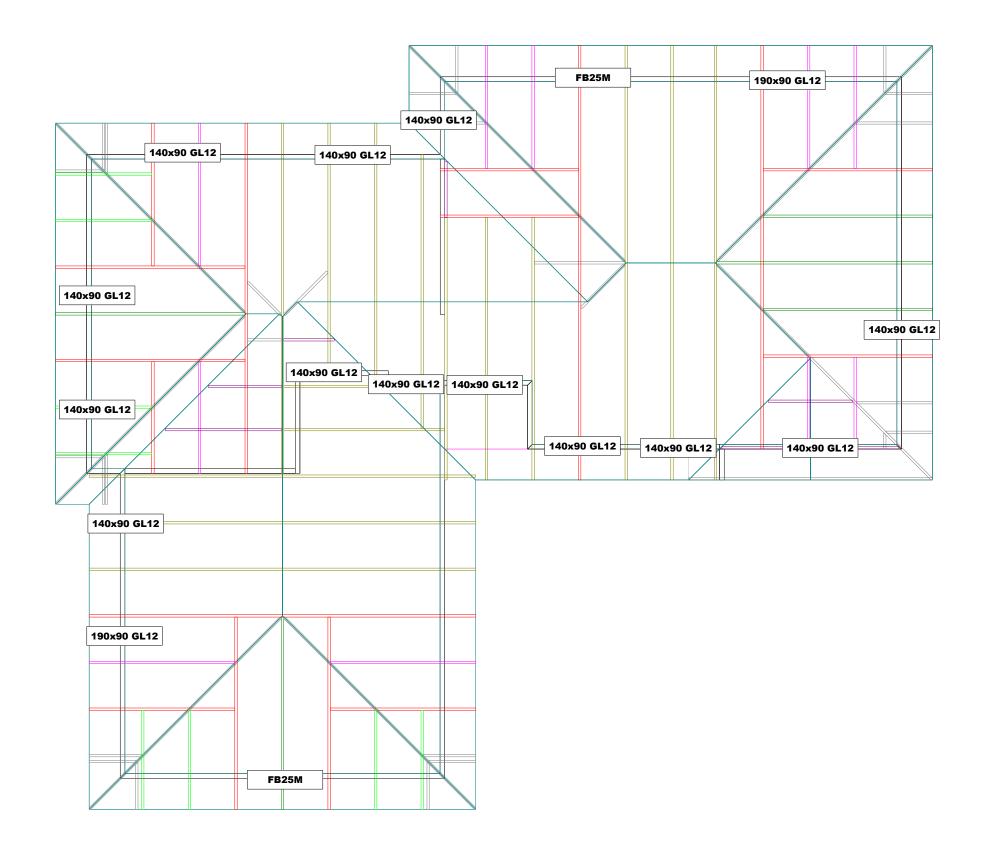

NO SLAB THICKENING REQUIRED



Ph: 03 3477 818

GRANT PROPERTRY GROUP LOT 18 DUNSANDEL RD DUNSANDEL CANTERBURY

Buildable Design
Slab Thickening/Dimensions

Date: 2 Aug, 2022 Drawn: Matthew Hansen

System: MiTek 20/20

Roof Pitch : 25.00deg
Roof Material : Galv Iron 0.55mm
Ceiling Material : Gib Board 10mm
Wind Zone : High

Roof Snow Load: 0.441kPa

Truss Centres: 900mm Roof Live Load: 0.250kPa Floor Live Load: Wind Speed: 44m/s

Overhang



Truss Fixings



A - LUMBERLOK JH47x90 Joist Hanger

B - LUMBERLOK JH47x120 Joist Hanger

D - LUMBERLOK JH47x190 Joist Hanger

E - LUMBERLOK JH95x165 Joist Hanger

C - Pair of LUMBERLOK CT200 Ceiling Ties

M - Pair of LUMBERLOK Multi Grips

NP - LUMBERLOK Nailon Plate

N - LUMBERLOK N21 Diagonal Cleat

P - LUMBERLOK TTP 16kN Truss to Top Plate set


Q - LUMBERLOK TTP 9kN Truss to Top Plate set

Roof Bracing

Refer to:

LUMBERLOK Roof Bracing Specifications trochure 08/2006 for end fixing details.

he brace must be located such that it forms an ngle of $45^{\circ} \pm 5^{\circ}$ to the wall

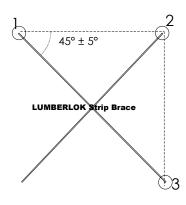


NOTES:

Il other areas must have at the minimum 1/90x3.15mm skew nails + 2 wire dogs for truss to top plate connections.

Refer to:

UMBERLOK Timber Connectors Characteristic Loadings Data brochure 03/4

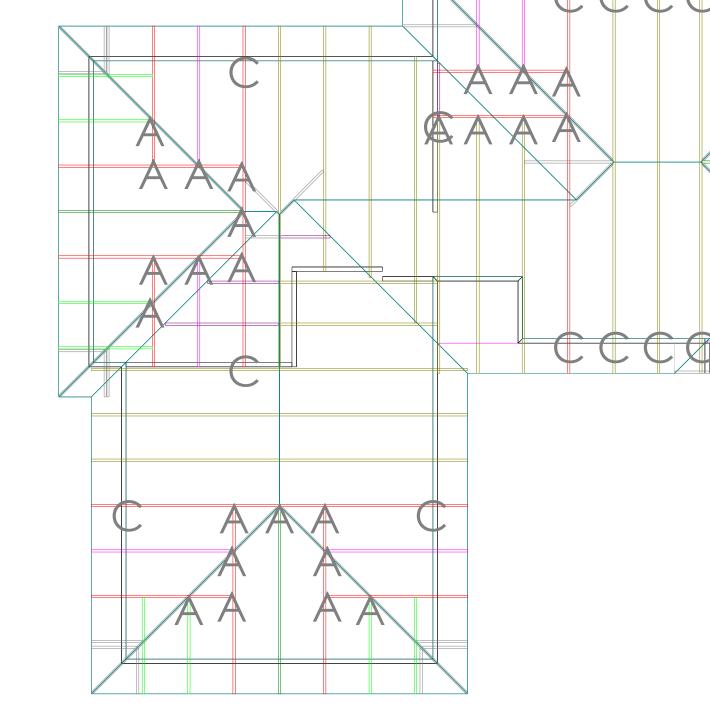



GRANT PROPERTRY GROUP LOT 18 DUNSANDEL RD **DUNSANDEL CANTERBURY**

Buildable Design

Drawn: Matthew Hansen 2 Aug,2022 Scale: 1: 100 System : MiTek 20/20

Job Details: Roof Pitch : 25.00deg : Galv Iron 0.55mm Roof Material

Wind Zone : High Roof Snow Load: 0.441kPa Truss Centres : 900mm Roof Live Load: 0.250kPa

Overhang

Floor Live Load: Wind Speed : 44m/s


: 600mm




QCH0677 Revision Number

Ph: 03 3477 818

Truss Fixings & Roof Bracing | Ceiling Material : Gib Board 10mm

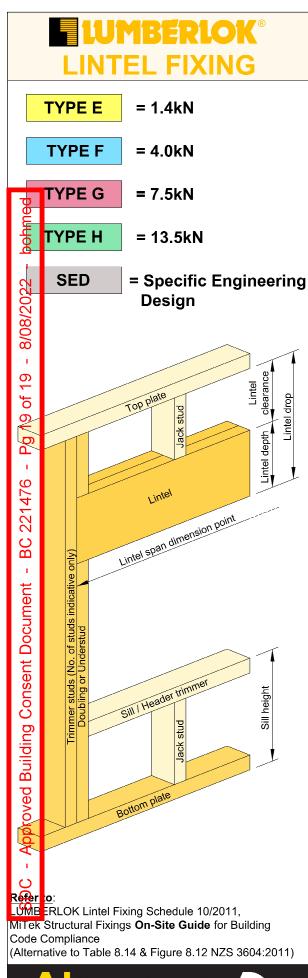

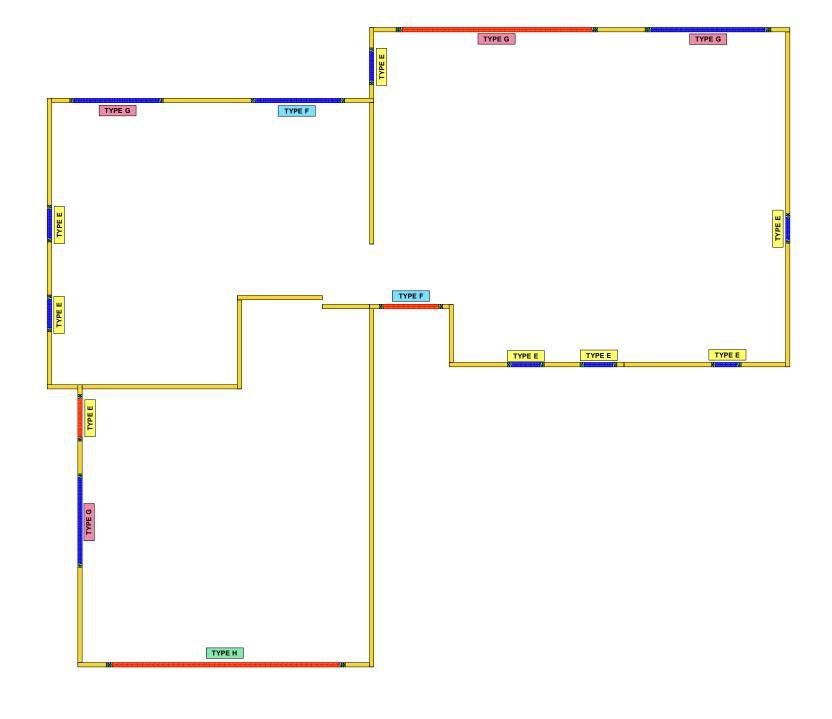

Akarana timbers

Phone: (03) 347 8845

18 Hynds Drive, i-zone Industrial Park,
Rolleston 7675, Canterbury

OT No.: **CON2200677-1**

Name: New Home

Address: Lot 18 Dunsandel

Estate, Dunsandel Canterbury

Sheet Tittle: Lintel Fixing Layout for Building Consent			Building Consent No.:	
Snow Zone:	Christchurch (N4)	Snow Altitude:	100.000 m	
Wind Area:	High	Design Wind Speed:	44.0 m/s	
TC Restraints:	900 mm	BC Restraints:	600 mm	
Roof Material:	Galv Iron 0.55mm	Ceiling Material:	Standard Plaster Board 13mm	
Roof Live Load:		Ground Snow Load:	0.900 kPa	Structu
Roof Pitch:	25.00 °	Truss Centres:	900 mm	Drawn



cture / Model: 2200677-ST-08

Date: 2/08/2022



Master Builders New Zealand 10 Year Master Build

Master Build

10 Year Master Build Guarantee

Certificate

After Completion of the Building Contract

Master Build Guarantee No 244704

for the dwelling at Lot 18, 13 Huntaway Lane, Dunsandel Estates , Dunsandel 7682

Owner

Marquerite van der Helm & Chris Brown

Builder

Grant Property Group Limited

Acceptance Date of Guarantee

27 Sep 2022

Guarantee cover after completion of the Building Contract:

- Defects in Workmanship and Materials expires on 24 Mar 2025
- Structural, including Rot and Fungal Decay expires on 27 Sep 2032

Guarantee expiry date

27 Sep 2032

Maximum Aggregate Cover

The maximum aggregate cover provided for the duration of this guarantee is \$408,906.14.

This is a summary only and does not provide all inclusions and exclusions of the Guarantee. Please refer to the Terms and Conditions for more detailed information.

Terms and conditions that apply to this Guarantee: V 05/22



A BIT ABOUT ANDY

Andy Williams is not only the Business owner of Office Road Real Estate but is an award winning agent. Being awarded in the top 100 Agents in New Zealand by Rate My Agent in 2021. Andy is quickly building a great reputation with track record to boot.

Canterbury born and bred, Andy knows the ever-changing Christchurch well.

He started his career in Personal Training, so working closely with clients and helping them to achieve their own fantastic results is familiar territory to him.

Andy spent many years working in the construction sector focusing on sales and specifications, working alongside architects, developers and builders. This gave him a well-rounded understanding and sound knowledge of everything it takes to improve, build or maximise the potential of a property – from renovations to new builds and developments. It's this knowledge, experience and valuable contacts that gave Andy a strong advantage during his own property investment journey.

Fast forward to now and Andy's desire to help people achieve fantastic results remains the same, and together with his passion for property, it was a natural fit to start helping others with their own property journey.

Andy's approach is straightforward and genuine and he's prepared to have honest conversations to achieve the best possible results for all parties.

PASSING OVER OF INFORMATION

The attached material has been compiled by the collection of records, documents, or information which may have been supplied by third parties, the vendor or the vendor's agent. Accordingly, it is merely passing over the information as supplied to us.

WARNING

No responsibility for the accuracy of the materials whole or in any part is made by Office Road Real Estate Limited or any of the company's licensees, employees, or officers.

This material is provided to assist you with obtaining relevant information about the property, it is not intended that you rely solely on this information, and you should conduct your own investigation. This could be legal, technical or any other advice relating to the property or information on the property.

OBTAINING ADVICE

Office Road Real Estate Limited and its licensees recommend you seek legal advice before signing a sale and purchase agreement or other contractual documents. You should also be aware you can and may need to seek technical or other advice and information prior to signing a sale and purchase agreement or other contractual document.





ANDY@OFFICEROAD.CO.NZ 022 547 5232

OFFICE ROAD

REAL ESTATE