The Groynes Development

Lot 502 - Groynes Park Christchurch


PRELIMINARY BC


А	201	Α	UNITS 1 AND 2 SITE AND FOUNDATION PLANS
	202	A	UNITS 1 AND 2 - GROUND / FIRST AND ROOF PLANS
	203	Α	UNITS 1 AND 2 SECTIONS
A	204	Α	UNIT 1 AND 2 ELEVATIONS
A3 UNIT	3		
A	301	Α	UNIT 3 - SITE / FOUNDATION / WORKS
A	302	Α	UNIT 3 - FLOOR AND ROOF PLANS
A	303	Α	UNIT 3 - SECTIONS
A	304	Α	UNIT 3 - ELEVATIONS
A4 UNIT	4		
Д	401	A	UNIT 4 - FLOOR AND ROOF PLANS
A	401	Α	UNIT 4 - SITE / FOUNDATION / WORKS
A	402	Α	UNIT 4 - SECTIONS
Α	403	A	UNIT 4 - ELEVATIONS
A5 UNIT	5 AND (6	
A	501	Α	UNITS 5 AND 6 - SITE AND FOUNDATION PLANS
Α	502	Α	UNITS 5 AND 6 - GROUND / FIRST AND ROOF PLANS
	503	Α	UNITS 5 AND 6 ELEVATIONS
A	503	Α	UNITS 5 AND 6 SECTIONS
A6 UNIT	7		
Д	601	Α	UNIT 7 - ELEVATIONS
A	601	Α	UNIT 7 - FLOOR AND ROOF PLANS
	601	Α	UNIT 7 - SECTIONS
	1601	Α	UNIT 7 - SITE / FOUNDATION / WORKS
A7 UNIT	8		
А	701	Α	UNIT 8 - FLOOR AND ROOF PLANS
Α	701	Α	UNIT 8 - SITE / FOUNDATION / WORKS
	702	Α	UNIT 8 - SECTIONS
	703	A	UNIT 8 - ELEVATIONS
A8 UNIT	9		
Д	801	A	UNIT 9 - FLOOR AND ROOF PLANS (1)
Α	801	Α	UNIT 9 - SITE / FOUNDATION / WORKS
Α	802	Α	UNIT 9 - SECTIONS
A	803	Α	UNIT 9 - ELEVATIONS
A9 UNIT	10		
Д	901	A	UNIT 10 - FLOOR AND ROOF PLANS (1)
_	901	A	UNIT 10 - SITE / FOUNDATION / WORKS
_	902	A	UNIT 10 - SECTIONS
A	1903	A	UNIT 10 - ELEVATIONS
A10 UNIT	T 11 ANI	D 12	
Δ	1001	A	UNITS 11 AND 12 - SITE AND FOUNDATION PLANS
_	1002	A	UNITS 11 AND 12 - GROUND / FIRST AND ROOF PLAN
_	1003	A	UNITS 11 AND 12 SECTIONS





urban arch

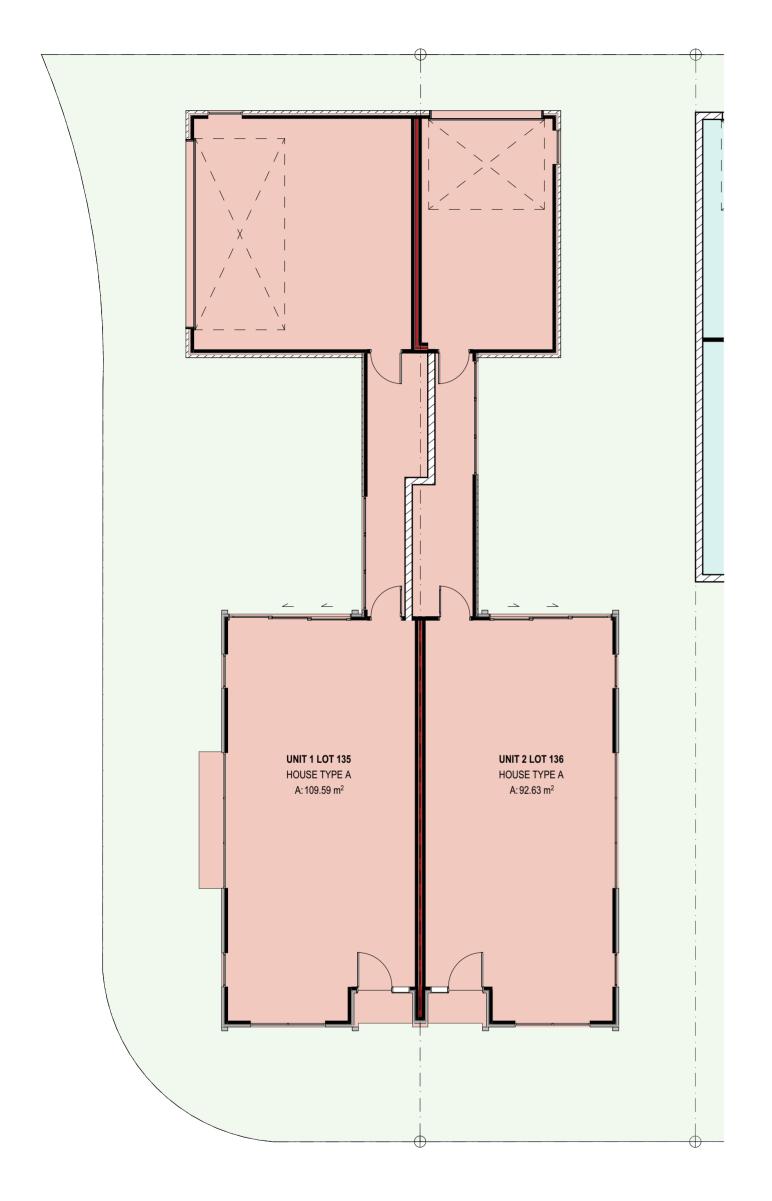

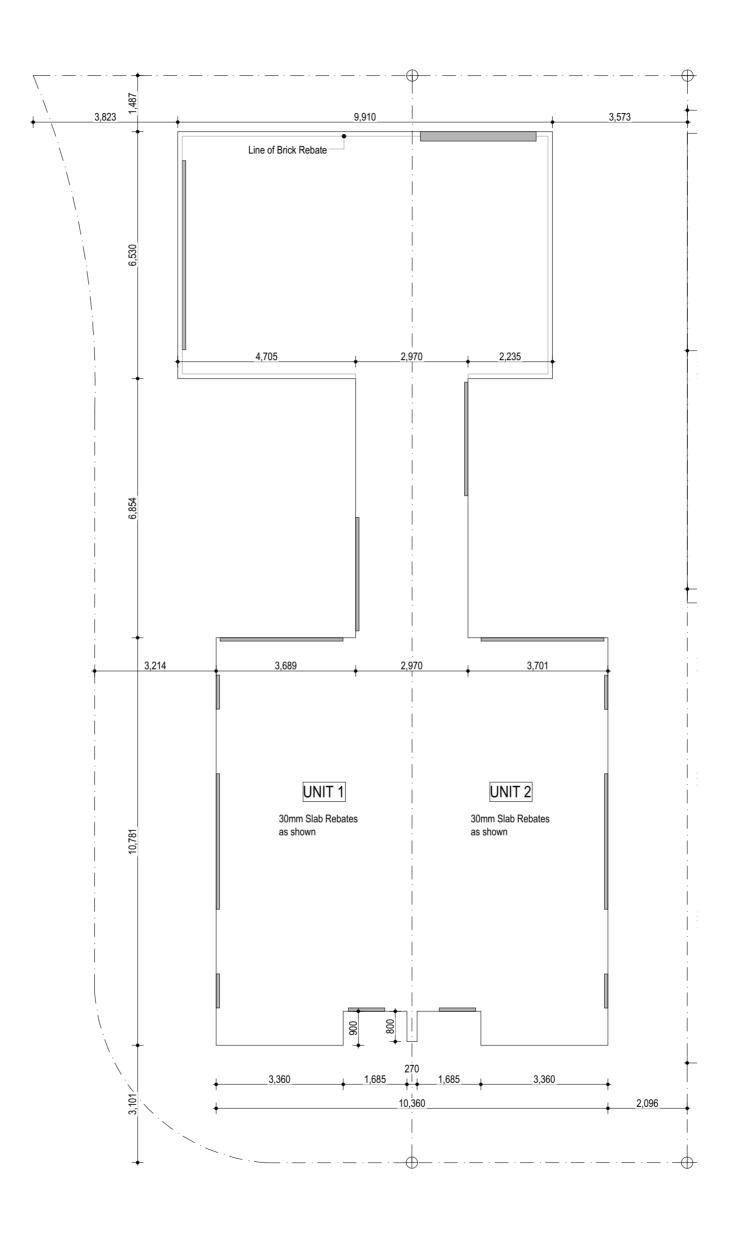

SITE INFORMATION: LOT 135 - UNIT 1

Lot 502 - Groynes Park Christchurch

Legal Lot 502 DP 475955

Land Use Zone Residential New Neighbourhood Zone Climate Zone

Earthquake Zone Exposure Zone Rainfall range

Wind Region Wind Zone Building height 8m maximum

LMA Liquifaction Management Area Roads Milton Street is a Minor Arterial

Area Calculations:

Site Area Unit 1

295.1sqm +/-Unit 2 209.9sqm +/-Site Coverage :

Achieved

Unit 1 36.3% 109.59sqm Unit 2 44.1% 92.63 Allowed 118.16sqm

Impervious areas X% Xsqm

Pervious areas X% Xsqm At least 50% of the landscaping shall be trees and shrubs.

Recession Planes North Milton Street NA

37 degrees South East

LEGEND



New tree 1.5m minimum height at time of planting.

Visibility splay, clear from 1m above from 2m either side of the access for a depth of 2m



Exposed aggregate

Brushed concrete



Waste management

UNITS 1 AND 2 SITE PLAN 1:100 UNITS 1 AND 2 FOUNDATION PLAN


urban arch


The Groynes Development
Lot 502 - Groynes Park Christchurch


1:100

Sheet title: UNITS 1 AND 2 SITE AND FOUNDATION PLANS

Date: 14/07/2021 Issue: PRELIMINARY BC Revision: A Scale: 1:100, 1:200 @ A3

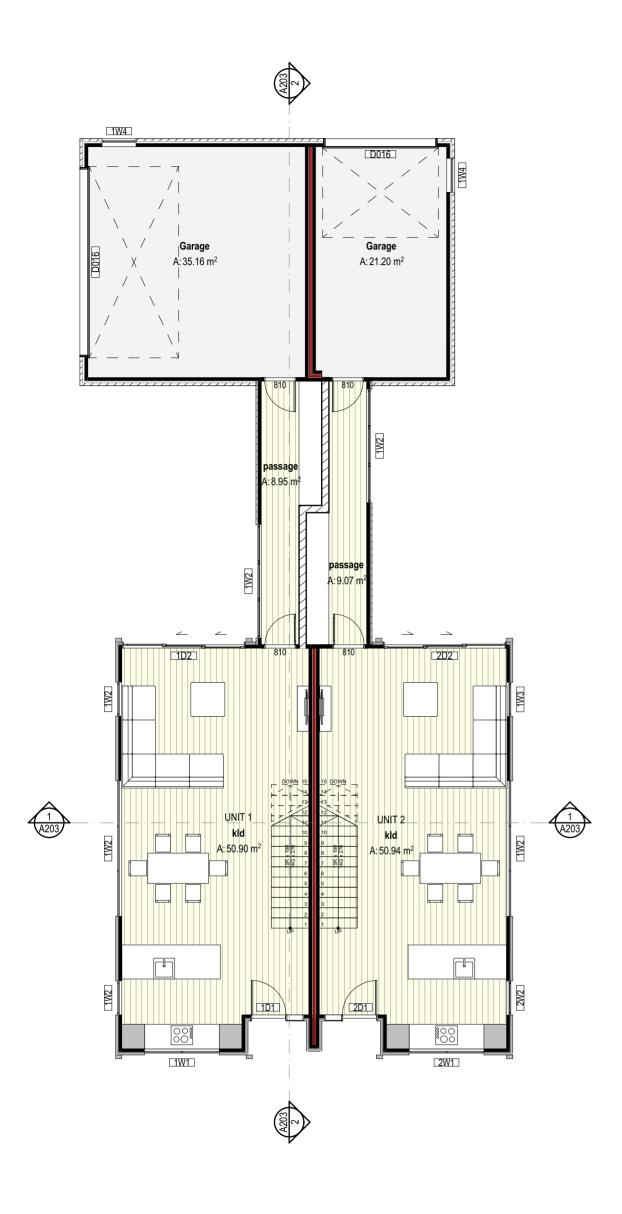

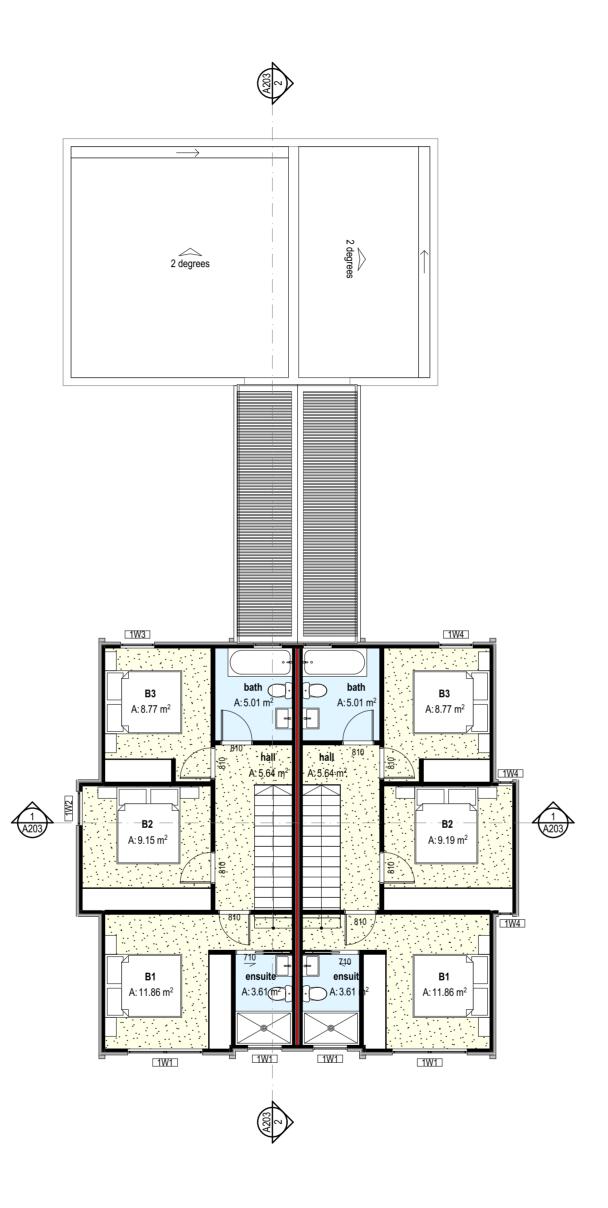

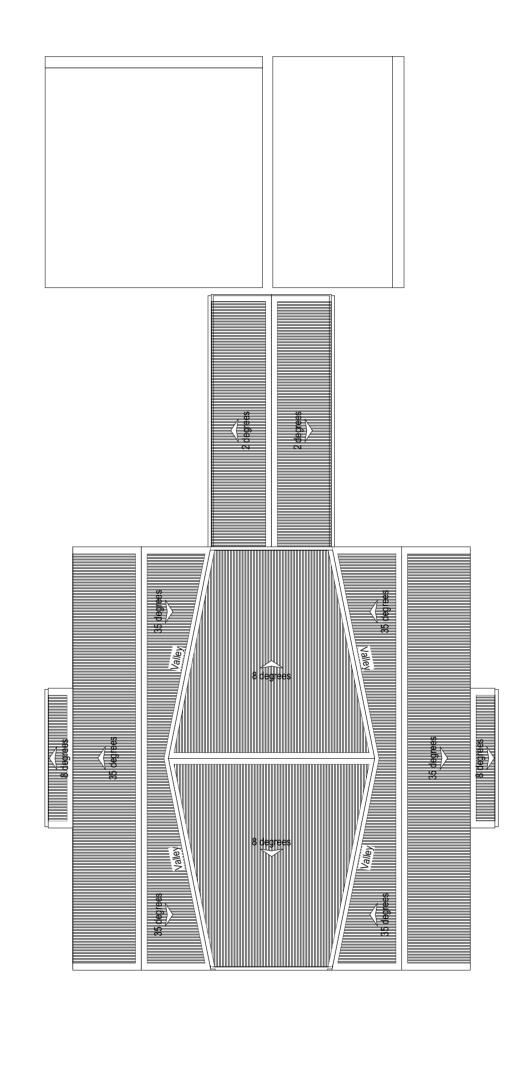

1 UNITS 1 AND 2 GROUND FLOOR PLAN 1:100 2 UNITS 1 AND 2 FIRST FLOOR PLAN 1:100 3 UNITS 1 AND 2 ROOF PLAN 1:100

urban arch


The Groynes Development
Lot 502 - Groynes Park Christchurch

Sheet title:
UNITS 1 AND 2 - GROUND / FIRST
AND ROOF PLANS

Date: 14/07/2021 Issue: PRELIMINARY BC Revision: A Scale: 1:100 @ A3

A202



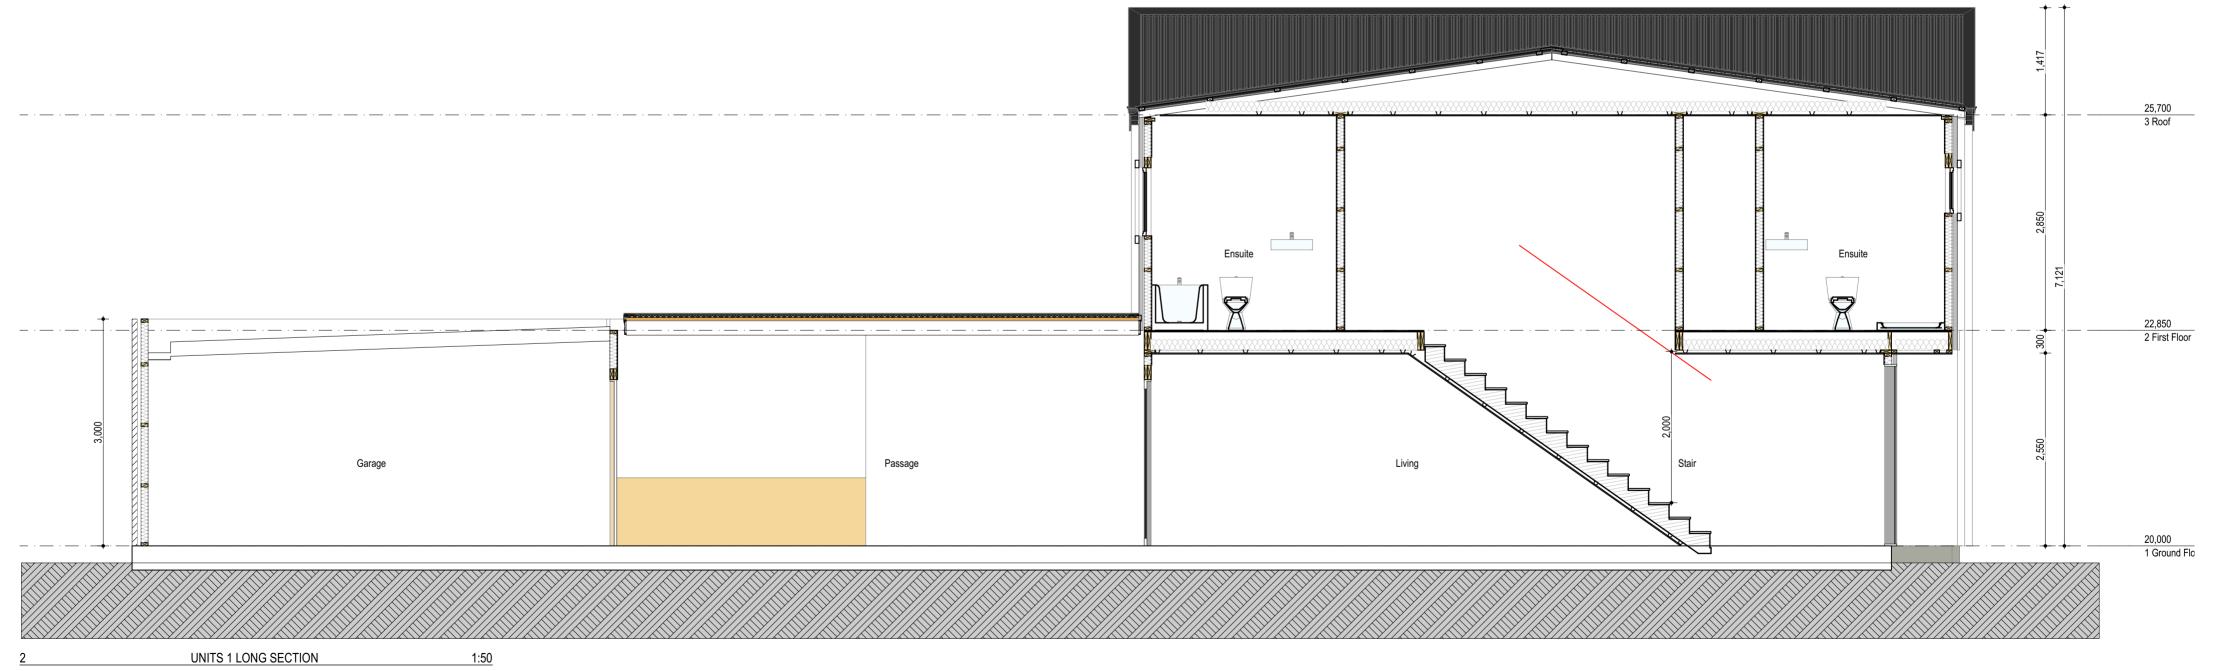









ALJ Aluminium Joinery

Double glazed aluminium joinery refer to specification.

lames Hardie Avon na

Axon panel over H3.1 45x20mm Radiata battens at 300mm centers over wall underlay over H1.2 90x45mm Radiata framing with studs at 600mm centres and dwangs at 800mm centres. Panel to overhang slab by 50mm. Bottom plate fixed with

135mm hold down bolts at 1200mm centers and 150mm

Brick Veneer
70 series brick veneer over
50mm cavity

Resene Facade System
Integra Lightweight Concrete
Facade System - Integra
50mm Panel on 20mm Cavity
on wall underlay on H1.2 SG8
90x45mm Radiata framing
with studs at 600mm centres
and dwangs at 800mm
centres. Refer to supporting

documentat

Roof Cladding

0.55mm BMT Longrun

Trapezoidal roof cladding over
roofing underlay over H1.2 75

x 45mm SG8 radiata purlins

@ 900mm centres with
600mm end purlins

urban arch


The Groynes Development
Lot 502 - Groynes Park Christchurch


Sheet title:
UNIT 1 AND 2 ELEVATIONS


Date: 14/07/2021 Issue: PRELIMINARY BC Revision: A

Scale: 1:100 @ A3

A204

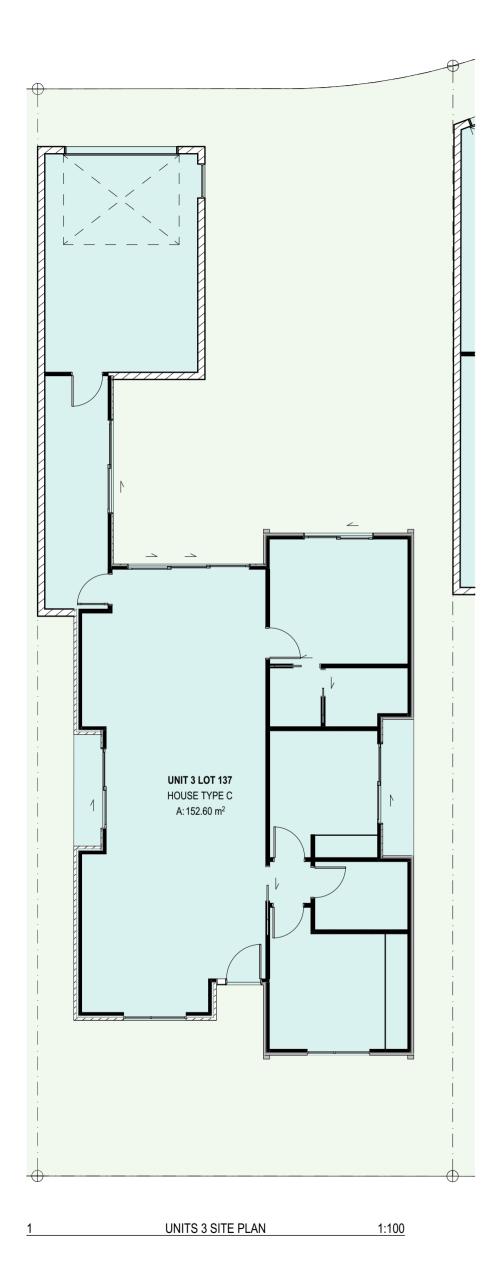

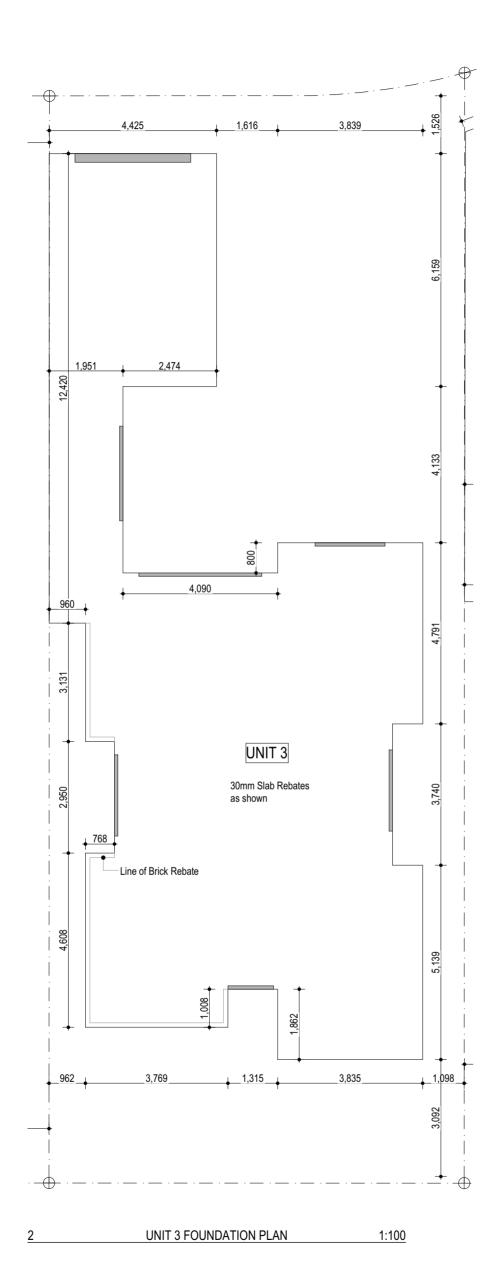

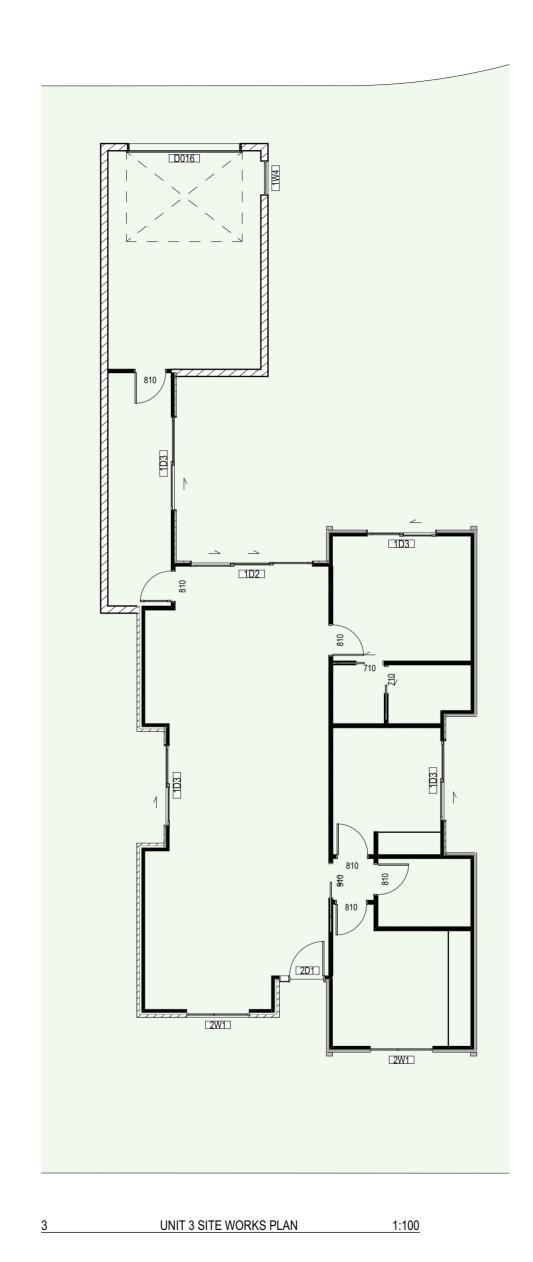



SITE INFORMATION: LOT 137 - UNIT 3

Lot 502 - Groynes Park Christchurch

Lot 502 DP 475955 Legal Land Use Zone Residential New Neighbourhood Zone

Climate Zone

Earthquake Zone Exposure Zone Rainfall range Wind Region

Wind Zone Building height 8m maximum

LMA Liquifaction Management Area Roads Milton Street is a Minor Arterial

Area Calculations:

316.6sqm +/-Site Area

Site Coverage : 40% 126.64sqm Allowed 48.2% 152.60sqm Achieved

X% Xsqm Impervious areas

Pervious areas X% Xsqm At least 50% of the landscaping shall be trees and

shrubs.

Recession Planes

Milton Street NA North

South 37 degrees East

LEGEND




Visibility splay, clear from 1m above from 2m either side of the access for a depth of 2m

Exposed aggregate

Brushed concrete Low planting





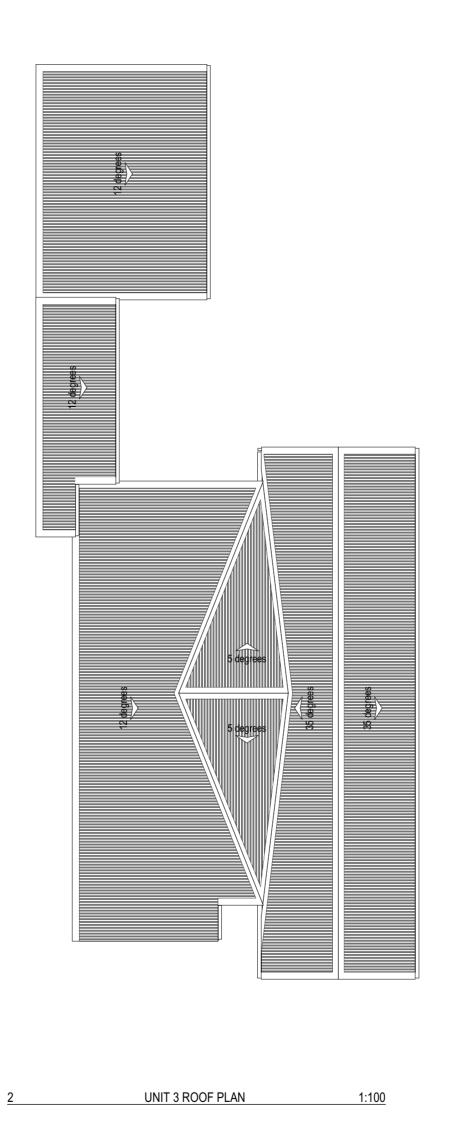

urban arch


The Groynes Development
Lot 502 - Groynes Park Christchurch

Sheet title:
UNIT 3 - FLOOR AND ROOF PLANS

Date: 14/07/2021 Issue: PRELIMINARY BC Revision: A Scale: 1:100 @ A3


14/07/2021 PRELIMINARY BC A3 A3 A3




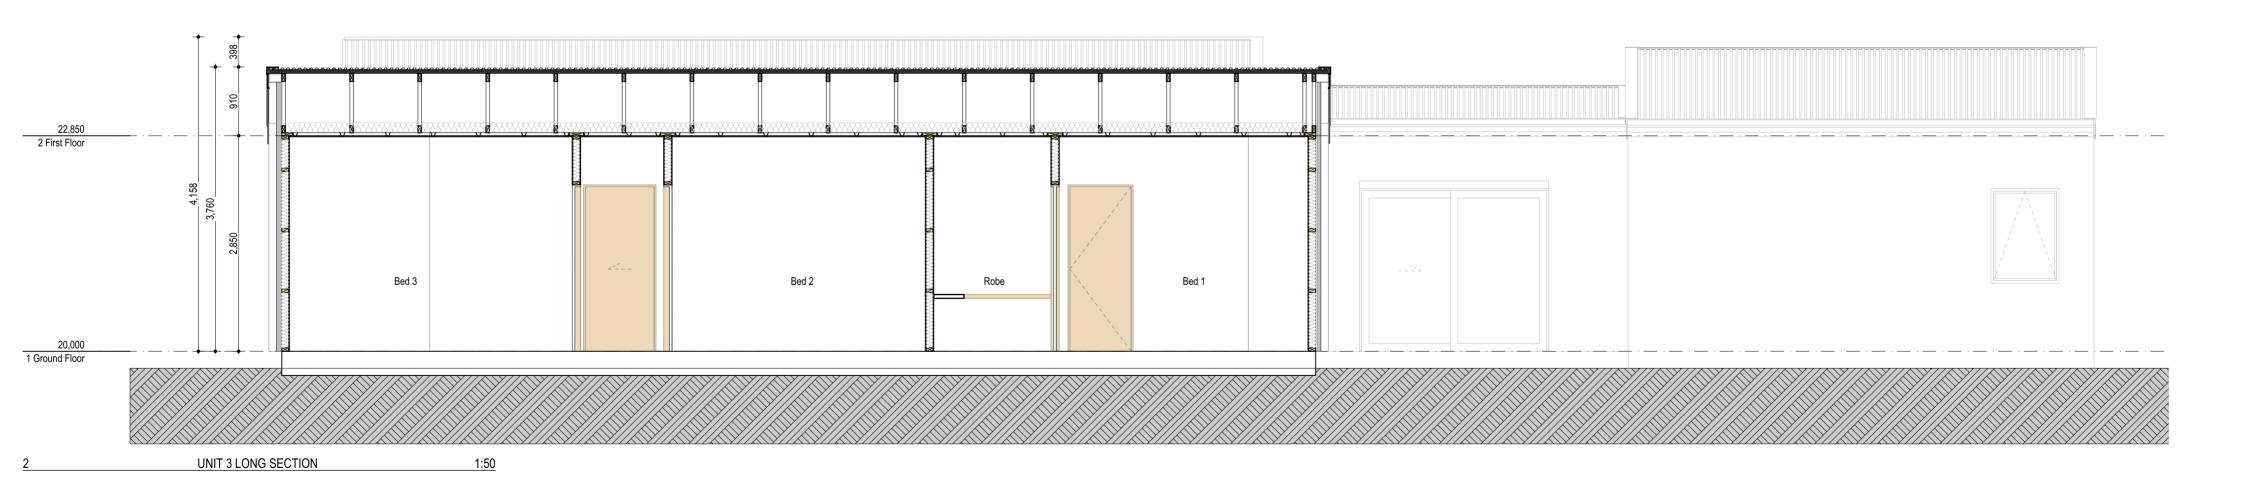





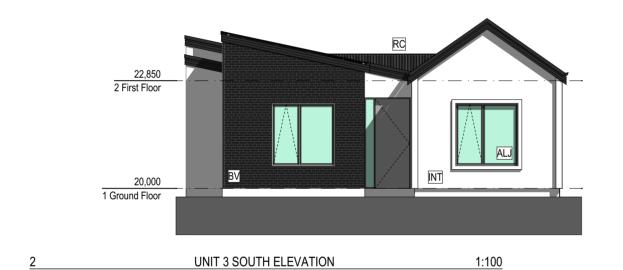

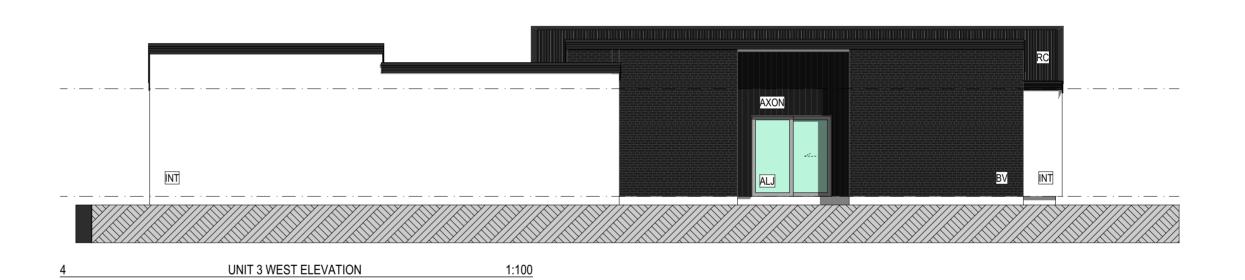



Aluminium Joinery

centers and 150mm **Brick Veneer**

Resene Facade System

supporting documentation.

Roof Cladding

600mm end purlins

cavity

James Hardie Axon panel

to specification.

Double glazed aluminium joinery refer

Axon panel over H3.1 45x20mm Radiata battens at 300mm centers over wall underlay over H1.2 90x45mm Radiata framing with studs at 600mm centres and dwangs at 800mm centres. Panel to overhang slab by 50mm. Bottom plate fixed with 135mm hold down bolts at 1200mm

70 series brick veneer over 50mm

Integra Lightweight Concrete Facade System - Integra 50mm Panel on

20mm Cavity on wall underlay on


H1.2 SG8 90x45mm Radiata framing with studs at 600mm centres and dwangs at 800mm centres. Refer to


0.55mm BMT Longrun Trapezoidal roof cladding over roofing underlay


over H1.2 75 x 45mm SG8 radiata

purlins @ 900mm centres with

urban arch

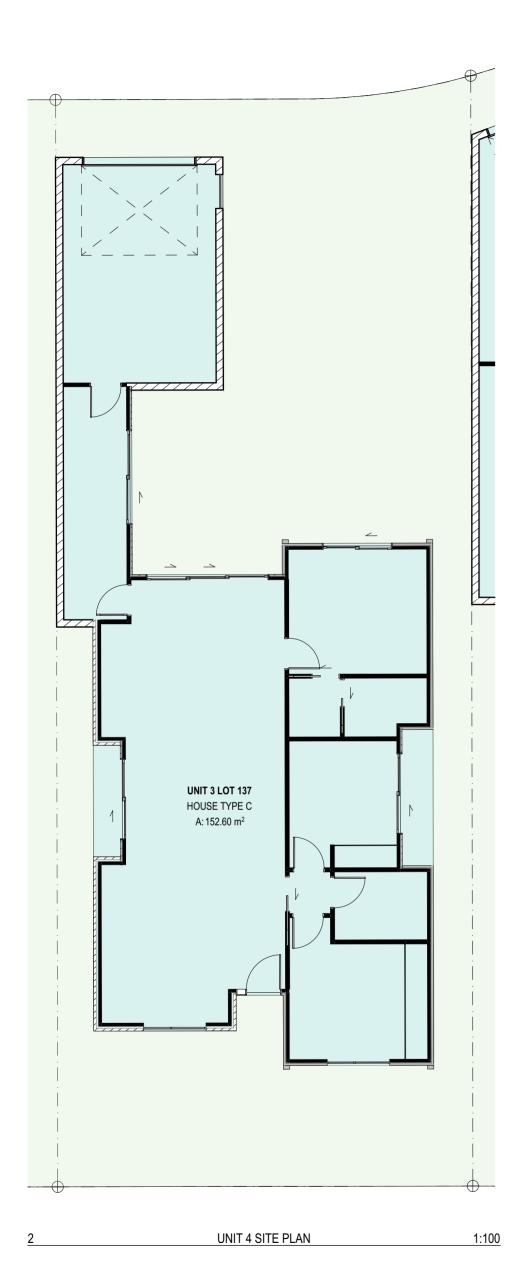

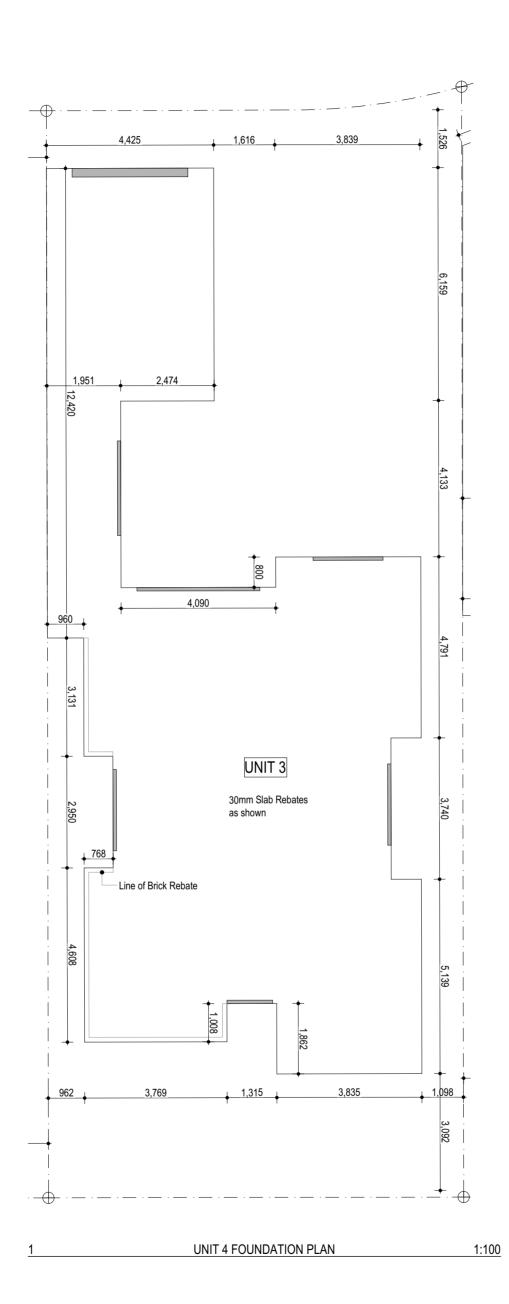

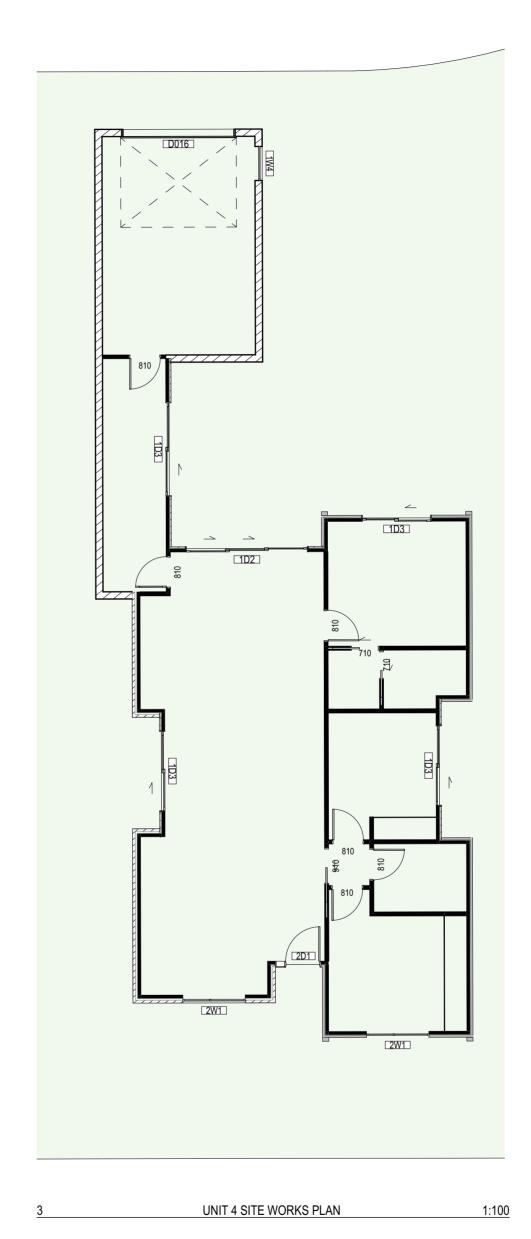



SITE INFORMATION: LOT 138 - UNIT 4

Lot 502 - Groynes Park Christchurch

129.44sqm

Legal Lot 502 DP 475955
Land Use Zone Residential New Neighbourhood Zone

Climate Zone 3 Earthquake Zone 2

Exposure Zone C
Rainfall range 30 - 4l
Wind Region A
Wind Zone High

Building height 8m maximum

LMA Liquifaction Management Area

Roads Milton Street is a Minor Arterial

Area Calculations :

Site Area 323.6sqm +/-

Site Coverage : Allowed 40%

Achieved 48% 155.36sqm
Impervious areas X% Xsqm

Pervious areas X% Xsqm
At least 50% of the landscaping shall be trees and

shrubs.

Recession Planes

North Milton Street NA South 37 degrees

South 37 degrees
East 50
West 38

LEGEND

New tree 1.5m minimum height at time of planting.

Visibility splay, clear from 1m above from 2m either side of the access for a depth of 2m

Exposed aggregate

Brushed concrete

Low planting



The Groynes Development
Lot 502 - Groynes Park Christchurch


The Groynes Development
Lot 502 - Groynes Park Christchurch


Sheet title:
UNIT 4 - FLOOR AND ROOF PLANS
Revision: A
Scale: 1:100 @ A3

A401

1:100




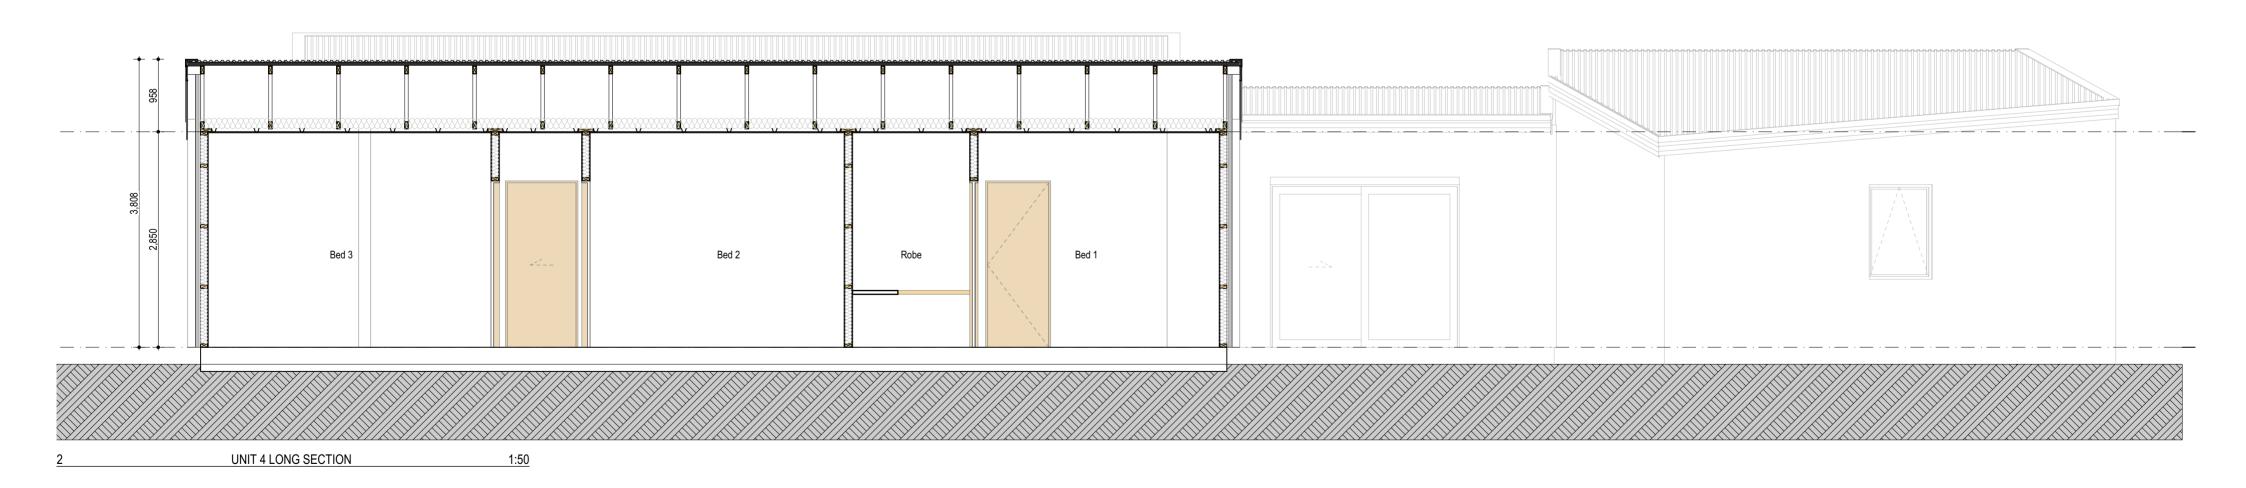

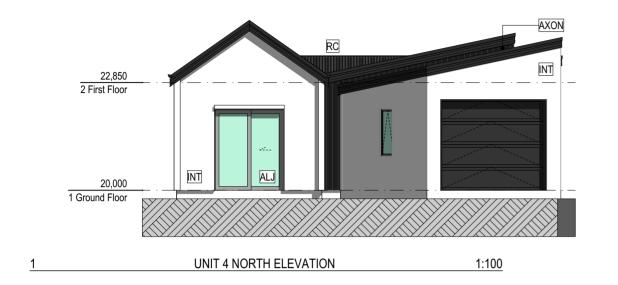





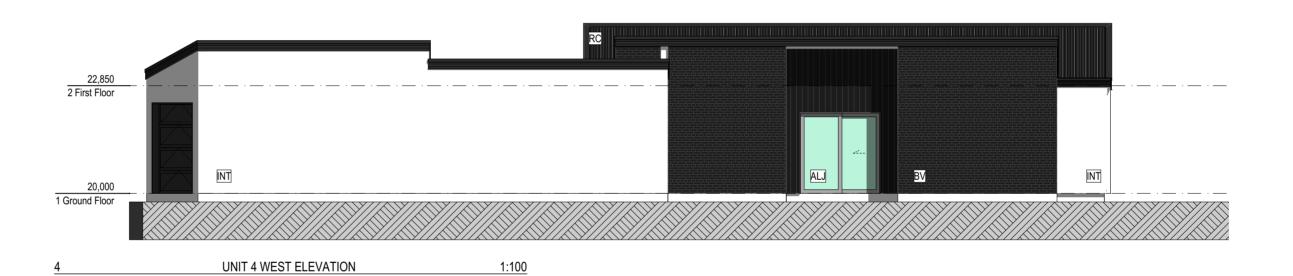

Aluminium Joinery

Double glazed aluminium joinery refer

to specification.

James Hardie Axon panel Axon panel over H3.1 45x20mm Radiata battens at 300mm centers over wall underlay over H1.2 90x45mm Radiata framing with studs at 600mm centres and dwangs at 800mm centres. Panel to overhang slab by 50mm. Bottom plate fixed with 135mm hold down bolts at 1200mm centers and 150mm

Brick Veneer

70 series brick veneer over 50mm cavity


Resene Facade System

Integra Lightweight Concrete Facade System - Integra 50mm Panel on 20mm Cavity on wall underlay on H1.2 SG8 90x45mm Radiata framing with studs at 600mm centres and dwangs at 800mm centres. Refer to supporting documentation.

Roof Cladding

0.55mm BMT Longrun Trapezoidal roof cladding over roofing underlay over H1.2 75 x 45mm SG8 radiata purlins @ 900mm centres with 600mm end purlins



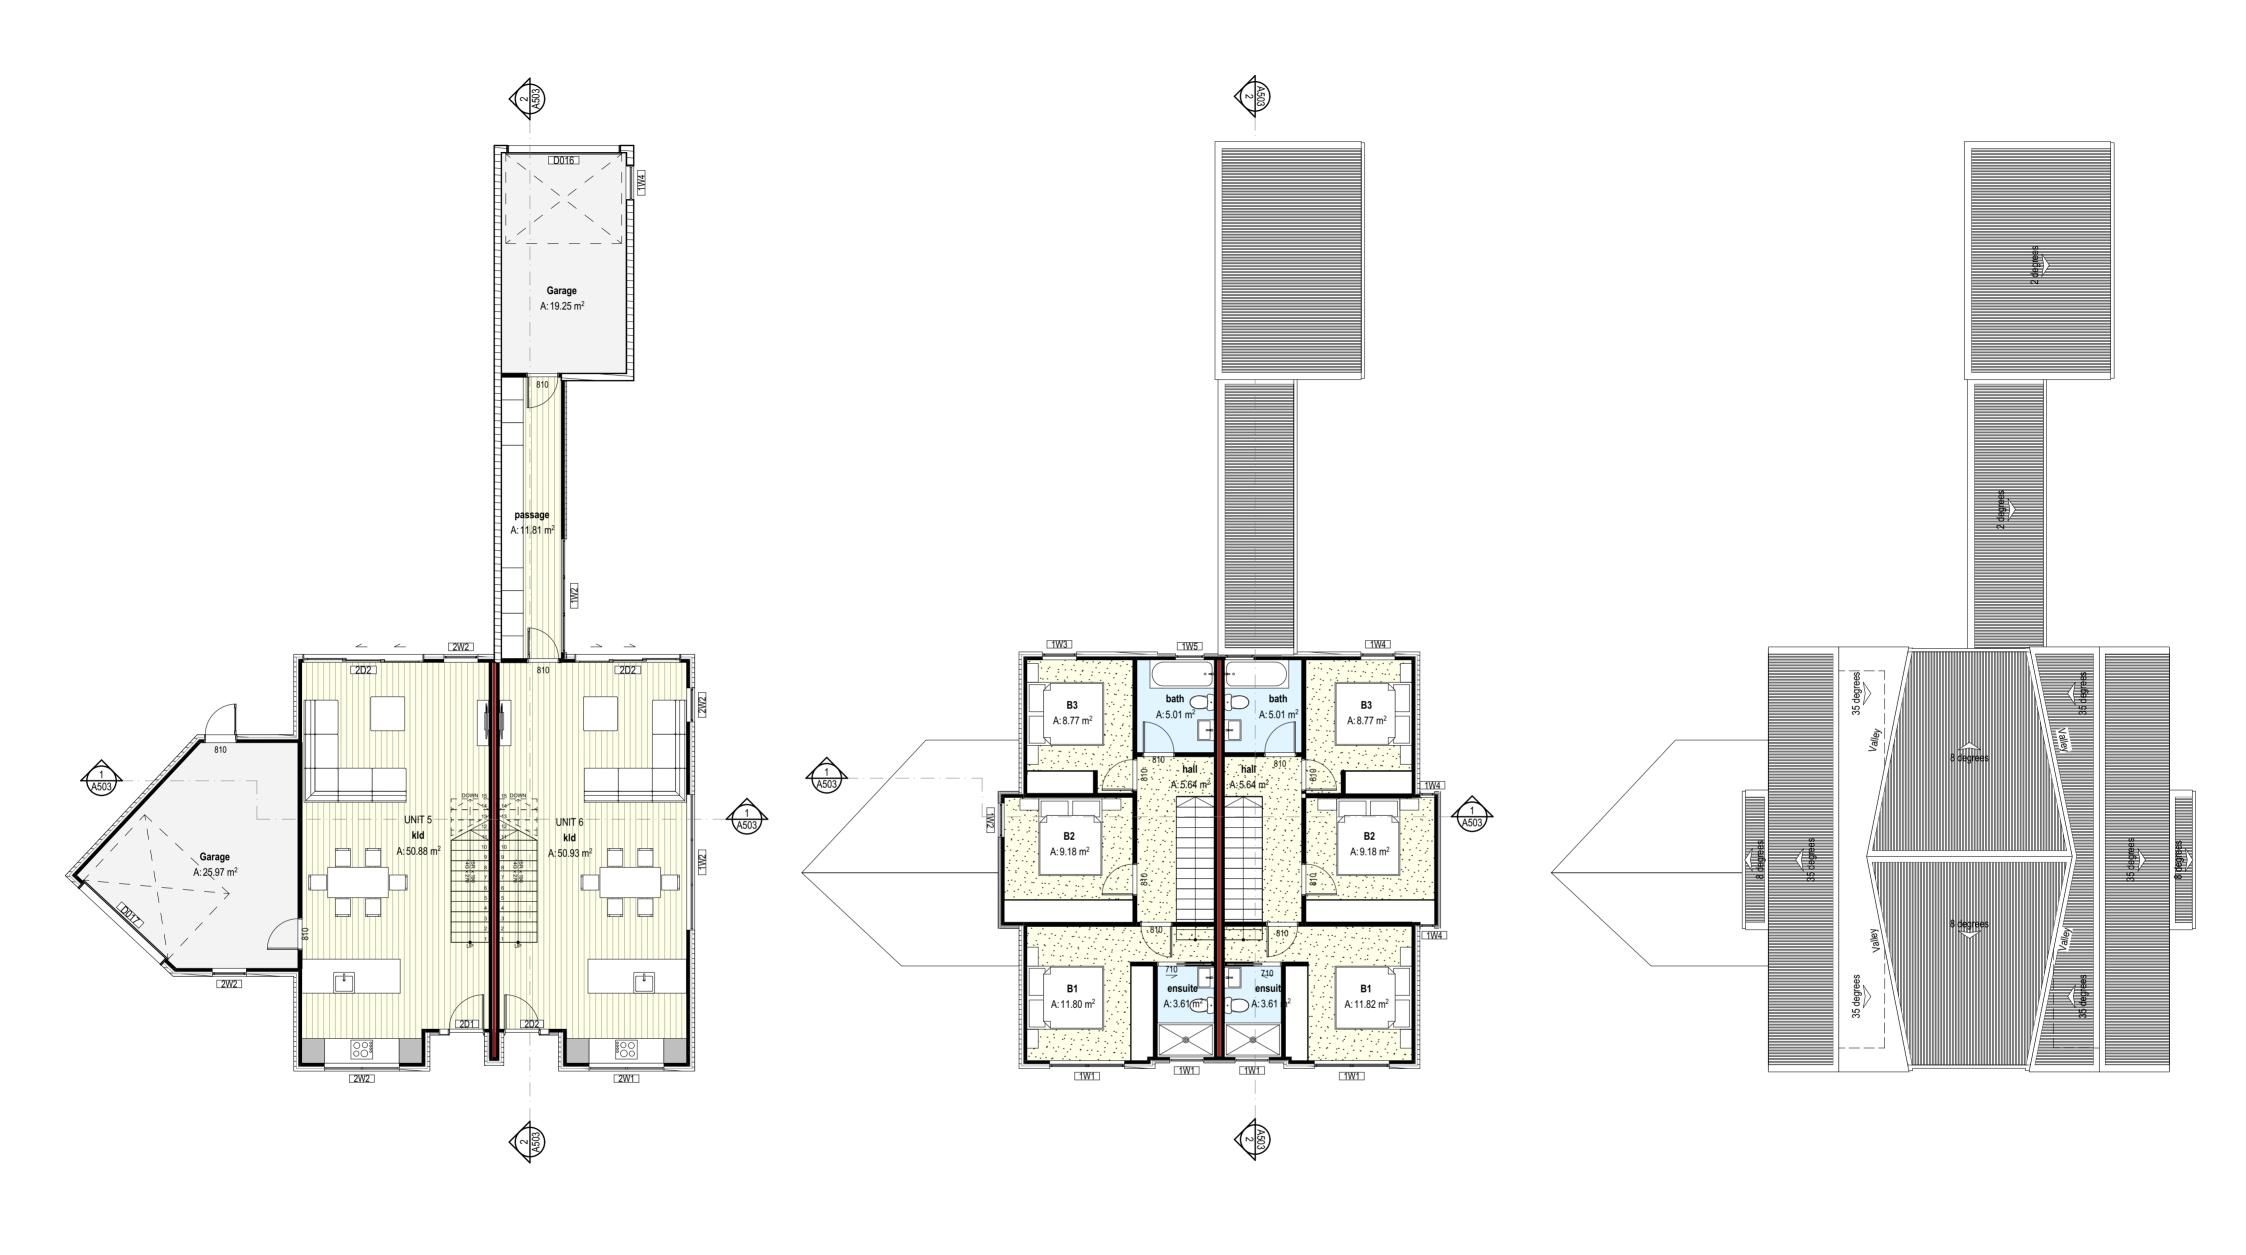

 UNITS 5 AND 6 GROUND FLOOR PLAN
 1:100
 2
 UNITS 5 AND 6 FIRST FLOOR PLAN
 1:100
 3
 UNITS 5 TO 6 ROOF PLAN
 1:100


urban arch

The Groynes Development
Lot 502 - Groynes Park Christchurch

Sheet title:
UNITS 5 AND 6 - GROUND / FIRST
AND ROOF PLANS

Date: 14/07/2021 Issue: PRELIMINARY BC Revision: A Scale: 1:100 @ A3


A502

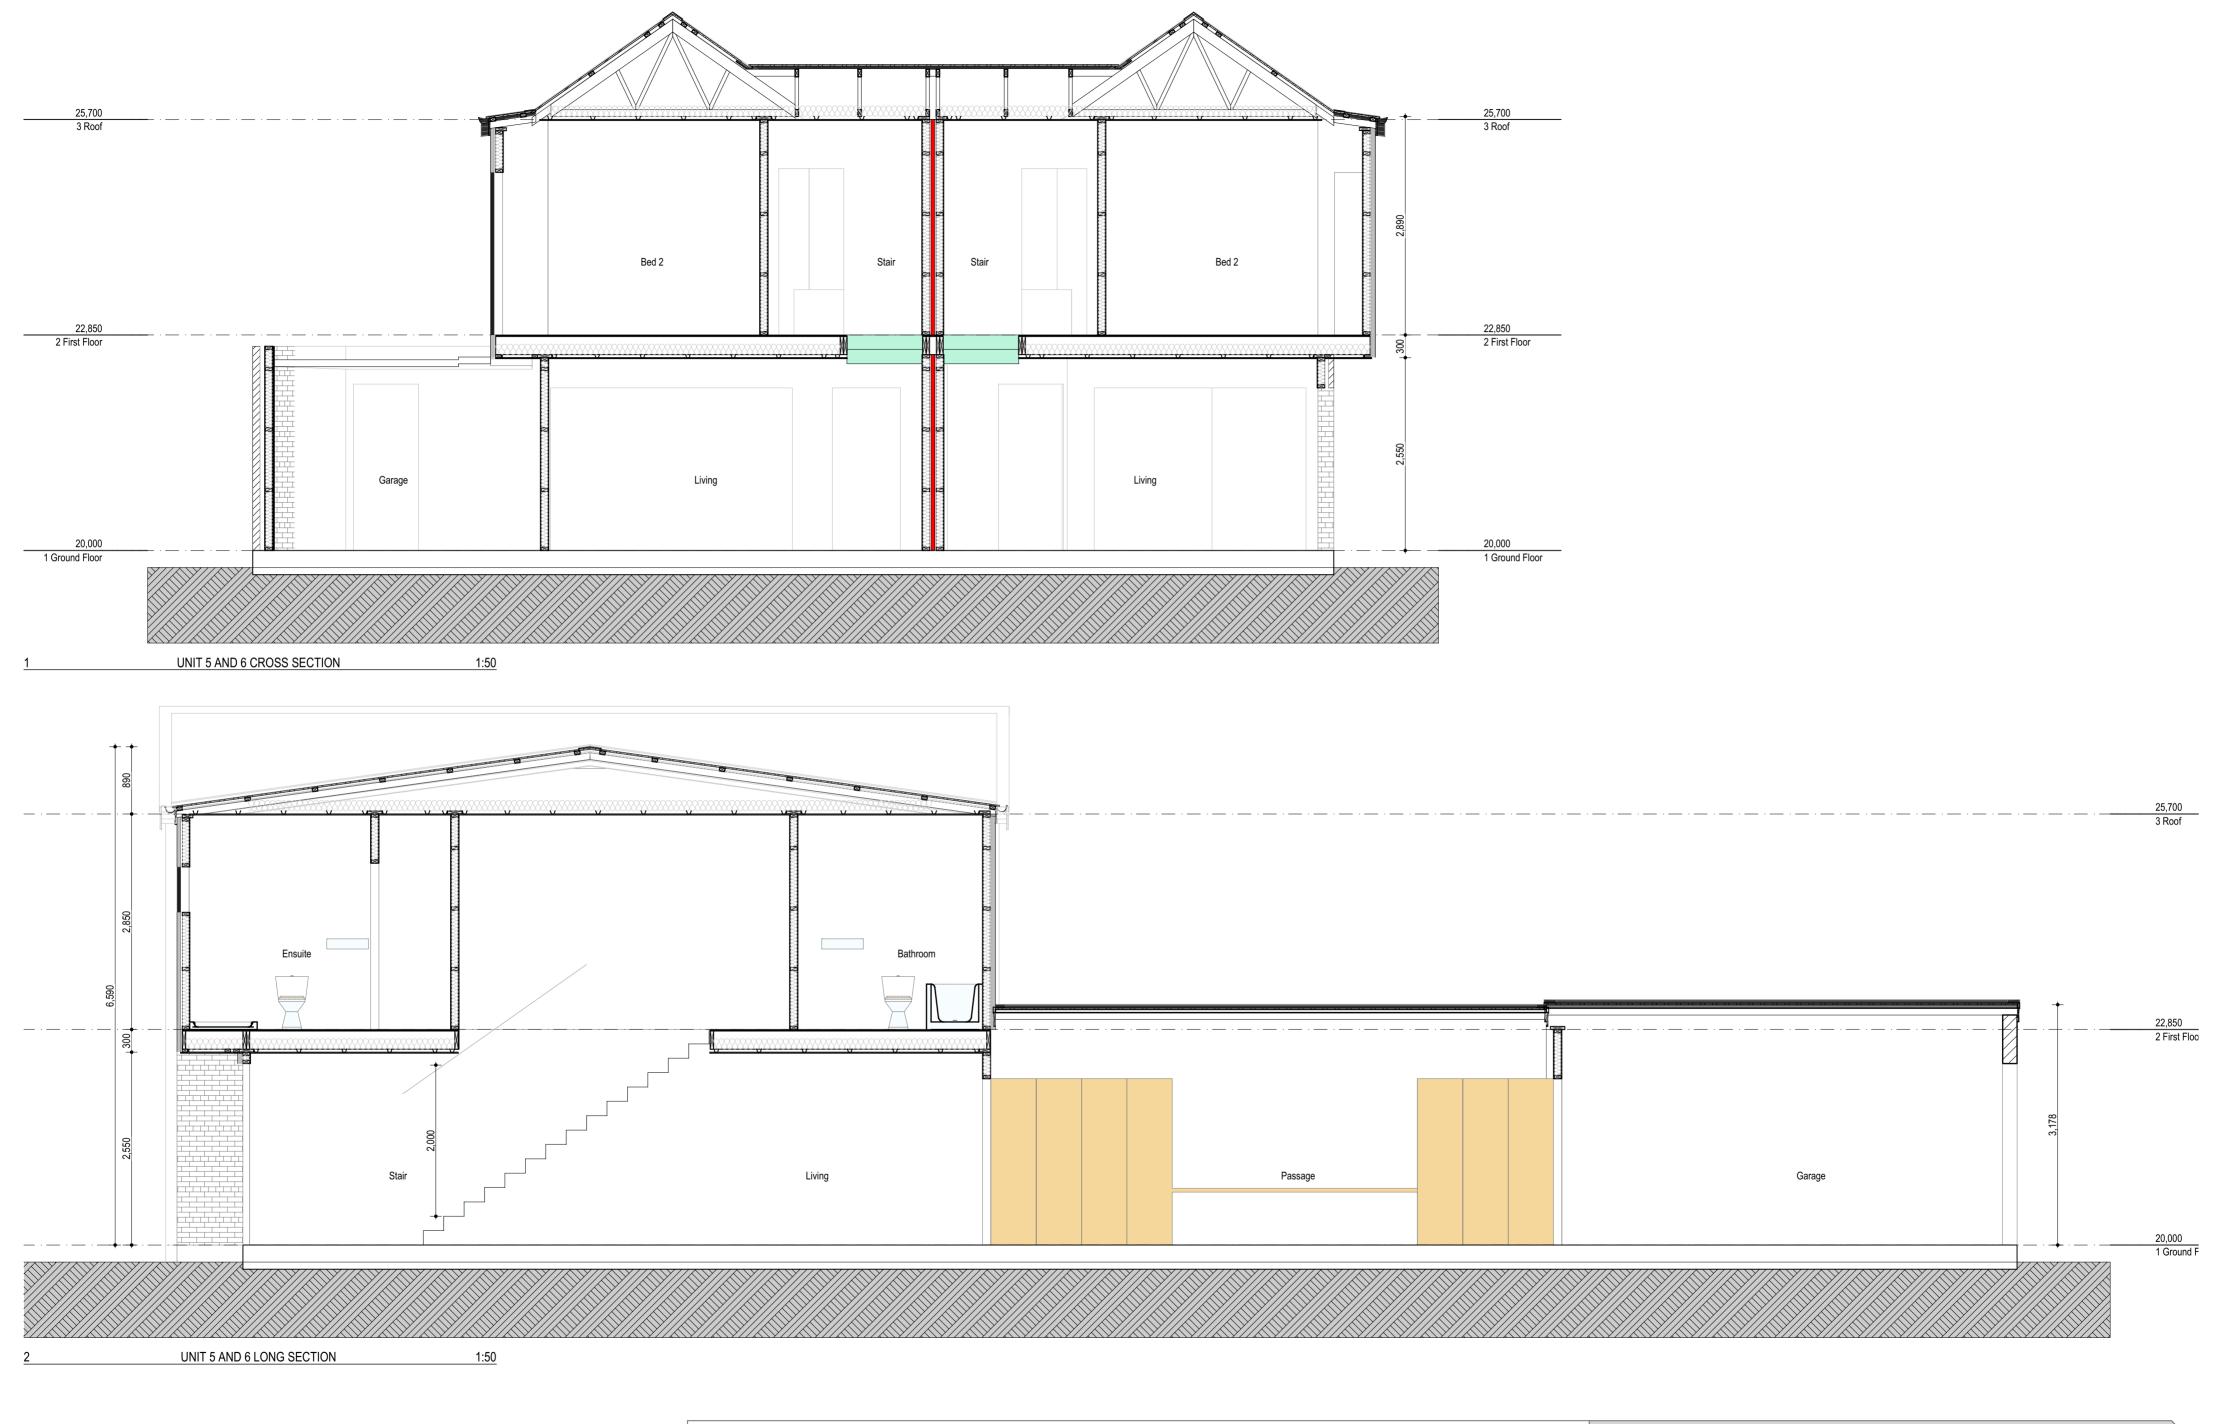







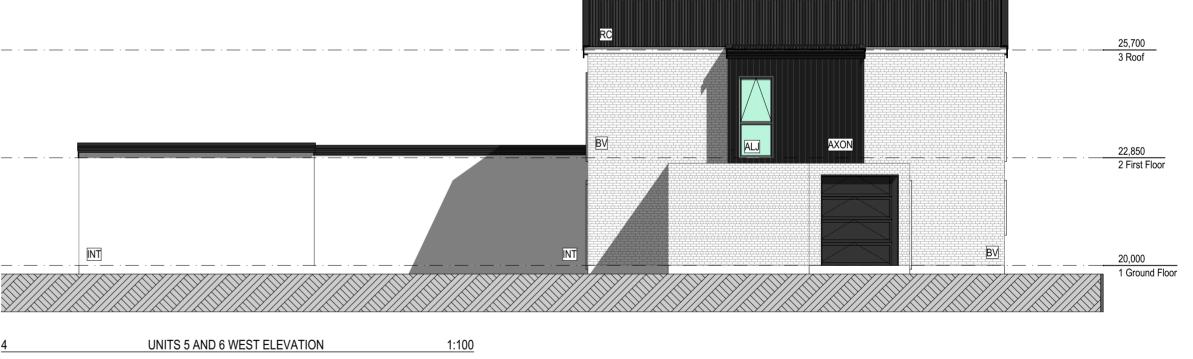

Notes **Aluminium Joinery** Double glazed aluminium joinery refer to specification. James Hardie Axon panel Axon panel over H3.1 45x20mm Radiata battens at 300mm centers over wall underlay over H1.2 90x45mm

Radiata framing with studs at 600mm centres and dwangs at

800mm centres. Panel to

overhang slab by 50mm.

Bottom plate fixed with 135mm

hold down bolts at 1200mm RC centers and 150mm **Brick Veneer**

70 series brick veneer over 50mm cavity

Resene Facade System Integra Lightweight Concrete Facade System - Integra 50mm Panel on 20mm Cavity on wall underlay on H1.2 SG8 90x45mm Radiata framing with studs at 600mm centres and dwangs at 800mm centres. Refer to supporting documentation.

0.55mm BMT Longrun Trapezoidal roof cladding over roofing underlay over H1.2 75 x 45mm SG8 radiata purlins @ 900mm centres with 600mm end purlins


urban arch


The Groynes Development Lot 502 - Groynes Park Christchurch


UNITS 5 AND 6 ELEVATIONS

Date: 14/07/2021 Issue: PRELIMINARY BC Revision: A Scale: 1:100 @ A3

A503

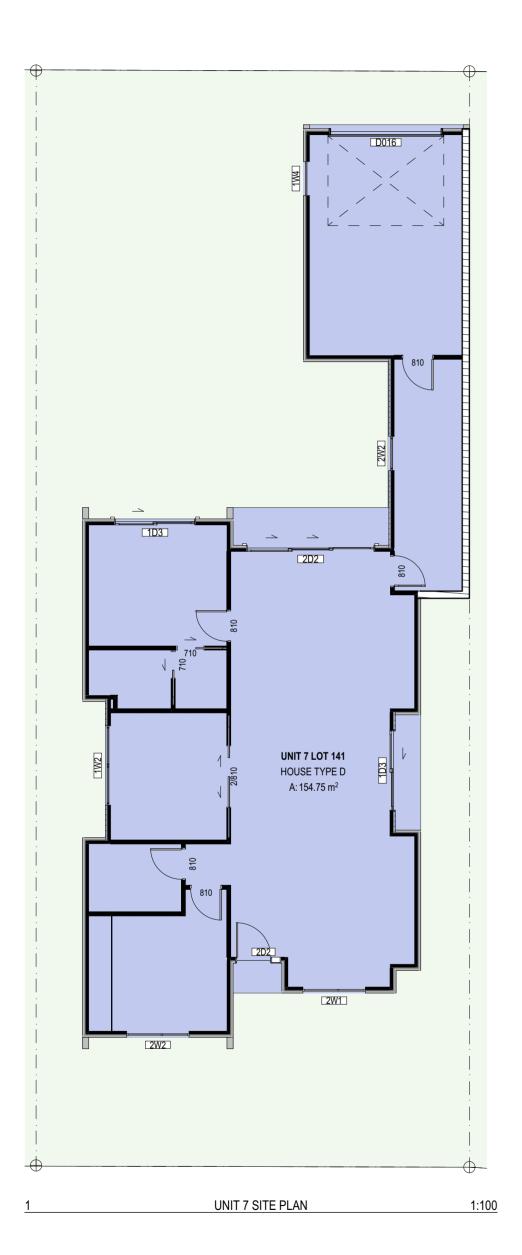

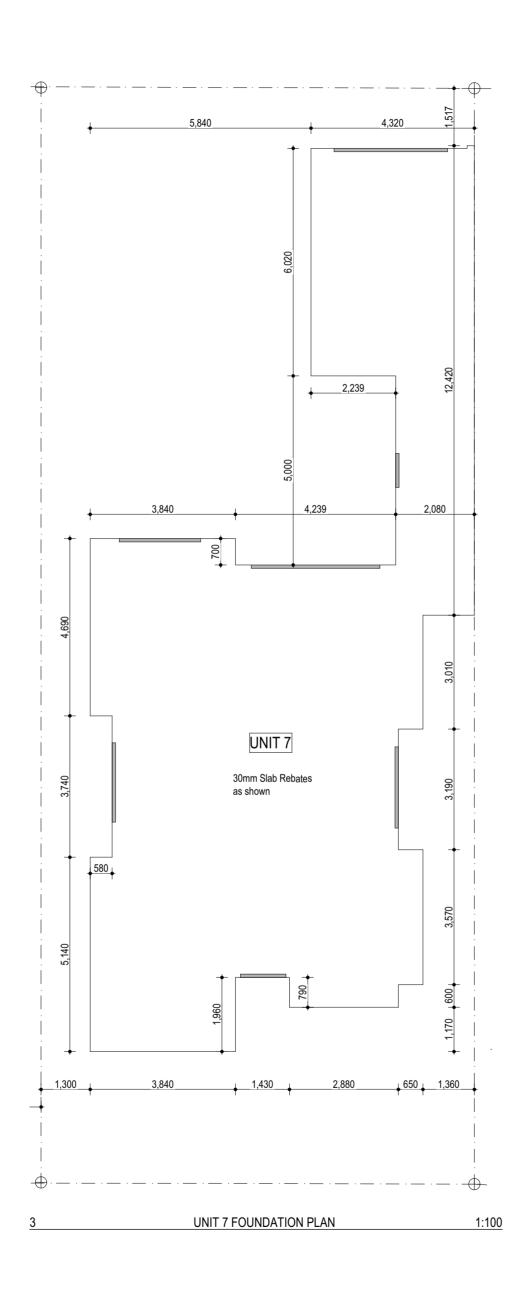

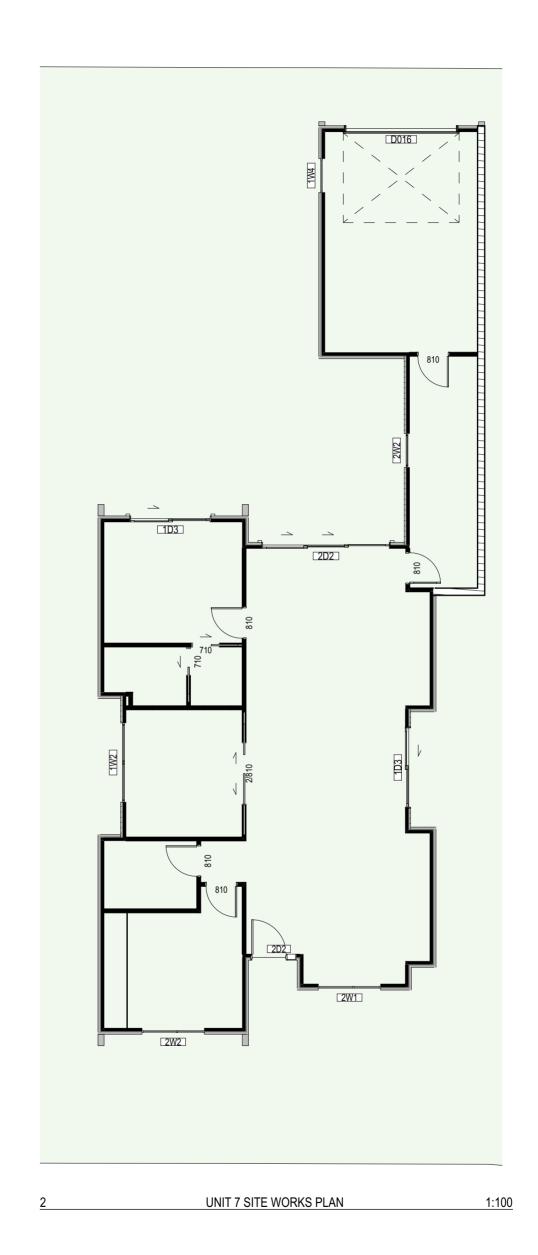



SITE INFORMATION: LOT 141 - UNIT 7

Address Lot 502 - Groynes Park Christchurch

Legal Lot 502 DP 475955
Land Use Zone Residential New Neighbourhood Zone

Climate Zone 3 Earthquake Zone 2

Exposure Zone C
Rainfall range 30 - 40
Wind Region A
Wind Zone High
Building height 8m maximum

LMA Liquifaction Management Area
Roads Milton Street is a Minor Arterial

Area Calculations :

Site Area 331.81sqm +/-

Site Area 331.81sq Site Coverage :

Allowed 40% 132.72sqm Achieved 46.6% 154.75sqm

Impervious areas X% Xsqm

Pervious areas X% Xsqm
At least 50% of the landscaping shall be trees and shrubs.

Recession Planes

North Milton Street NA
South 37 degrees

South 37 degrees
East 50
West 38

LEGEND



New tree 1.5m minimum height at time of planting.

Visibility splay, clear from 1m above from 2m either side of the access for a depth of 2m

Exposed aggregate




Brushed concrete


Low planting







<u>1 UNIT 7 GROUND FLOOR PLAN 1:100</u> <u>2 UNIT 7 ROOF PLAN 1:100</u>

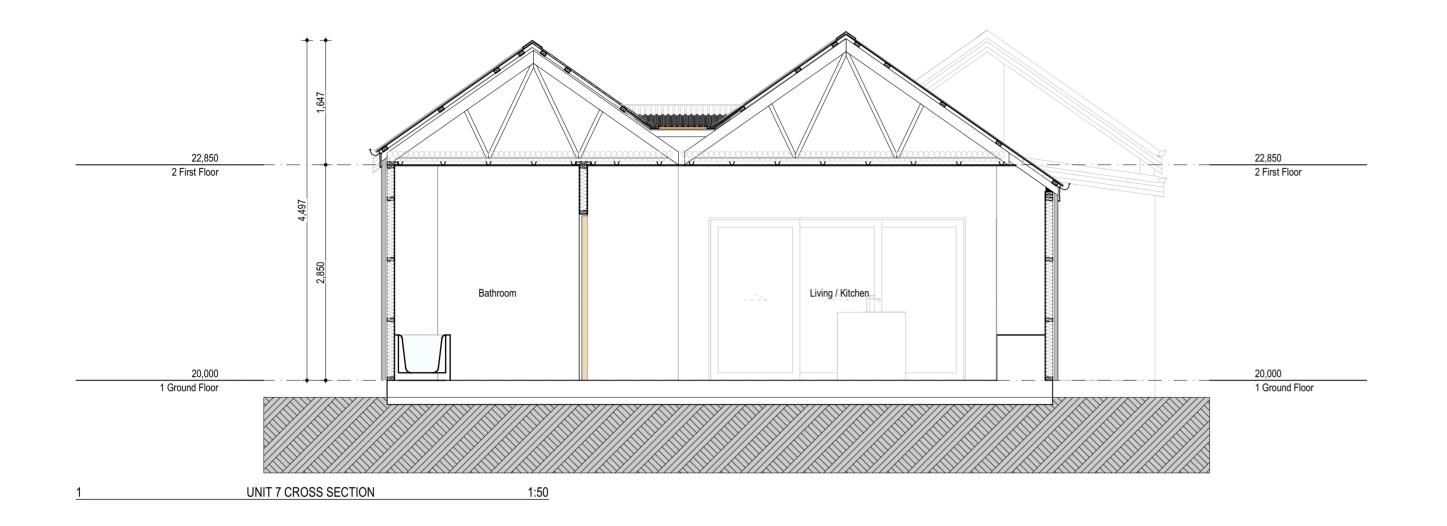


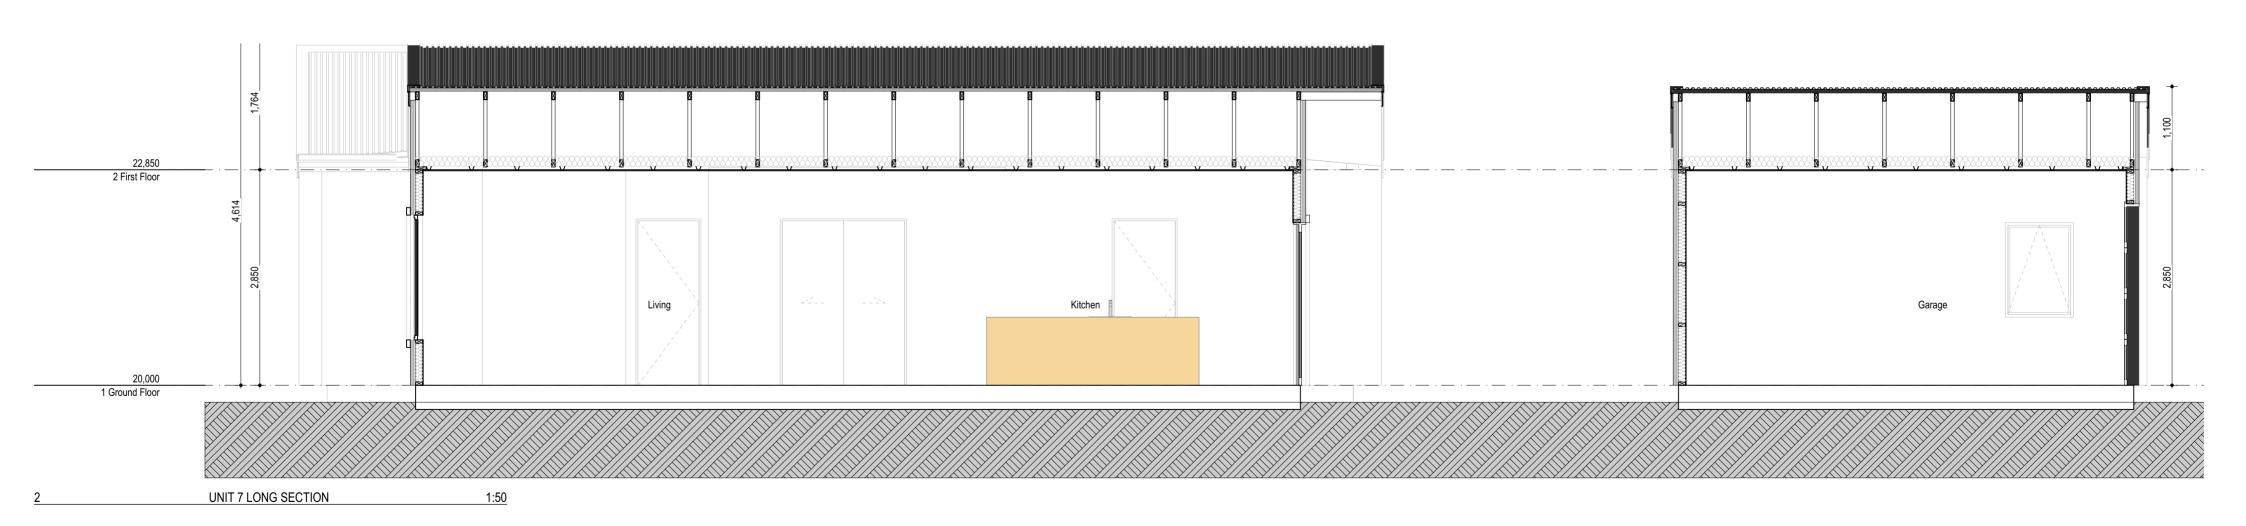



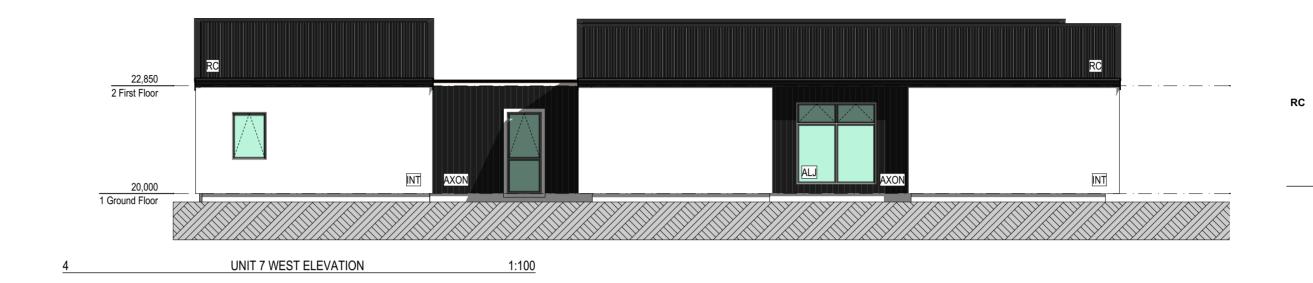

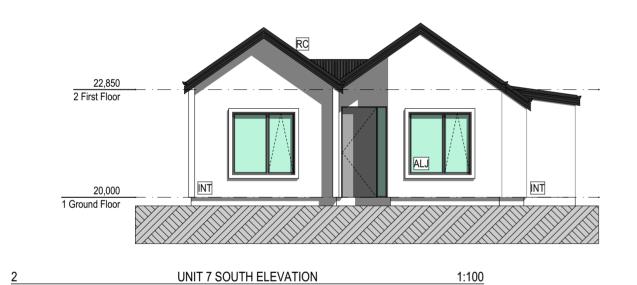

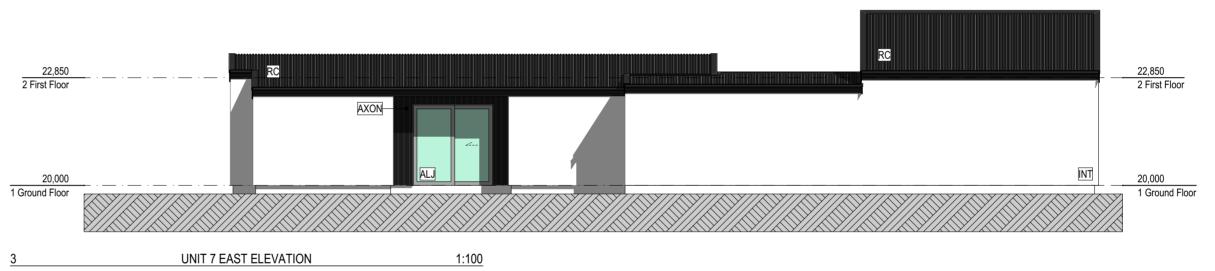

urban arch

The Groynes Development
Lot 502 - Groynes Park Christchurch

Sheet title:
UNIT 7 - ELEVATIONS

Date: 14/07/2021 Issue: PRELIMINARY BC Revision: A Scale: 1:100 @ A3

Notes

Aluminium Joinery

centers and 150mm

Resene Facade System

documentation.

Roof Cladding

end purlins

James Hardie Axon panel

to specification.


Double glazed aluminium joinery refer


Axon panel over H3.1 45x20mm Radiata battens at 300mm centers over wall underlay over H1.2 90x45mm Radiata framing with studs at 600mm centres and dwangs at 800mm centres. Panel to overhang slab by 50mm. Bottom plate fixed with 135mm hold down bolts at 1200mm

Integra Lightweight Concrete Facade System - Integra 50mm Panel on 20mm Cavity on wall underlay on H1.2 SG8 90x45mm Radiata framing with studs at 600mm centres and dwangs at 800mm centres. Refer to supporting

0.55mm BMT Longrun Trapezoidal roof cladding over roofing underlay over H1.2 75 x 45mm SG8 radiata purlins @ 900mm centres with 600mm

A601

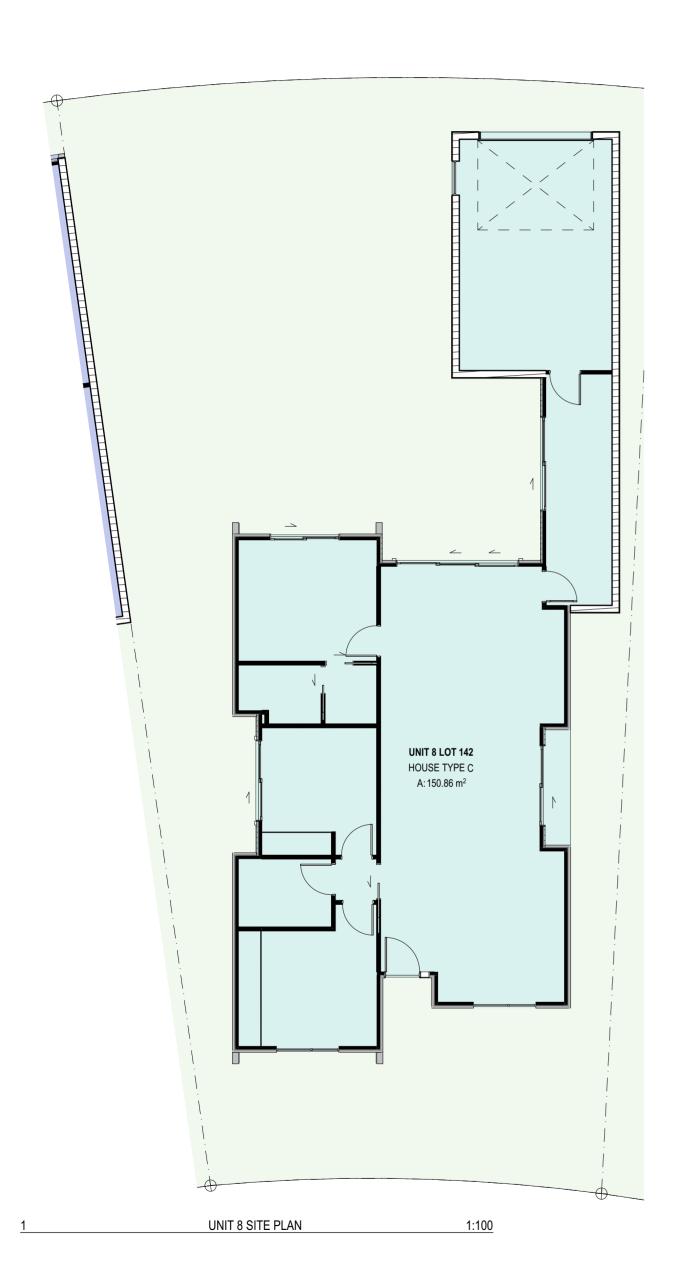

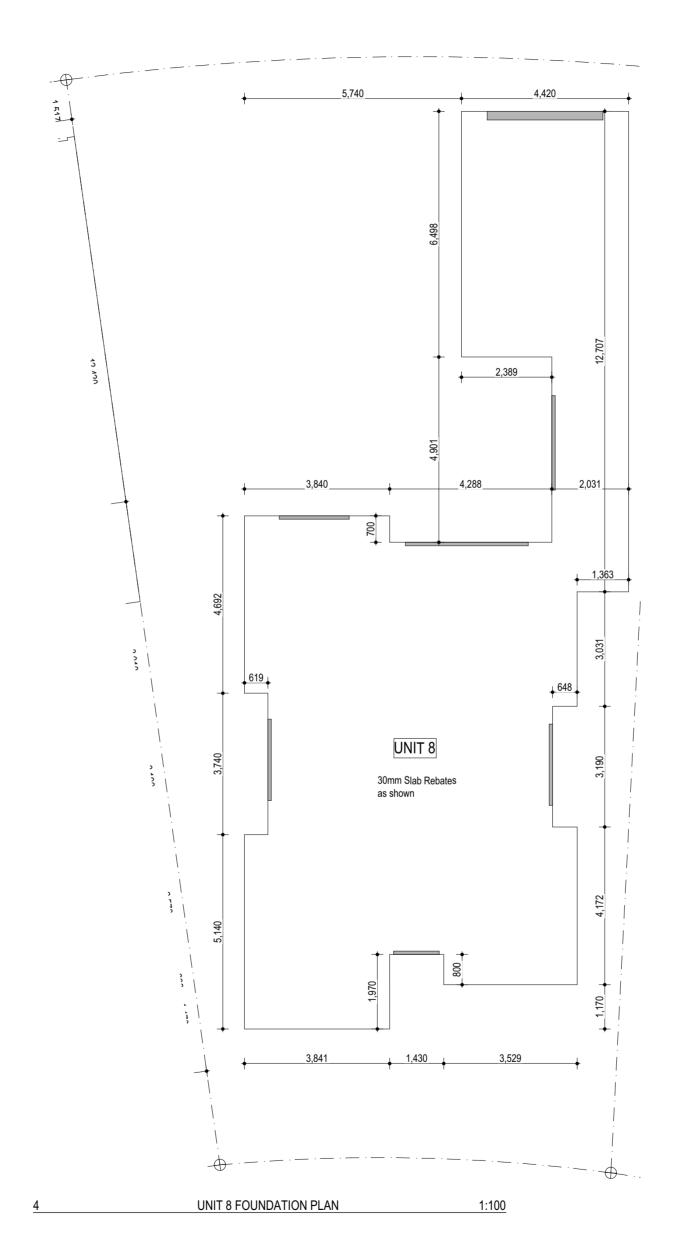



SITE INFORMATION: LOT 142 - UNIT 8

Lot 502 - Groynes Park Christchurch

Lot 502 DP 475955 Legal Land Use Zone Residential New Neighbourhood Zone

Climate Zone Earthquake Zone Exposure Zone

Rainfall range Wind Region Wind Zone Building height 8m maximum

LMA Liquifaction Management Area Roads Milton Street is a Minor Arterial

Area Calculations:

382.7sqm +/-Site Area

Site Coverage : 40% 153.08sqm Allowed

Achieved 39.4% 150.86sqm X% Xsqm Impervious areas

Pervious areas X% Xsqm At least 50% of the landscaping shall be trees and

shrubs.

Recession Planes

Milton Street NA North South 37 degrees

East

LEGEND



Visibility splay, clear from 1m above from 2m either side of

New tree 1.5m minimum height at time of planting.

the access for a depth of 2m

Exposed aggregate


Brushed concrete












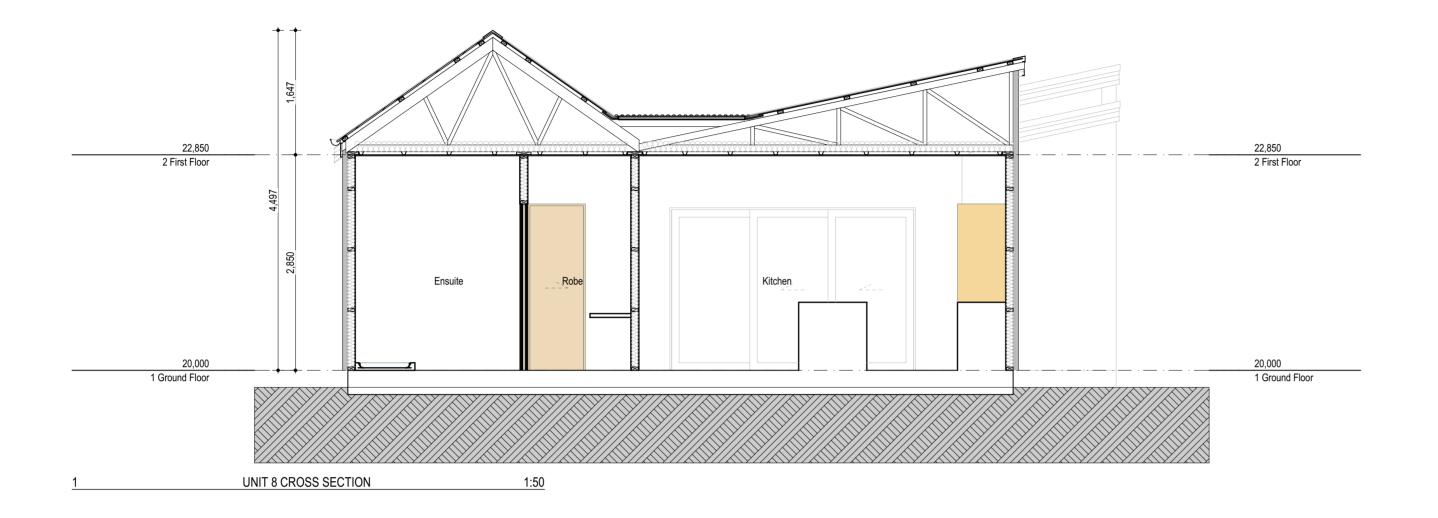


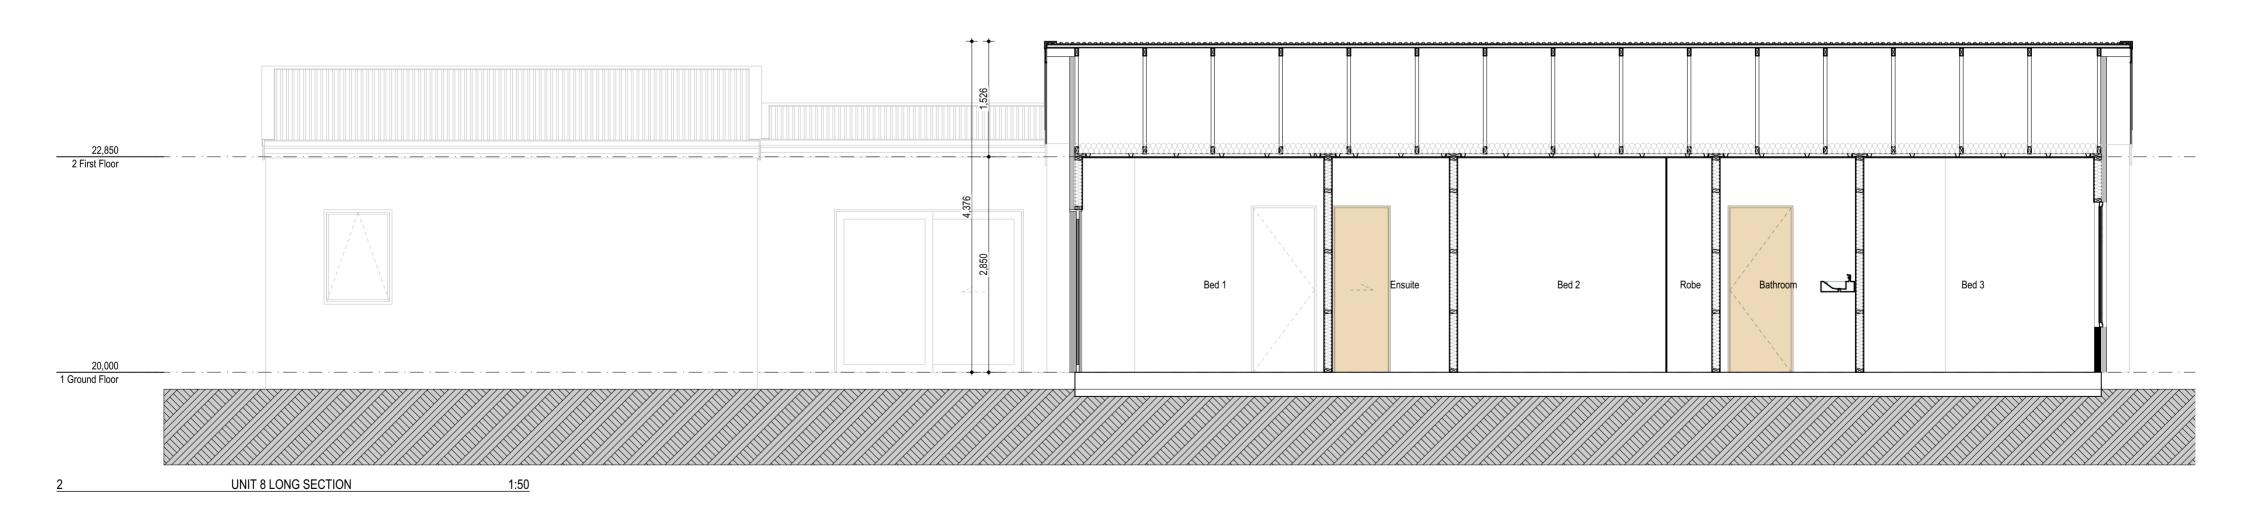

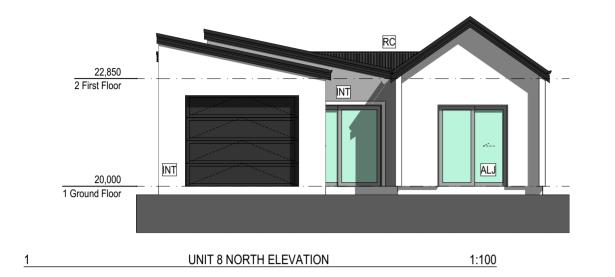

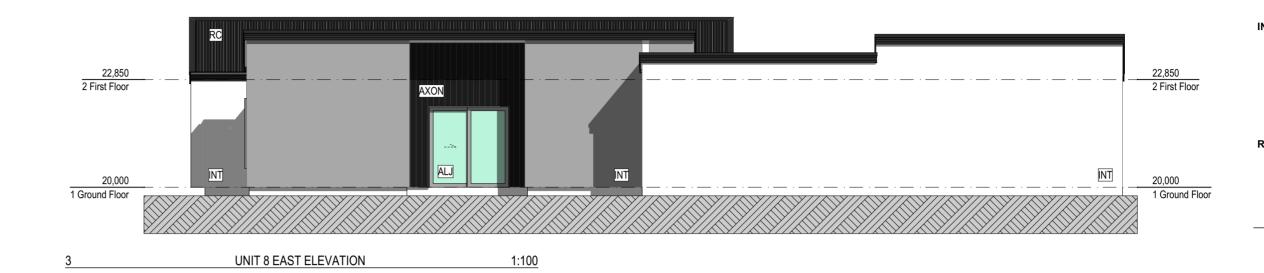



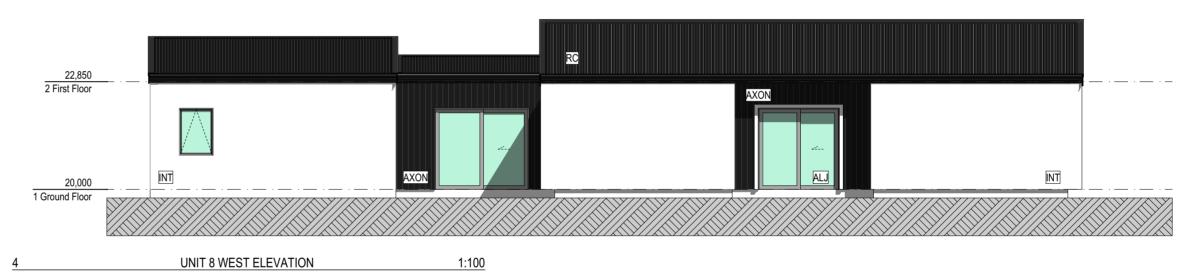

Aluminium Joinery

centers and 150mm

Brick Veneer

Resene Facade System

documentation.

Roof Cladding

end purlins

cavity

James Hardie Axon panel

to specification.

Double glazed aluminium joinery refer

Axon panel over H3.1 45x20mm Radiata battens at 300mm centers over wall underlay over H1.2 90x45mm Radiata framing with studs at 600mm centres and dwangs at 800mm centres. Panel to overhang slab by 50mm. Bottom plate fixed with 135mm hold down bolts at 1200mm

70 series brick veneer over 50mm


Integra Lightweight Concrete Facade System - Integra 50mm Panel on 20mm Cavity on wall underlay on H1.2


SG8 90x45mm Radiata framing with studs at 600mm centres and dwangs at 800mm centres. Refer to supporting

0.55mm BMT Longrun Trapezoidal roof cladding over roofing underlay

over H1.2 75 x 45mm SG8 radiata

purlins @ 900mm centres with 600mm

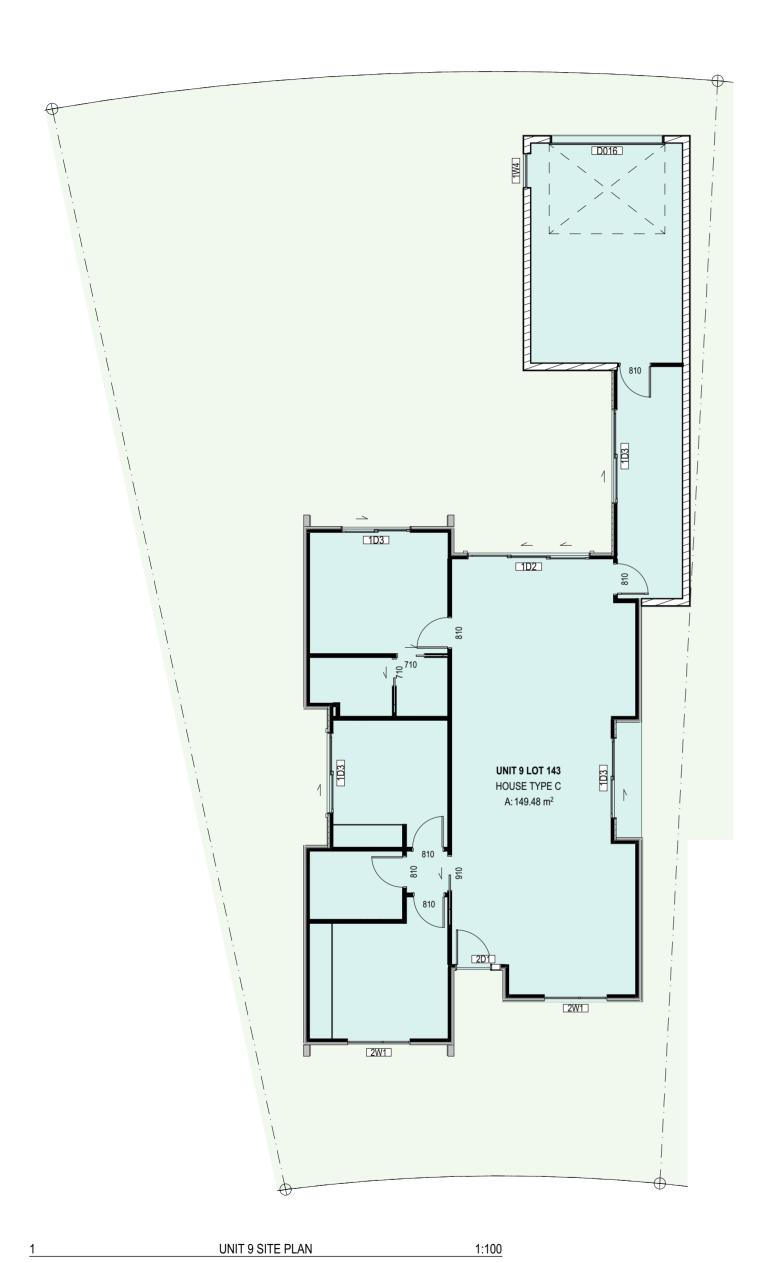

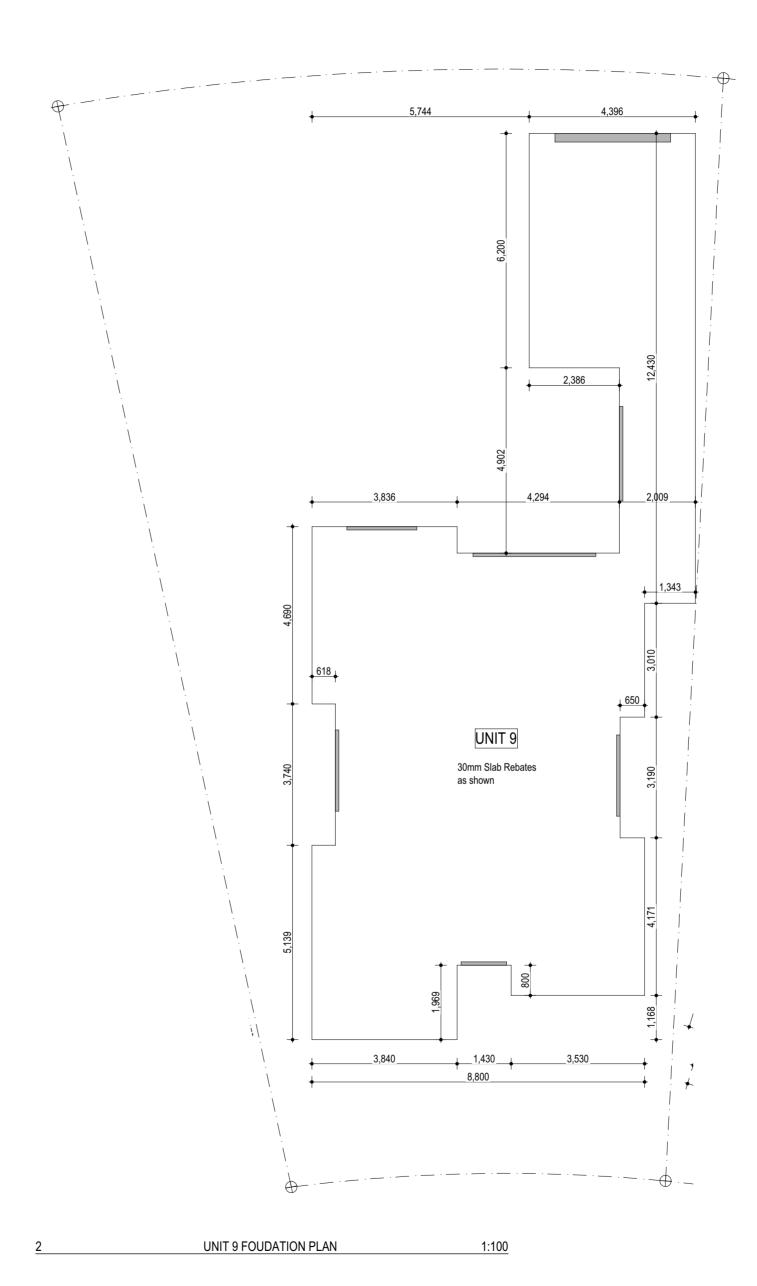



SITE INFORMATION: LOT 143 - UNIT 9

Lot 502 - Groynes Park Christchurch

Lot 502 DP 475955 Legal

Land Use Zone Residential New Neighbourhood Zone Climate Zone

Earthquake Zone Exposure Zone Rainfall range Wind Region Wind Zone

Building height 8m maximum LMA Liquifaction Management Area Roads Milton Street is a Minor Arterial

Area Calculations:

Site Area 402.7sqm +/-

Site Coverage :

40% 161.08sqm Allowed Achieved 37.1% 149.48sqm

Xsqm Impervious areas

Pervious areas X% Xsqm At least 50% of the landscaping shall be trees and

shrubs.

Recession Planes

Milton Street NA North South 37 degrees

East

LEGEND



New tree 1.5m minimum height at time of planting.

Visibility splay, clear from 1m above from 2m either side of the access for a depth of 2m

Exposed aggregate


Brushed concrete

Low planting










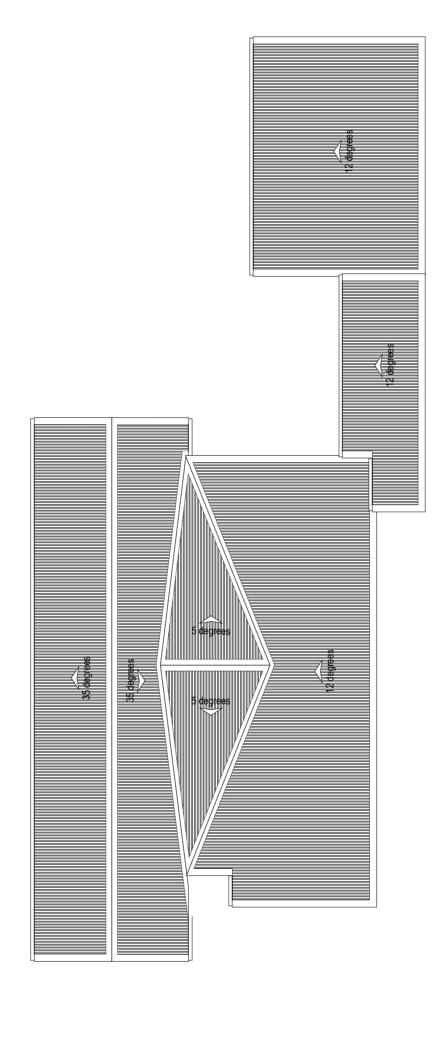


<u>1 UNIT 9 GROUND FLOOR PLAN</u> 1:100 <u>2 UNIT 9 ROOF PLAN</u> 1:100

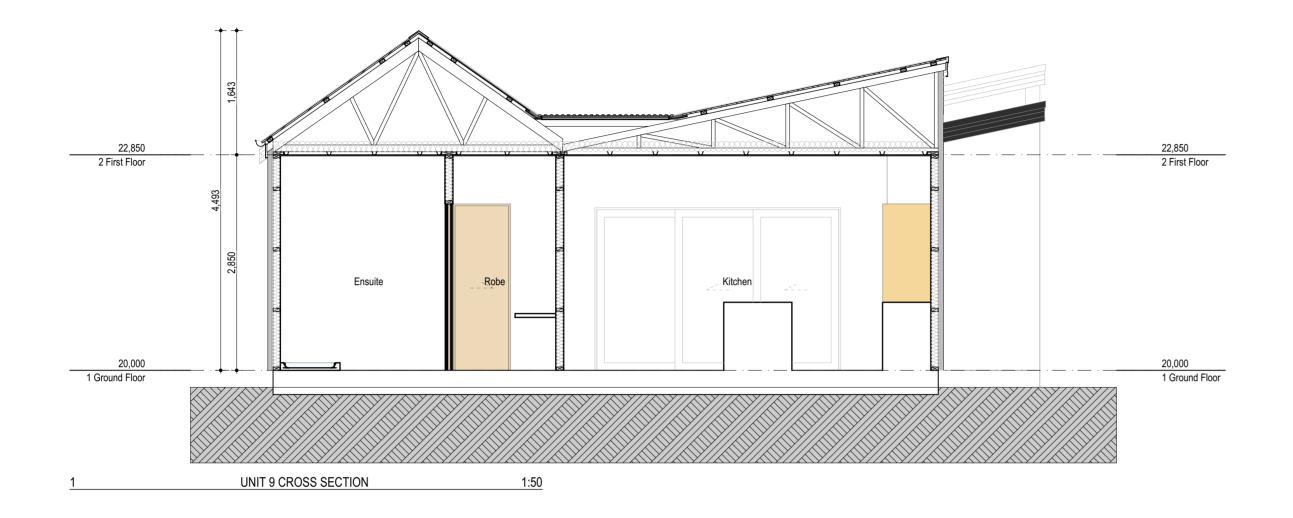


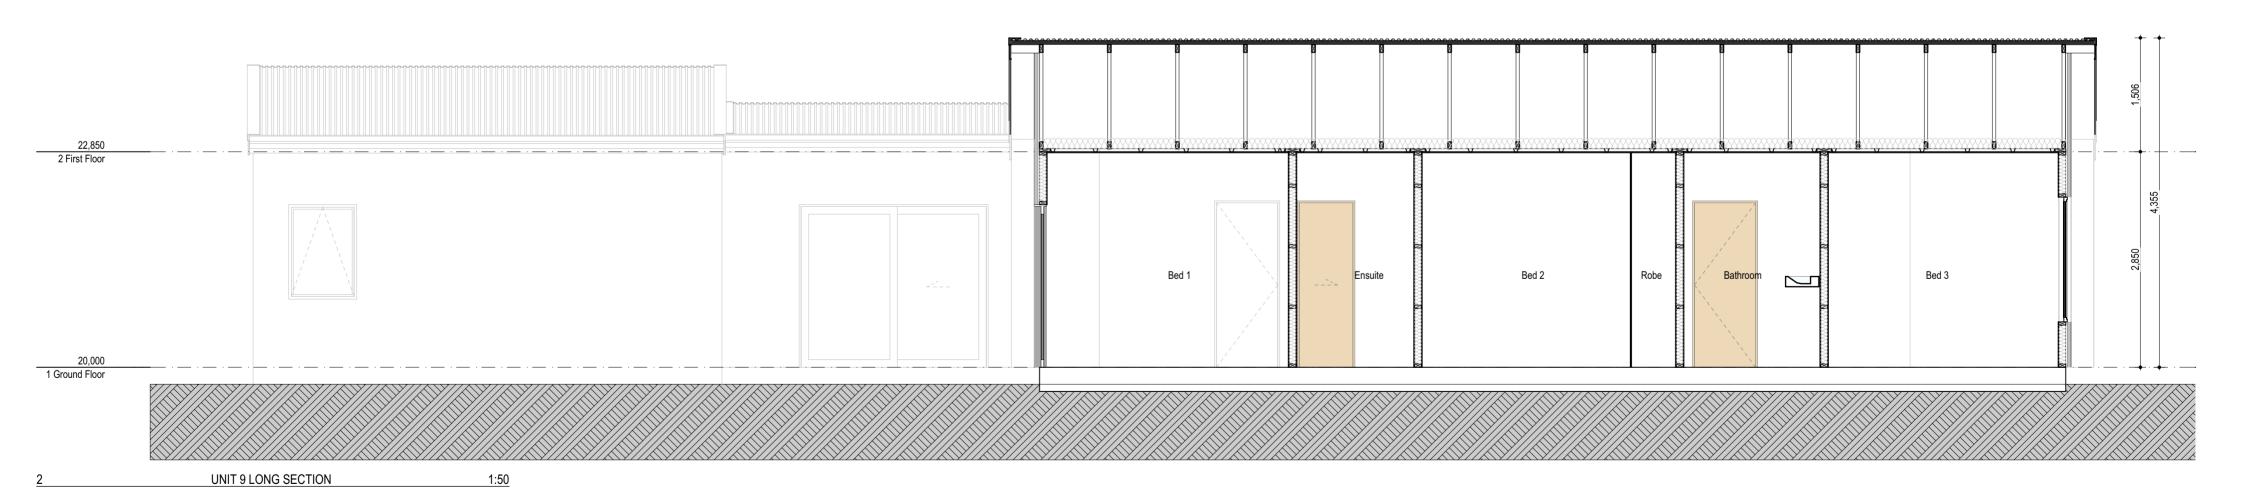

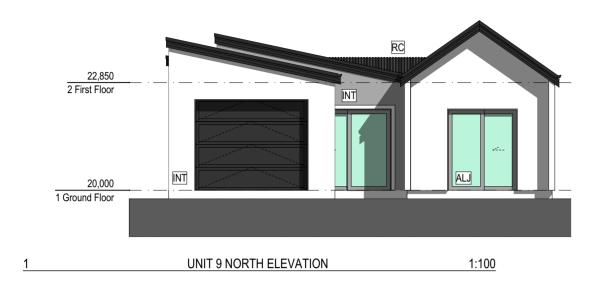

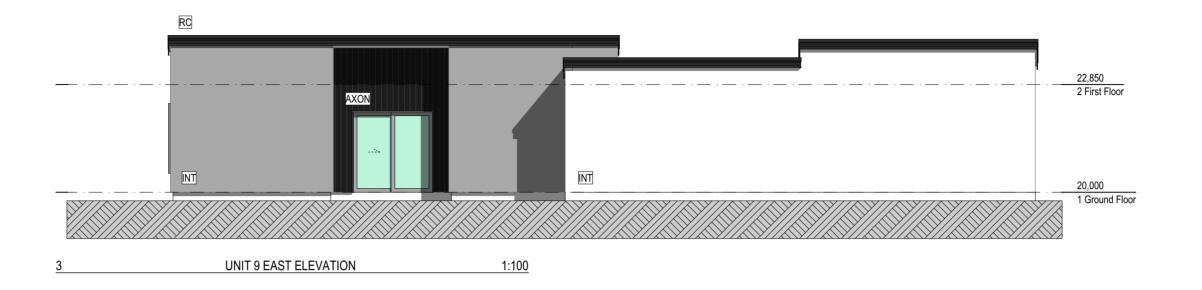



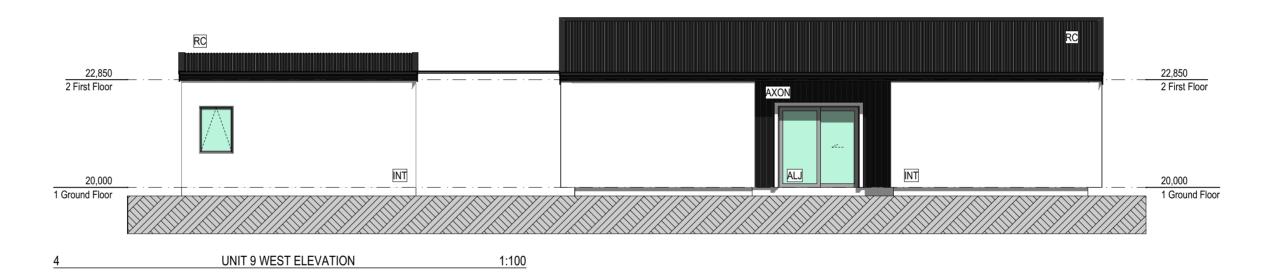

Aluminium Joinery

centers and 150mm

Resene Facade System

documentation.

Roof Cladding

end purlins

James Hardie Axon panel

to specification.

Double glazed aluminium joinery refer

Axon panel over H3.1 45x20mm Radiata battens at 300mm centers over wall underlay over H1.2 90x45mm Radiata framing with studs at 600mm centres and dwangs at 800mm centres. Panel to overhang slab by 50mm. Bottom plate fixed with 135mm hold down bolts at 1200mm

Integra Lightweight Concrete Facade System - Integra 50mm Panel on 20mm Cavity on wall underlay on H1.2 SG8 90x45mm Radiata framing with studs at 600mm centres and dwangs at 800mm centres. Refer to supporting

0.55mm BMT Longrun Trapezoidal roof cladding over roofing underlay over H1.2 75 x 45mm SG8 radiata purlins @ 900mm centres with 600mm





SITE INFORMATION: LOT 144 - UNIT 10

Lot 502 - Groynes Park Christchurch

Lot 502 DP 475955 Legal Land Use Zone Residential New Neighbourhood Zone

Climate Zone Earthquake Zone Exposure Zone Rainfall range

Wind Region Wind Zone Building height 8m maximum

Liquifaction Management Area Roads Milton Street is a Minor Arterial

Area Calculations:

Impervious areas

Site Area 394.12sqm +/-Site Coverage :

40% 157.65sqm Allowed Achieved 39.5% 156.05sqm

Pervious areas X% Xsqm At least 50% of the landscaping shall be trees and

X%

Xsqm

shrubs.

Recession Planes

Milton Street NA North South 37 degrees East

LEGEND

Visibility splay, clear from 1m above from 2m either side of

New tree 1.5m minimum height at time of planting.

the access for a depth of 2m

Exposed aggregate


Brushed concrete


Low planting







<u>1 UNIT 10 GROUND FLOOR PLAN</u> 1:100 <u>2 UNIT 10 ROOF PLAN</u> 1:100

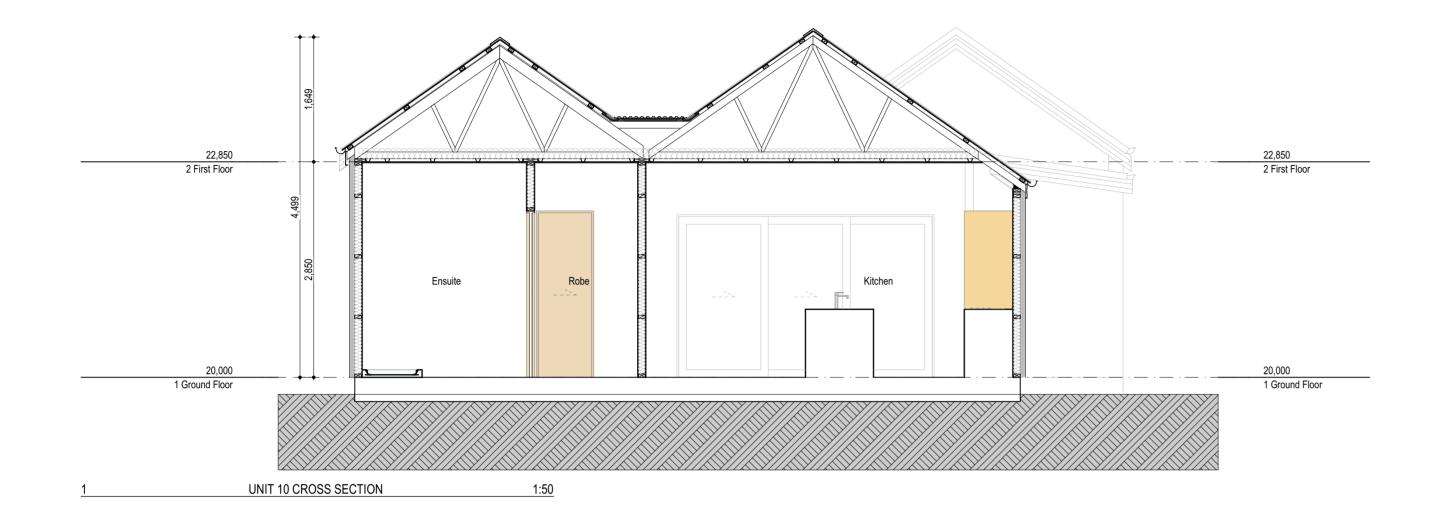


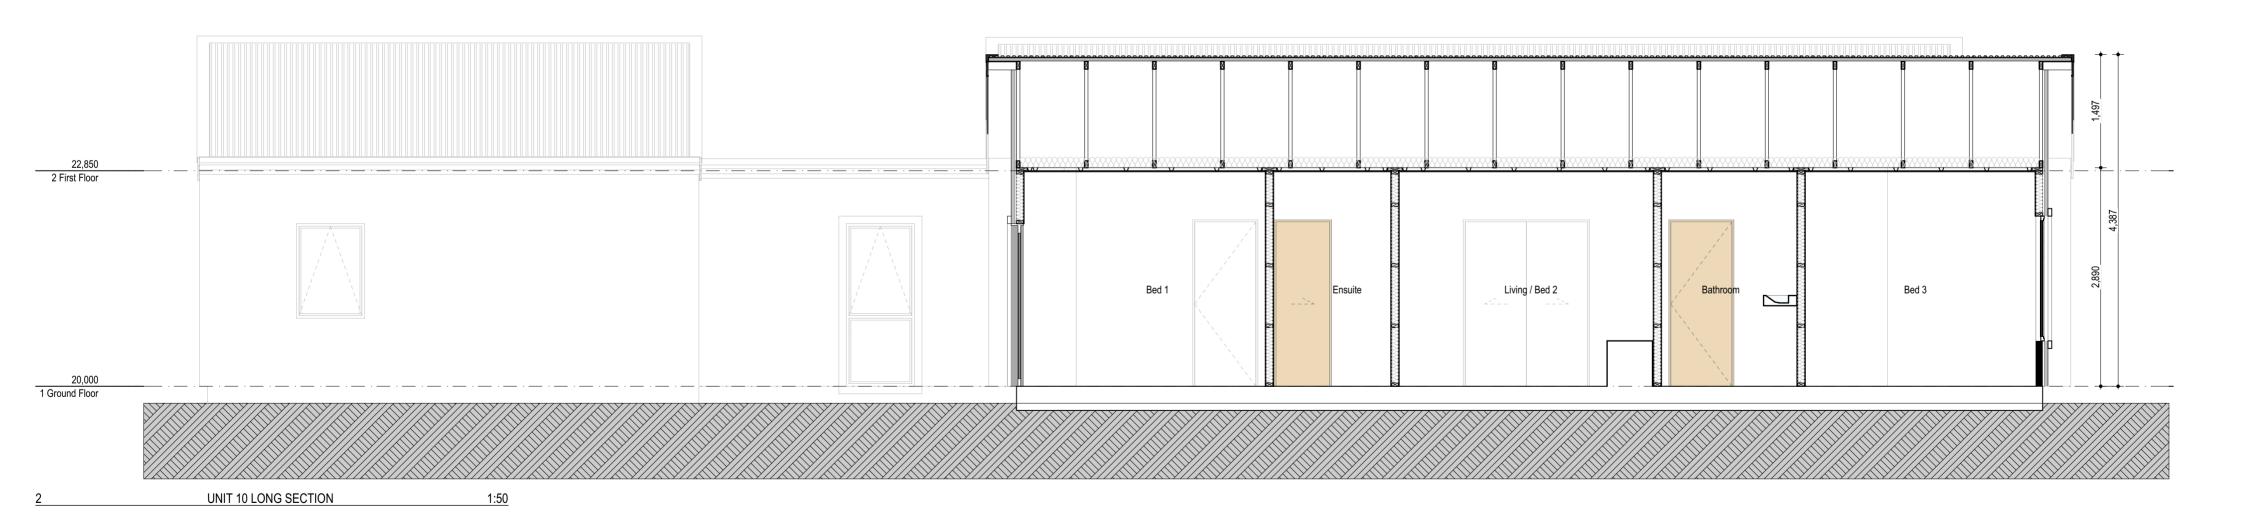

22,850 2 First Floor 20,000 1 Ground Floor UNIT 10 NORTH ELEVATION 1:100

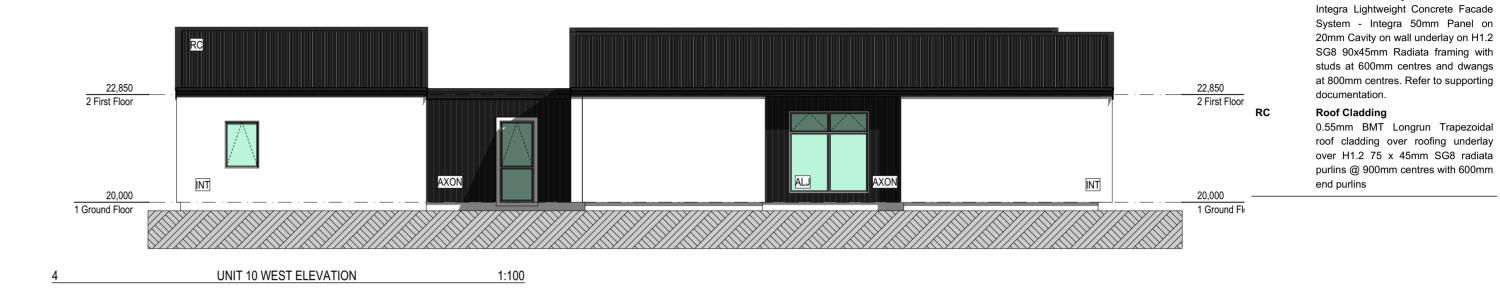

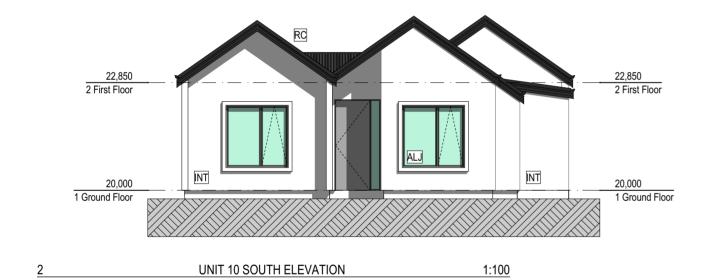

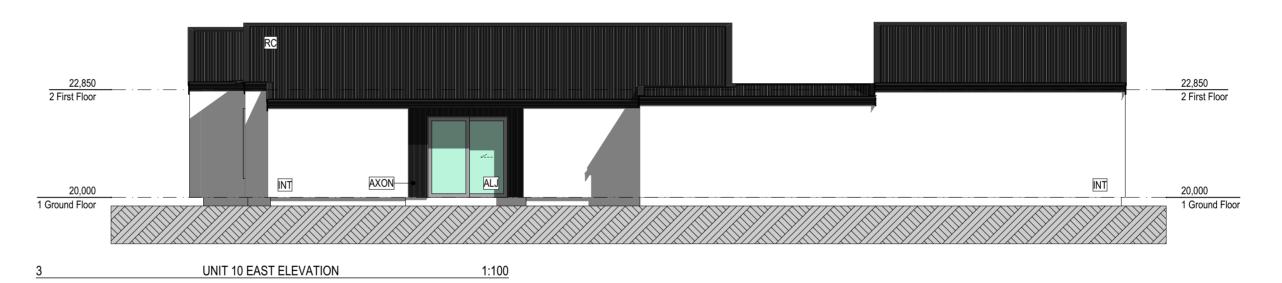

Notes

Aluminium Joinery

centers and 150mm


Resene Facade System


James Hardie Axon panel

to specification.

Double glazed aluminium joinery refer

Axon panel over H3.1 45x20mm Radiata battens at 300mm centers over wall underlay over H1.2 90x45mm Radiata framing with studs at 600mm centres and dwangs at 800mm centres. Panel to overhang slab by 50mm. Bottom plate fixed with 135mm hold down bolts at 1200mm

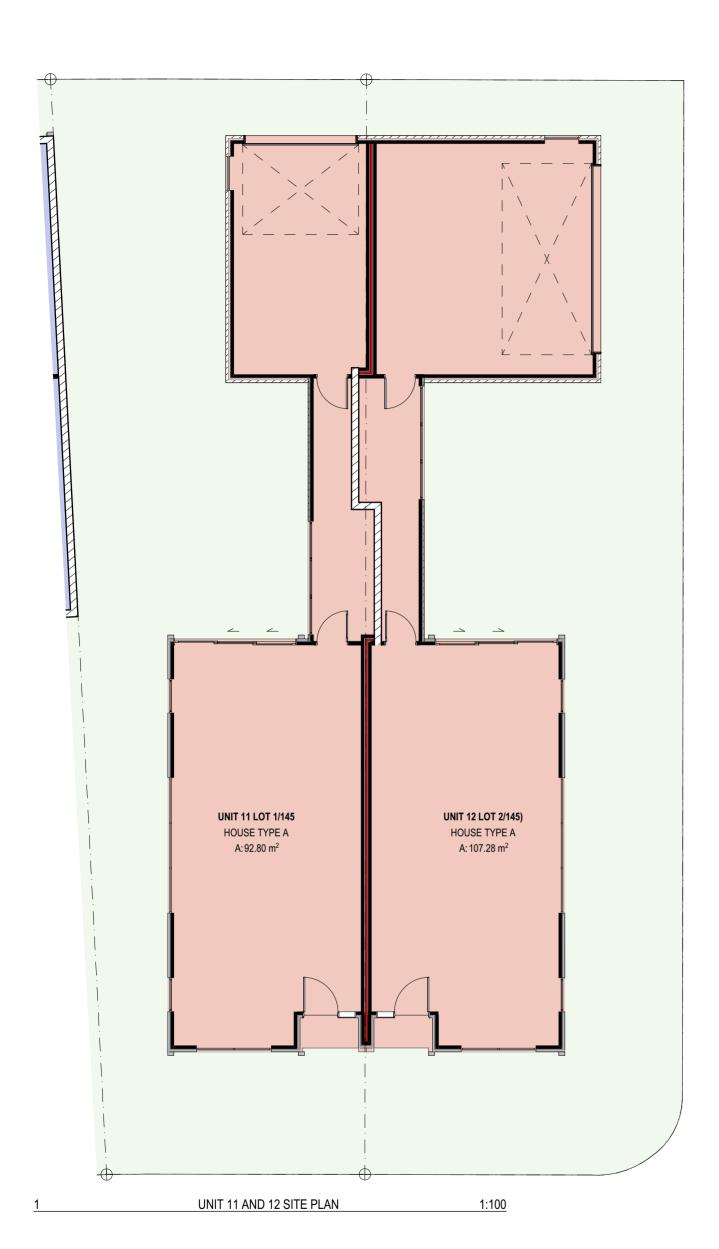

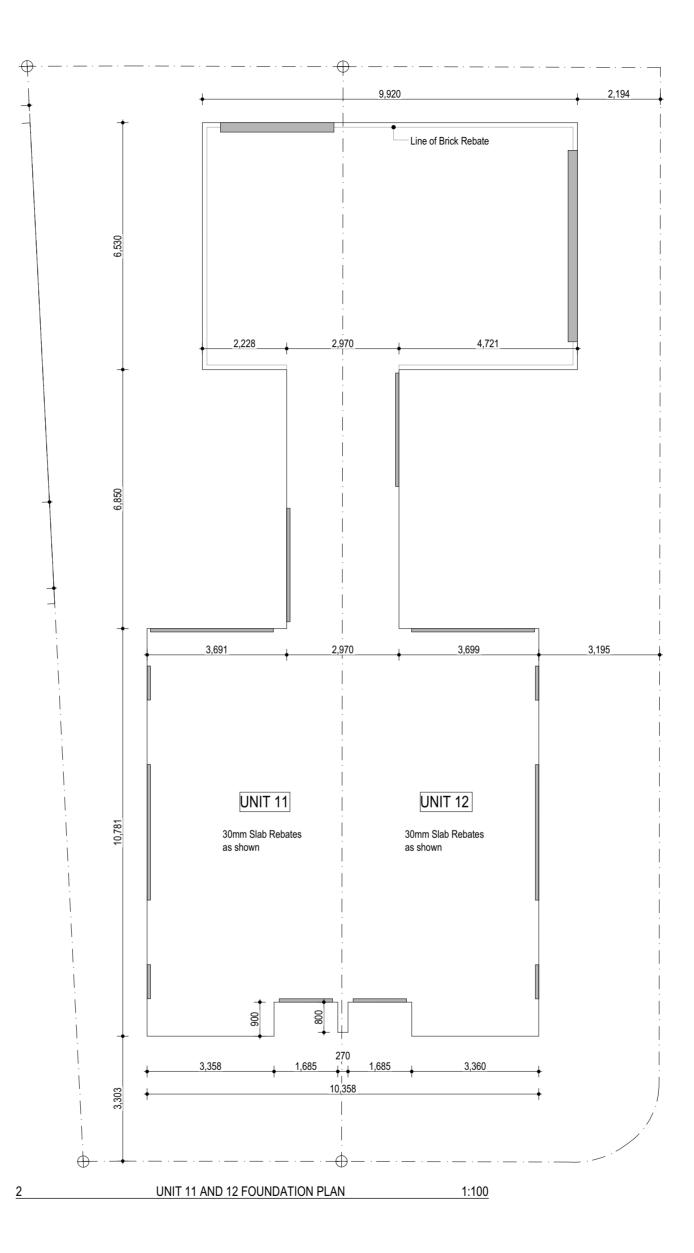



SITE INFORMATION: LOT 1/145 - UNIT 11

Lot 502 - Groynes Park Christchurch

Lot 502 DP 475955 Land Use Zone Residential New Neighbourhood Zone

Climate Zone Earthquake Zone Exposure Zone

Rainfall range Wind Region Wind Zone **Building height** 8m maximum

LMA Liquifaction Management Area Roads Milton Street is a Minor Arterial

Area Calculations :

Site Area Unit 11

221.4sqm +/-Unit 12 240.6sqm +/-

Site Coverage : Achieved

Unit 11 41.9% 92.80sqm 44.5% 107.28sqm Unit 12 88.56sqm

Impervious areas X% Xsqm

Pervious areas X% Xsqm At least 50% of the landscaping shall be trees and

Recession Planes

Milton Street NA South 37 degrees East

LEGEND




New tree 1.5m minimum height at time of planting.

Visibility splay, clear from 1m above from 2m either side of the access for a depth of 2m





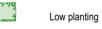







urban arch

The Groynes Development
Lot 502 - Groynes Park Christchurch

Sheet title: UNITS 11 AND 12 - GROUND / FIRST AND ROOF PLANS

Date: 14/07/2021 Issue: PRELIMINARY BC Revision: A Scale: 1:100 @ A3

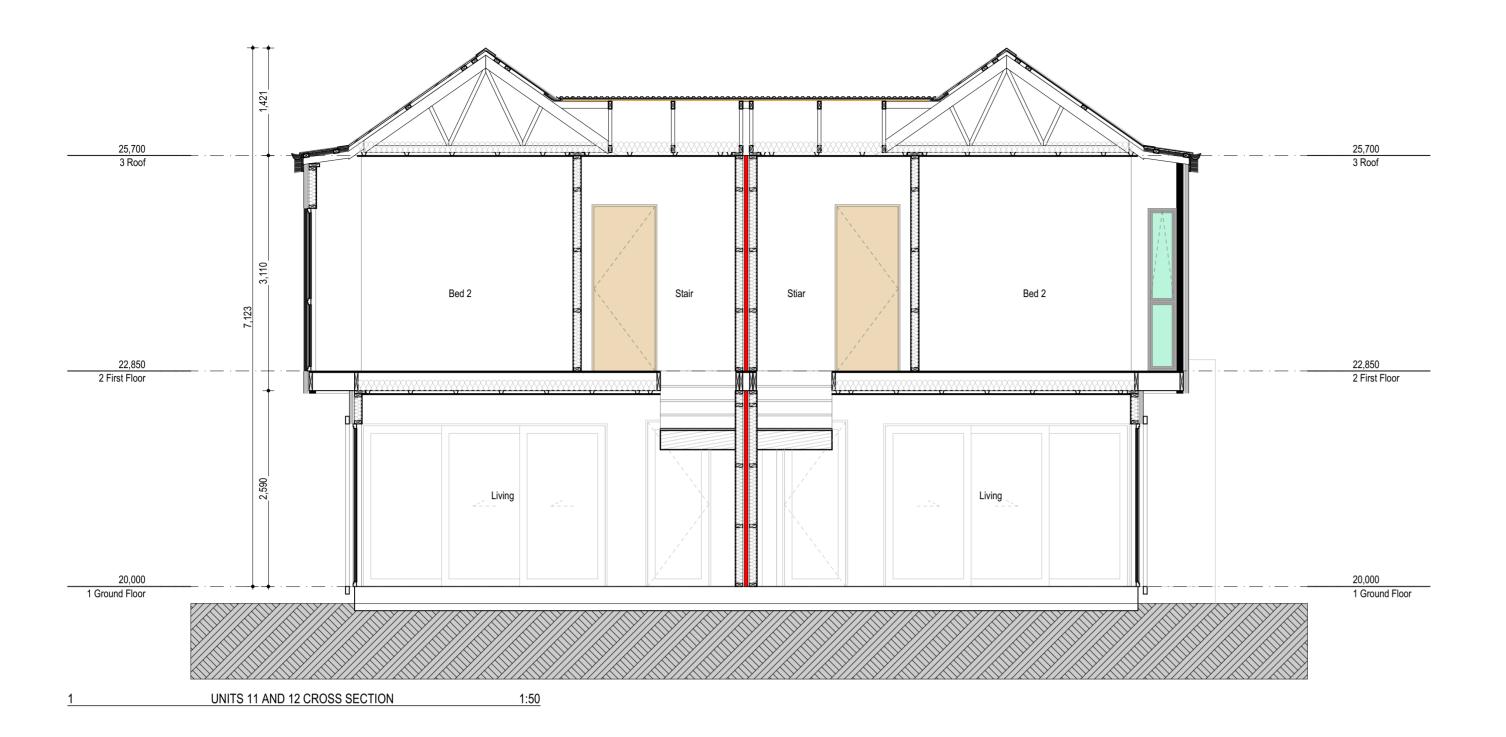

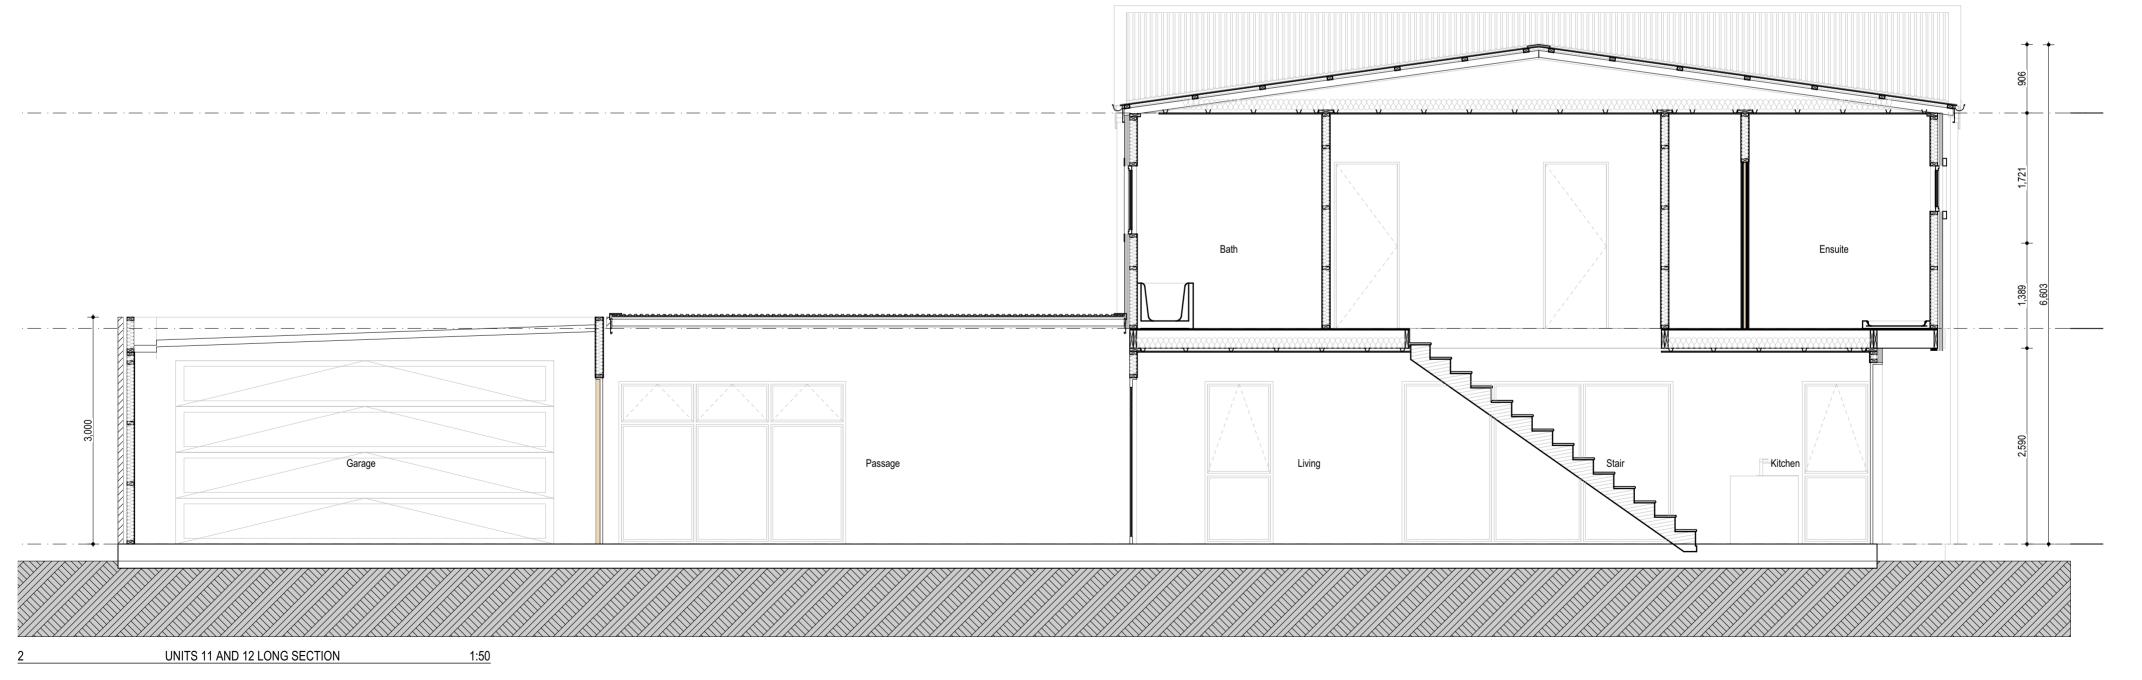









Aluminium Joinery Double glazed aluminium joinery refer to specification.

James Hardie Axon panel

Axon panel over H3.1 45x20mm Radiata battens at 300mm centers over wall underlay over H1.2 90x45mm Radiata framing with studs at 600mm centres and dwangs at 800mm centres. Panel to overhang slab by 50mm. Bottom plate fixed with

1200mm centers and 150mm

Brick Veneer 70 series brick veneer over 50mm cavity

Resene Facade System Integra Lightweight Concrete Facade System - Integra 50mm Panel on 20mm Cavity on wall underlay on H1.2 SG8 90x45mm Radiata framing with studs at 600mm centres and dwangs at 800mm centres. Refer to supporting

Roof Cladding 0.55mm BMT Longrun Trapezoidal roof cladding over roofing underlay over H1.2 75 x 45mm SG8 radiata purlins @ 900mm centres with 600mm end purlins