

### CODE COMPLIANCE CERTIFICATE

Section 95 Building Act 2004

Consent No: 160621



The Building

Street address of building:

137 Weggery Drive, Waikanae

Beach

**Building name:** 

Residential Dwelling

Location of building within

Refer site plan

Current, Lawfully

established, use:

Level/unit number:

site/block number:

Intended life of the building if

50 years or less:

Year first constructed:

Legal description of

land where building is located:

LOT 42 DP 60395 -SUBJ TO & INT IN VARIOUS EASEMENTS-

The Owner

Name of owner:

Jenkins Andrew John & Елока

Sara Teremoana

Contact person:

Judith Wadsworth

/registered office: Phone numbers:

Street address

Mailing address:

Email address:

137 Weggery Drive

Waikanae Beach

Landline: Mobile: Daytime:

027 087 7415

Waikanae 5036

judewadsworth2004@yahoo.co.nz

After hours:

027 555 5604

Website:

Facsimile number:

First point of contact for communications with the Kapiti Coast District Council:

Full Name: Versatile Buildings

Mailing Address: PO Box 54060, Mana 5247 Phones:: 027 482 7029: 04 233 9528

Fax: 04 233 9827

Email: craigs@versatile-wgn.co.nz

**Building Work** 

**Building Consent No:** 

160621

Issued by:

Kapiti Coast District Council

**Project Description:** 

New two bedroom sleepout.

Code Compliance

The building consent authority named below is satisfied, on reasonable grounds, that:

the building work complies with the building consent. (a)

Russell Brook - Team Leader - Site Inspections

On behalf of Kapiti Coast District Council

Date: 24 January 2017



### Statement of Compliance with the NZ Building Code

Consent No: 160621

ISSUED BY: Kapiti Coast District Council

#### **PROJECT**

Site Address: 137 Weggery Drive, Waikanae Beach

Legal Description: LOT 42 DP 60395 -SUBJ TO & INT INVARIOUS EASEMENTS-

Work Description: New two bedroom sleepout.

Building Category: R1

### **OWNER**

Name(s): A Jenkins, S Enoka & J Wadsworth Address: 137 Weggery Drive, Waikanae

- [P] Application for CCC received and accepted
- [P] Confirm all required inspections completed and documented in GoGet
- [NA] If inspection(s) have been missed, have they been compensated for?
- [NA] If supervision was required for any inspection did it occur?
- [P] Work in accordance with approved consent and approved amendments
- [NA] Have any notices to fix been uplifted?
- [P] Supporting documentation required in building consent addenda received
- [P] Quality assurance documentation
- [P] Restricted building work
- [NA] Additional information required and received
- [NA] Compliance schedule issued
- [NA] Earthquake prone building
- [NA] Swimming Pool details updated
- [P] Approve to issue Code Compliance Certificate if all fees paid
- [NA] Approve to issue Certificate for Public Use if all fees paid
- [NA] Approve to issue Certificate of Acceptance if all fees paid
- [NA] Supervision review

#### NOTES:

Inspections Prepaid: Inspections Done:

### LICENSED BUILDING PRACTITIONERS:

 Designer 2
 BP108601

 Carpentry 1
 BP120031


 Carpentry 2
 BP128362



On review of the documentation and inspection notes it can be considered on reasonable grounds that all work has been completed in compliance with the building consent.

Signed:

Name: Russell Brook Position: Building Officer Date: 24 January 2017

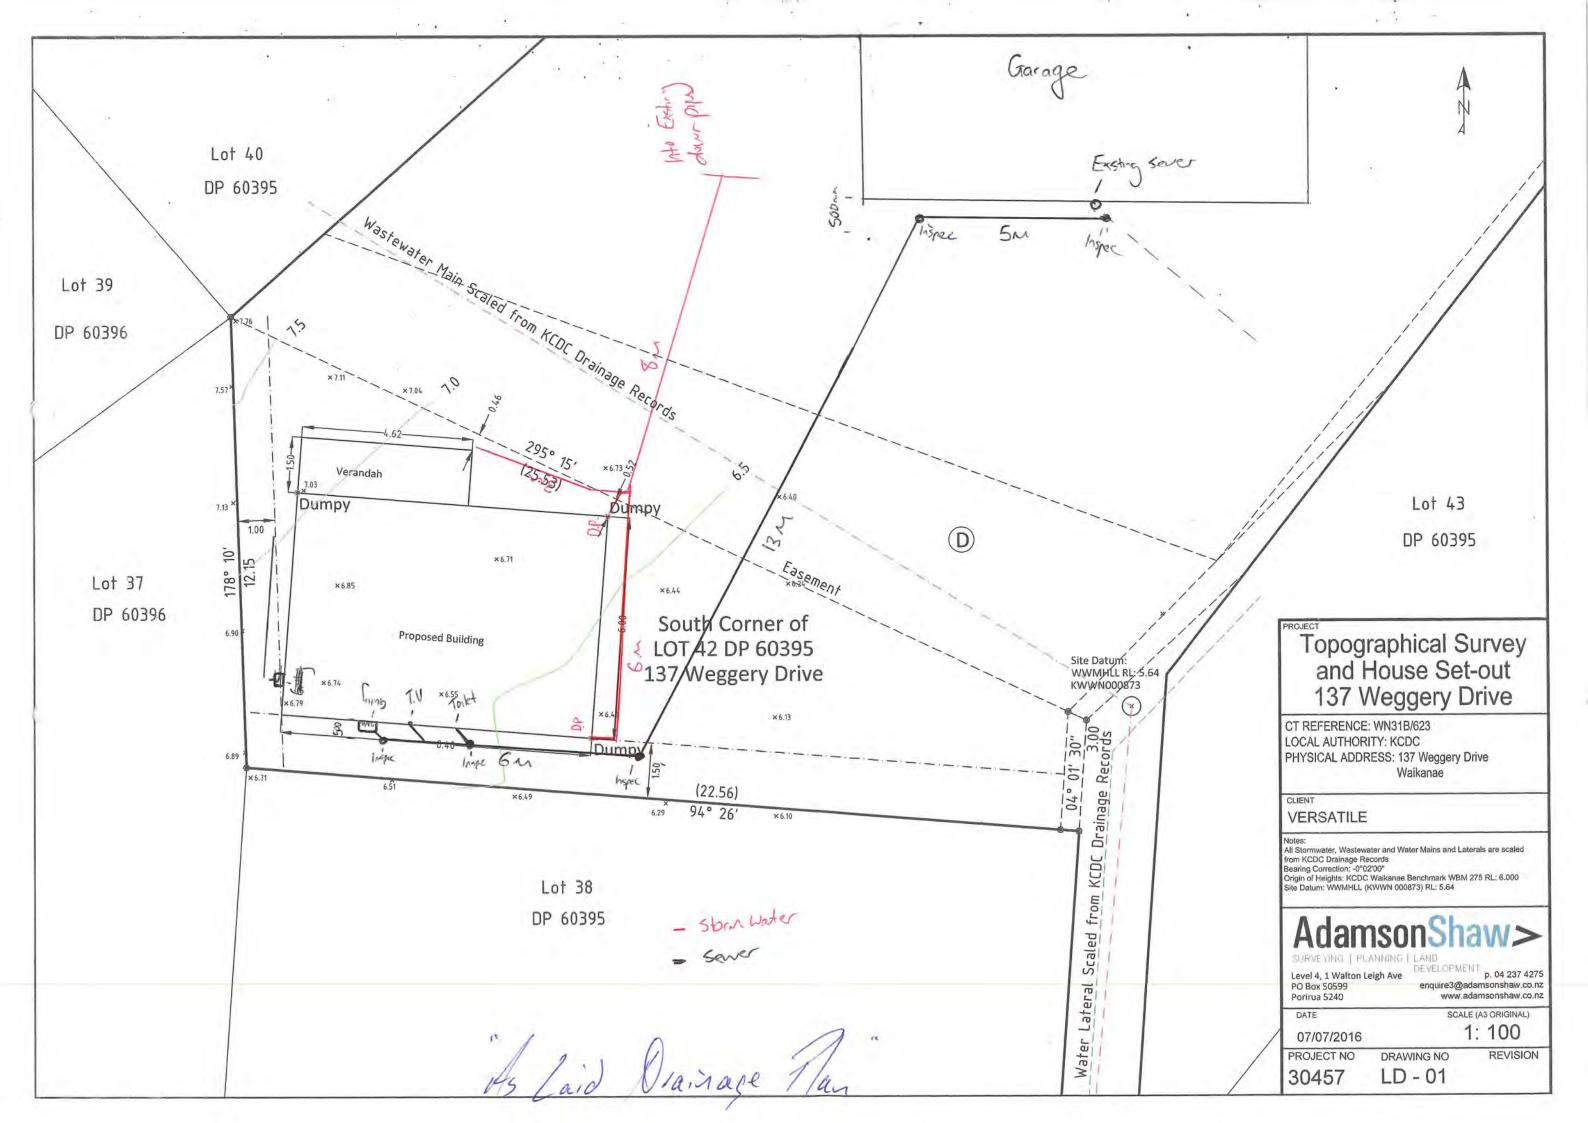



Versatile Buildings PO Box 54060 Mana 5247

24 August 2016

Dear Building Consent Applicant / Building Owner

Approval of Building Consent: 160621

Location:

137 Weggery Drive, Waikanae Beach

Legal Description: LOT 42 DP 60395 -SUBJ TO & INT IN VARIOUS EASEMENTS-

Description:

New two bedroom sleepout.

I am pleased to inform you that the above building consent application has been approved. The building consent documents have been issued and are enclosed.

Before starting any work please read ALL the building consent documents carefully and in full so that you as the owner understand the conditions under which the consent has been issued.

As the owner you are also responsible for the following:

- ensuring that building work starts within 12 months of the approval of the building consent and that work progresses at a reasonable pace.
- ensuring that all required inspections are completed and that a Code Compliance Certificate is obtained once the work has been completed – please be aware that before a Code Compliance Certificate is issued, the building work must comply with the Building Act 2004 and the Building Code as at the date of Consent.
- that no work with noisy equipment is to be carried out before 7.30 a.m. or after 6 p.m. Monday to Saturday. During the week there may be workers on site from 6.30 a.m. quietly preparing for work. Work with noisy equipment is not permitted on Sundays and public holidays.
- ensuring that no damage occurs to public property, for example footpaths or retaining structures. Should damage occur you will be required to pay for any repairs.
- ensuring that if you wish to make any changes to the approved building consent, then an amendment to the building consent will need to be lodged with us.

If you have any questions regarding your building consent or your responsibilities, please contact Kapiti Coast District Council on (04) 296 4700.

### Building Consent

### 160621

### Section 51, Building Act 2004

### The building

Street address of building:

137 Weggery Drive, Waikanae Beach

Legal description of land where building is located: LOT 42 DP 60395 -SUBJ TO & INT IN

VARIOUS EASEMENTS-

Valuation number:

1492059830

Building name:

Location of building within site/block number:

Refer site plan

Level/unit number:

#### The owner

Name of owner:

A Jenkins, S Enoka & J Wadsworth

Contact person:

Judith Wadsworth

Mailing address:

137 Weggery Drive, Waikanae 5034

Street address/registered office:

Email address:

judewadsworth2004@yahoo.co.nz

Website:

Phone numbers:

Landline:

Mobile:

027 087 7415

After hours:

027 555 5604

Fax number:

First point of contact for communications with the council/building consent authority:

Full Name: Versatile Buildings

Mailing Address: PO Box 54060, Mana 5247

Phones:: 027 482 7029: 04 233 9528

Fax: 04 233 9827

Email: craigs@versatile-wgn.co.nz

### **Building work**

The following building work is authorised by this building consent:

New two bedroom sleepout.

Sleepout

This building consent is issued under section 51 of the Building Act 2004. This building consent does not relieve the owner of the building (or proposed building) of any duty or responsibility under any other Act relating to or affecting the building (or proposed building). This building consent also does not permit the construction, alteration, demolition, or removal of the building (or proposed building) if that construction, alteration, demolition, or removal would be in breach of any other Act.

### **Build conditions**

### Compliance schedule

A compliance schedule is not required for the building.

### **Attachments**

Copies of the following documents are attached to this building consent:

- Building Consent Addendum
- List of required inspections
- Plans and specifications

On behalf of: KAPITI COAST DISTRICT COUNCIL

Date: 24/08/16

# Memorandum from licensed building practitioner: Record of building work

Section 88, Building Act 2004

Please fill in the form as fully and correctly as possible.

If there is insufficient room on the form for requested details, please continue on another sheet and attach the additional sheet(s) to this form.

ANSBAILDING .				
Street address:	137 Wegg	ery Drive	<u> </u>	. <u> </u>
Suburb:	137 Wegg Waikawa Waikawa	e Beac	<u> </u>	·
Town/City:	Waikana	.e	Postcode:	
THERROUSET				
Building consent num	<u> </u>	•		
THE OWNER (S)				
Name(s):	Versadil	le We	lington.	
Mailing address:				
Suburb:		PO Box/Pri	vate Bag:	
Town/City:			Postcode:	
Phone number:		Email addr	988:	

RECORD OF WORKTHAT IS RESTRICTED BUILDING WORK PRIMARY STRUCTURE Carried out or Work that is restricted Description of restricted building work supervised building work Tick @ whether you carried out the restricted building work or supervised If necessary, describe the restricted building work. Tick 🕜 someone else carrying out the restricted huilding work. Carried out Foundations and subfloor framing Supervised Carried out Walls Supervised Carried out Roof Supervised Carried out Columns and Supervised beams Fixed board to specs of as per braing plan Carried out **Bracing** Supervised Carried out Other Supervised

Name and contact details of the licensed building prestricted building work.	actitioner who is licensed to carry out or supervise
Name: Harry Druper	LBP number: <i>BP120031</i>
Class(es) licensed in: Carpentr	y
	· .
Plumbers, Gasfitters and Drainlayers registration nur	nber (if applicable):
Mailing address (if different from below):	a Kantudy ST
Street address/Registered office:	V
Suburb: Trentham	Town/City: Upper Huff
PO Box/Private Bag	Postcode: 50/8
Phone number:	Mobile: 02/920276
After hours:	Fax:
Email address: Contracts@apco.co.n	ZWebsite:
DECLARATION.	
Harry Druper	arried out or supervised the restricted building
work recorded on this form.	
Signature:	
Date: 29 1	1/ Dolls

# 19 19 19 19 19 19 19 19 19 19 19 19 19	ĝ,			
Wall cladding or wall cladding system	Ø	VERSPTILE C	·ladding	Carried out Supervised
				TO THE PROPERTY OF THE PROPERT
Waterproofing				Carried out
	 			Supervised
		-		
		EXPLANATION OF THE PROPERTY OF	AND MAKEN THE PROPERTY OF THE	
Other			THE STATE OF THE S	Carried out
				Supervised
		A. A. Maria and Control of the Contr		
SSUEDEN				
Name and contact detai	ils of th	e licensed building practitioner w	ho is licensed to carry out or supervise restric	ted building work.
Vame: Licharo Rym. LBP number: BP 128362				
Class(es) licensed in: Carpertry				
Plumbers, Gasfitters and Drainlayers registration number (if applicable):				
Mailing address (if a	lifferent	t from below):		
Street address/Re	gister	ed office: 22 Bull	J-	
Suburb:	<u> </u>		Town/City: well wanton	
PO Box/Private Ba	ıg:		Postcode: 2058	
Phone number:	,.		Mobile: 2074578738	
After hours:	<del>)</del>	578738	Fax:	akaansaa oo aa ahaanaha saka oo aa
Email address:	hor	dryn 1972 & Gwar	Website:	
REAL IS TELL	ver y	Productivam of Dalkovartonia		
DECLARATION  1 Lochaeo L	١٩٥٨	carried	out or supervised the restricted bui	lding
work recorded on	1	///	out of supervised the restricted but	1977 8
Signature:	J.	Yer -	Date: 10-12-2016	•

PRIMARY STRUCT	01911		
Roof	Ø	Asperglan,	Carried out Supervised
Columns and beams	0		Carried out Supervised
Bracing	<b>O</b>	Asper Bracin, Plan	Carried out Supervised
Other	9		Carried out Supervised
EXTERNAL MOIST	UNE	MANAGEMENT SYSTEMS	33 E
Damp proofing	0		Carried out Supervised
Roof cladding or roof cladding system	0	De Glon	Carried out Supervised
Ventilation system (for example, subfloor or cavity)	0	Caste	Carried out Supervised

Client Name:	Jude Vadsworth
Reference / Job #:	ICP (if known):
Address of work:	137 Weggery Prive
Suburb:	Waihanse Beach Town/City: Waikange
Description of gasfitti	ng work: (If different gasfitting work was done by different people, state who did what gasfitting.)
Pipework & Feed For a	from L.P.G bottles to VT 20 Kinnai Fufinnity and hob in the future.
Gas supply pressure	2.75 kPa Risk classification (tick one) Low-Risk General High-risk
Gas type (tick one)	□ Natural gas □ LPG □ Biogas □ Other (specify)
The work has been do	one in accordance with a certified design: Yes No
Copy of certified des	ign attached (or provide reference)
The work relies on m	anufacturer's instructions:
_	er's instructions attached (or provide reference)
The work has been do  Yes – AS/NZS 5601.1	sections 3 to 6  Yes – AS/NZS 5601.2 sections 3 to 9  No
Were any other stand	lards required for compliance?
Yes (specify)	☑ No
Parts of the gas instal	lation that are safe to connect to a gas supply?  Validity authenticated
Date(s) on which the different from date o	work was done (if feetifying gasfitting): 14/12/16
Name and registratio who carried out work	
	n satisfied that the work described in this certificate of the plant in the information on this certificate is correct.
Certifier name:	Registration
	Jonny Osborne number: 19525
Certifier Signature:	Date: 16/12/16
	work described in this Gas Safety Certificate, and the installation or part installation, is supply and is safe to use.
Name of person auth	
connection:	
Registration number	Date of completion or connection (if different from date of issuing GSC): 14/12/16







Building Code Clause(s).....B1.....

## PRODUCER STATEMENT — PS4 — CONSTRUCTION REVIEW (Guidance notes on the use of this form are printed on page 2)

ISSUED BY:New	Zealand Environment	al Technologies Limited. (Construction Review Fim)	*********		
TO: Versatile Hom	es and Buildings Wel	lington (Owner/D eveloper)			
TO BE SUPPLIED TO:Ka	apiti Coast District Co	uncil(Building Consent Authority)	*********		é vala por late
IN RESPECT OF:	Foundation	inspection(Description of Building Work)		iene.	
AT:137 Weggery Dri	ve, Waikanae	(Address)	33.70		
NZETh (Construction Review Firm) To provide ☐ CM1 ☐ CM2 ☑ C		Versatile Homes			
or other				#10 #10 Fet 100 fee 546 646 0	services
in respect of clause(s)		(Extent of Engagement)			
in documents relating to E					
Consent Amendment(s) No					
course of the works. We have					
Authorised instructions / va	ariations(s) No	Nil	02100000000		. (copies attached)
or by the attached Schedule	have been issued	d during the course of the	works.		
On by the basis of this and on behalf of the firm only of the building works hand Building Consent Amer I also believe on reasonable competency to do so.	undertaking this Connave been completed adments identified about	struction Review, I belied in accordance with the ove, with respect to Clau	relevant	asonable groun requirements of B1	ds that □All ☒ Part the Building Consent of the Building Code.
I,Stuart Dean Clark	truction Review Professional	am:		CPEng No5	8384
I am a Member of : XIPEN	Z □NZIA and hold the	e following qualifications	:Bl	E (Hons) MEng S	6c
The Construction Review Fi than \$500,000*. The Construction Review Fi			y of Profe	ssionalIndemnity	Insurance no less
SIGNED BY Stuart Dea	an Clark	ON BEHALF OFN	ew Zealan	d Environmental	Technologies Ltd
Date:29 November 2 Note: This statement shall only be Design Firm only. The total maxim Consent Authority in relation to thi \$500,000*.	relied upon by the Buildir um amount of damages p	ng Consent Authority named a payable arising from this state	ment and al	I other statements p	rovided to the Building
This form is to accompany I Certificate.					a Code Compliance
PRODUCER STATEMENT PS4	THIS FORM AND ITS	DUPLING ARE COPYRIGHT TO ACT	ENZ, IPENZ AN	ID NZIA	October 2013

Page 1 of 2

Signature:

Test results of 4 penetrometer soundings identify the soil strength (KPa) at the base of the foundation trench. All readings came up firm directly at the base. Soil strength was there for determined suitable for continuation of construction. Foundation depths were also in accordance with foundation specifications.



### **Electrical Certificate of Compliance**

for a low voltage installation if prescribed electrical work has been done on any part of it and the prescribed electrical work involved placing, replacing, or repositioning conductors or fittings attached to conductors. No. 4021119

No. of attachments

To be completed whether or not an Inspection is required.

10.	CUSTOMER INFORMATION - PLEASE PRINT CLEARLY
ons 20	Name of customer Versatile Ltd Phone:
egulatic	Address of installation 137 Weggery drive Warkowae
ety) R	Postal address of customer (if not as above)
es of the Electricity (Safety) Regulations 2010.	DECLARATION OF CONFORMITY (Please tick (/) appropriate boxes)  In accordance with Regulation 58 of the Electricity (Safety) Regulations 2010, the design of the installation or part of the installation to which this certificate applies  (a) complies with either Part 2 of AS/NZS 3000:2007 or Part 1 of AS/NZS3000:2007 and Regulation 59 and  (b) the supply system of the installation or part of the installation to which this certificate applies is 230V/400 V MEN or attached other system
rpos	WORK DETAILS
10-156, Wellington. Freephone 0800 66 1000) for the purposes	No. of lighting outlets  No. of ranges  No. of socket outlets  No. of water heaters  No. of water heaters  No. of water heaters  No. of water heaters
1000)	Was any installation work carried out by the homeowner?  Yes  No  MEN Switchboard closest to point of supply  Electric lines
99 00	Description of work carried out (If necessary attach any pages with work done)
ne 08	meler board to Main Switch board, wine fit
ohdaa	to loven sleep out, 1x Fan
n. Fre	
lingto	
6, Wel	CERTIFICATION OF WORK (Please tick (/) appropriate boxes)
10-15	I certify that the completed installation or part of the installation to which this certificate applithenticated  That been installed in accordance with the design detailed in the Declaration of Conformity section above
) Box	has had tests which are required by the Electricity (Safety) Regulations 2010 satisfactorily completed
rd (PO	has an earthing system that is correctly rated
н Воа	contains fittings which are safe to connect to a power supply
ratior	is safe to connect to a power supply  Signature:
egistı	Name Registration No. 17701670
ers R	Davided Wall Feel
Work	Company Just Electric Contact Ph No. 077,5600378
Electrical Workers Registration	Signature Date 2/12/16
Elec	INSPECTION DETAILS Electrical work requiring inspection by a registered electrical inspector
This form is approved by the	Mains work (mains, MEN switchboards closest to the point of supply, or main earthing systems)  Attached with Part 1 of AS/NZS 3000:2007
pavo	I certify that the items identified above are electrically safe and that the inspection has been carried out in accordance with the Electricity (Safety) Regulations 2010.
appr	Name Registration No.
orm is	Signature Date
This fo	Contact Ph No.

CUSTOMER COPY - THIS IS AN IMPORTANT DOCUMENT AND SHOULD BE RETAINED





FORM OF PRODUCER STATEMENT PS3 – CONST At project completion, this form shall be completed by the building	TRUCTION ng contractor and supplied to the Engineer.
ISSUED BY: le sa 4/e Clones (Building Contractor)	1 Du/d.195
TO: (Owner/Principal)	5,001/h
IN RESPECT OF: Sed room (Description of Contract Works)	Deepoul
AT: (Address) T/A: (Ap. 7): (as. 8) (CBL	JILDING CONSENT No: 16064
(Territorial Authority / Building Consent Authority)  The above Building Contractor has contracted to the	above Owner/Principal to carry out and
complete certain building works in accordance with	the contract, titled
(Title of building contract)	("the contract")
11.11	a duly authorised representative of the
above building contractor, believe on reasonable gro has carried out and completed	ounds that the above building contractor
□All □Part only as specified in the at	tached particulars
of the building works in accordance with the contract	t.
(Signature of Authorised Agent on behalf of the Building Contra	actor)
(Date)	
20-12-16	
90 Box 54 060 /1	Mara Dellington.
This producer statement is	ney have carried out the building work in nents) that are part of the contract / building
of Inde - hege	and checked by suitably qualified trades-
to copies (x4) need	e T/A's building consent conditions, to confirm have in fact been built according to the ents to the T/A for it to release the Code
20 ( to 10 /0 coursel for	Scott Developments Limited Trading as Versatile Homes & Buildings Welli
7	18 Ulric St, Plimmerton, Wellington, 5247 PO Box 54060, Mana, 5247
Ple of Comphance	Phone: 04 233 9528 Fax: 04 233 9827
share cheers 1)	Email: wellington@versatile.co.nz www.versatile.co.nz
1130	

Trading as Versatile Homes & Buildings Wellington 18 Ulric St, Plimmerton, Wellington, 5247 PO Box 54060, Mana, 5247 Phone: 04 233 9528 Fax: 04 233 9827 Email: wellington@versatile.co.nz www.versatile.co.nz

## PRODUCER STATEMENT PIPED SERVICES AND PLUMBING STACKS



#### Construction Review

Signature:

Send or deliver this form to: Kapiti Coast District Council, 175 Rimu Road, Paraparaumu 5032 Private Bag 60601, Paraparaumu 5254 For enquiries, phone 04 296 4700 (Toll Free: 0800 486 486)

TO BE COMPLETED BY THE INSTALLER Issued by: Registration number: 700 In respect of Piped Services installed in accordance with G12/AS1 as shown on the approved plans or as per the attached amended plan and Sanitary Plumbing Stacks installed in accordance with G13/AS1 or AS/NZS 3500.2.2 leagury. Drive Waikanae Installed at: **Building Consent No:** As a certified plumber, currently holding an annual practicing license, certify that I, or personnel under my control, have carried out the installation of the above system and I believe on reasonable grounds that the installation complies with the New Zealand Building Code. Both hot and cold systems have been pressure tested for a period of 15 minutes at a pressure of 1500 kPa. Signature: Name: Date: Address: Fax: Phone: Email: Mobile: Kāpiti Coast District Council Office Use Only Producer Statement author authenticated and current registration verified. Verification and Registration checked through public register on www.pgdb.co.nz. Date: Name:

### PRODUCER STATEMENT **PRIVATE SEWER DRAINS**



### **Construction Review**

Send or deliver this form to: Kapiti Coast District Council, 175 Rimu Road, Paraparaumu 5032 Private Bag 60601, Paraparaumu 5254

For enquiries, phone 04 296 4700 (Toll Free: 0800 486 486)

TO BE COMPLETED BY THE INSTALLED	
TO BE COMPLETED BY THE INSTALLER	
Issued by: Fraser Herclerson	
Registration number: 25666 / 0720	0
In respect of: Private Sewer Drains installed in accordance on the approved plans or as per the attached amended plan	with G13 AS2 or AS/NZS 3500 .2.2 as shown
Installed at: 137 Weggery Dine	Naikarae
Building Consent No: 6062	
As a certified drainlayer, currently holding an annual practic my control, have carried out the installation of the above sys the installation complies with the New Zealand Building Cod	tem and I believe on reasonable grounds that
Name: Craig Henderson Sign	ature: La Man
Address: 184 Moturaca Road Date	21-12-16
Phone: Fax	
Mobile: 0273377078 Em	il: FLPdINZ@ Gmal.con
Note: Fully dimensioned as built drain plan to be supplied Drains may be laid and backfilled without inspection with a min of 1.0 m head and the inspection at the I	provided that the drain is left under test
Producer Statement author authenticated and current registration	verified. Verification and Registration checked
through public register on www.pgdb.co.nz.	
Date: 16/1/7	
Name: Russen Brook	
Signature:	

Client Name:	Jude Vadsworth
Reference / Job #:	ICP (if known):
Address of work:	137 Weggery Drive
Suburb:	Waikanse Beach Town/City: Waikange
	ting work: (If different gasfitting work was done by different people, state who did what gasfitting.)
Pipework Feed for a	From L.P.G bottles to VT 20 Kinnai Fufinnity, hob in the Future.
Gas supply pressure	2.75 kPa Risk classification (tick one) Low-Risk General High-ris
Gas type (tick one)	□ Natural gas □ LPG □ Biogas □ Other (specify)
The work has been o	done in accordance with a certified design: Yes No
Copy of certified de	esign attached (or provide reference)
The work relies on n	nanufacturer's instructions:
Copy of manufactu	rer's instructions attached (or provide reference)
Yes – AS/NZS 5601. Were any other star	ndards required for compliance?
Yes (specify)	☑ No
Parts of the gas insta All Parts	allation that are safe to connect to a gas supply?  (specify)
Date(s) on which the different from date	e work was done (if of certifying gasfitting):
The state of the s	on number of anyone rk under supervision:
	im satisfied that the work described in this certificate of compliance has been done lawfu that the information on this certificate is correct.
Certifier name:	Jonny Osborne Registration number: 19525
Certifier Signature:	Date: 16/12/16
	e work described in this Gas Safety Certificate, and the installation or part installation, is gas supply and is safe to use.
	thorised to certify the Jonny Oslovne
Name of person aut connection:	TOVING COSTOPINO
AND THE RESIDENCE OF THE PARTY	

Gas Combined GSC-CoC — Version: June 2014

web sight checked Abros

### Addenda to Application

**Application** 

Approducti		~~~~~~~~~~~~~~~~~~~~~~~~~~~~~~~~~
Versatile Buildings	No.	160621
PO Box 54060		
Mana 5247		

**Project** 

Description	Other outbuildings eg shed, workshop, sleepout	
·	Being Stage 1 of an intended 1 Stage	
	New two bedroom sleepout.	
Intended Life	Indefinite, but not less than 50 years	
Intended Use	Sleepout	
Estimated Value	\$140,000	
Location	137 Weggery Drive, Waikanae Beach	
Legal Description	LOT 42 DP 60395 -SUBJ TO & INT IN VARIOUS	
,	EASEMENTS-	
Valuation No.	1492059830	

Designer:

Mitek PO Box 8387, Christchurch: 03 348 8691

Drainlayer:

same as plumber

Plumber:

Craig Henderson Plumbing & Drainage Ltd 154 Motuhara

Road, Plimmerton: 027 337 7078

Contractor:

Head Contractor - Versatile Homes PO Box 54060, Mana 5247

: 027 230 1261 / 04 233 9528

### **General Requirements**

- a) The Building Inspector is to be given 24 hours' notice before carrying out the following inspections:
- Site
- 2. Foundations
- 3. Pre-slab Plumbing
- 4. Pre-slab Building
- Drainage
- 6. Pre Wrap
- 7. Pre Clad
- 8. Weathertightness
- 9. Preline Building
- 10. Preline Plumbing
- 11. Postline
- 12. Final Inspection
- b) To arrange for any of the above required inspections by Building Control Team, please contact the Call Centre on (04) 296 4700 between the hours of 8am and 5pm.

### Addenda to Application 160621

- 1. LAPSE AND CANCELLATION OF BUILDING CONSENT. A building consent shall lapse and be of no effect if the building work concerned has not been commenced within 12 calendar months after the date of issue. Or within such further period as the territorial authority allows.
- 2. The inspection of all specific design components of the building is the responsibility of the Design Engineer who is also required to supply a written report to Council.
- 3. Note and comply with endorsements on approved plans.

2

- 4. Minimum heights of finished concrete slab-on-ground floors above adjoining finished ground level to comply with the current NZS3604.
- 5. Contractor to leave site clear of all demolition materials and in a tidy state.
- 6. Exterior cladding system to be previously completed and inspected by Council's Inspector prior to any subsequent prelining inspection/approval being granted for the fixing of internal linings.
- 7. This project contains elements specifically designed by an engineer. The Owner/Builder is required to ensure the Engineer inspects the work and provides KCDC with written evidence of the inspections.

I have read the foregoing addenda to application, and the Owner/Builder/Authorised Person hereby agrees to comply with them.

OWNER/BUILDER/ AUTHORISED PERSON

Date:

APPROVED BY PLANNING Janice Lee 10/08/2016 APPROVED
BY
PLUMBING
AND
DRAINAGE
Simon C
11/8/2016

00001



Walkgwas WELLERY DRIVE Kapiti Coast District Council Property Map

LOT 42

Dx 60395

1092 m

Jegre. 1.000

VH WIND 2006


### BC 160621

CAUTION
Plans have been digitally reproduced and may not be to scale.

APPROVED BY PLANNING Janice Lee 10/08/2016



Ensure that the sleepout is not sited over any easements

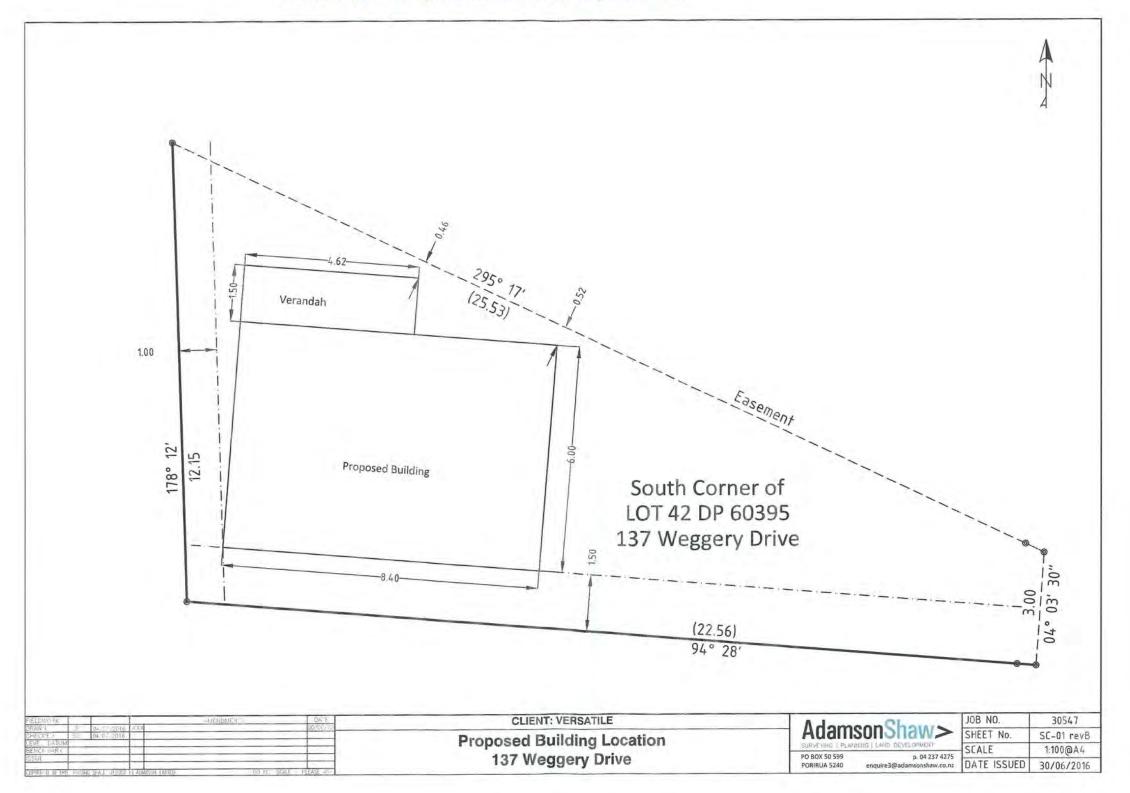

APPROVED BY PLANNING Janice Lee 10/08/2016 **BOUNDARY LINES** 

The Owner/Builder is responsible for clearly defining the site boundary lines and pegs. This may require a survey.


NOTE: established fences are not necessarily on the site boundary.

00003

RECEIVED

15 AUG 2016

BY:

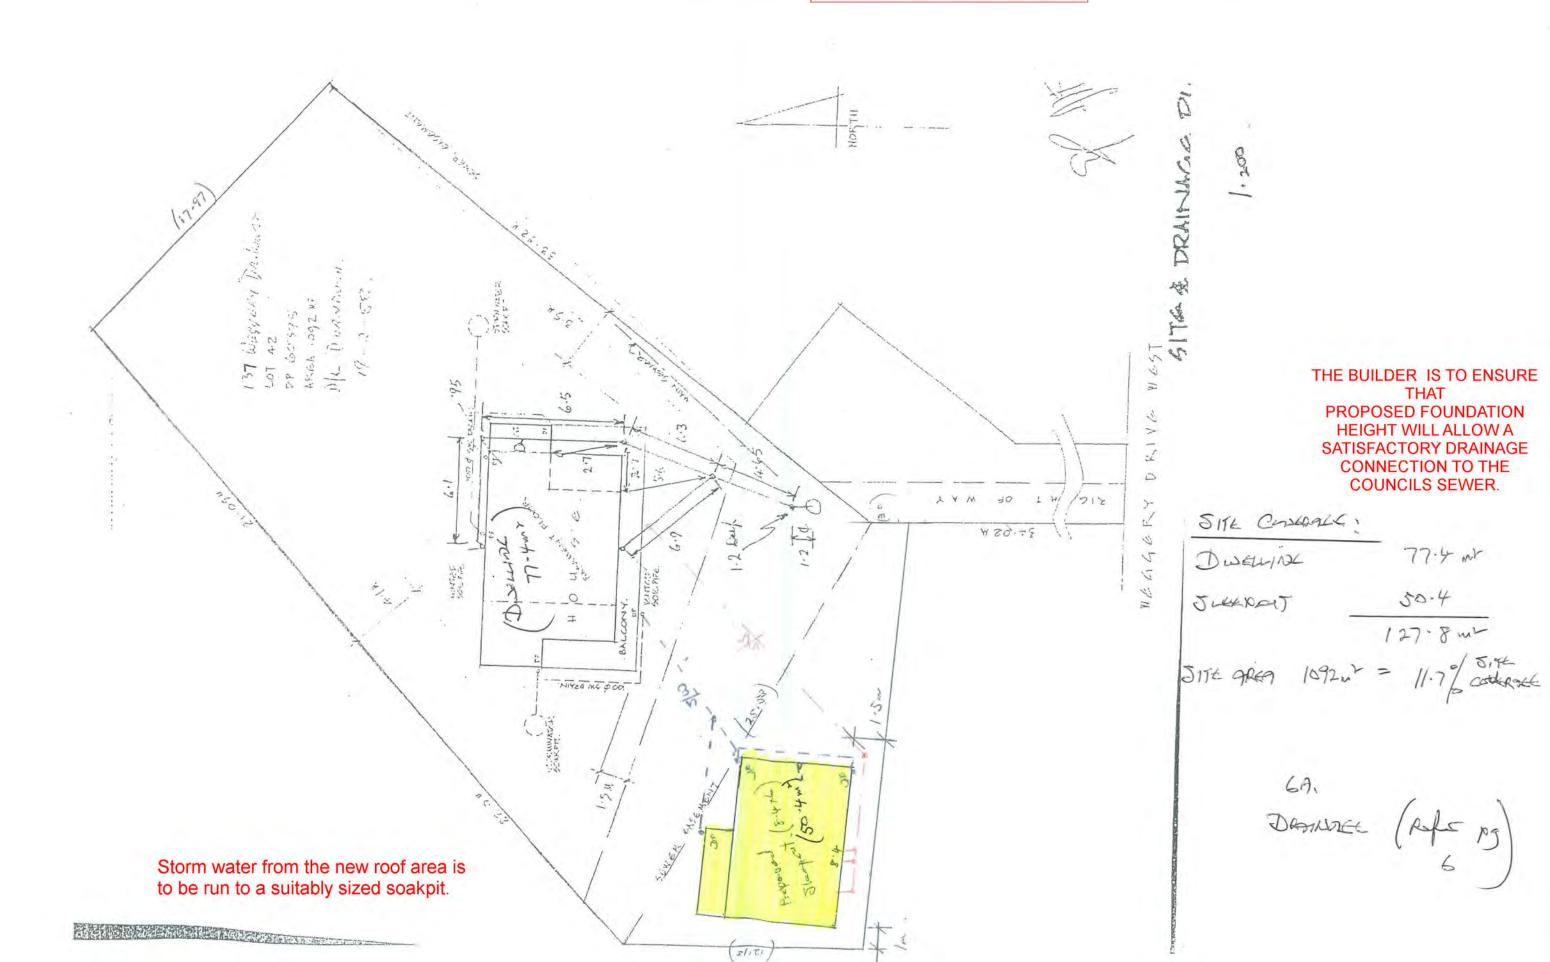

BY:

## CONTENTS

7	FLOOR PLAN ELEVATIONS FRAMING PLAN BRACING PLAN ELECTRICAL PLAN FOUNDATION PLAN + DAMINGLA A SITE PLAN CROSS SECTION
8	INTERNAL DETAILS
9	INTERNAL DETAILS
10	DETAILS 1
11	DETAILS 2
12	DETAILS 3
13	DETAILS 4
14	PURLIN & LINTEL FIXINGS
15	ROOF FRAMING LAYOUT
16	WINDOWS & DOORS SCHEDULE

## PROPOSED HOME FOR JUDE WADSWORTH 137 WEGGERY DRIVE WAIKANAE




©Spanbild New Zealand Limited. Copyright vests in, and at all times remains with, Spanbild New Zealand Limited and cannot be used or copied without Spanbild New Zealand Limited's prior written consent

THIS IS A C.A.D. DRAWING AND MUST NOT BE ALTERED BY MANUAL METHODS

• CONTRACTOR TO VERIFY ALL DIMENSIONS PRIOR TO STARTING

• ALL DIMENSIONS IN MM UNLESS STATED

• Spanbild New Zealand Limited. Copyright vests in, and at all times remains with, Spanbild New Zealand Limited and cannot be used or copied without Spanbild New Zealand Limited's prior written consent

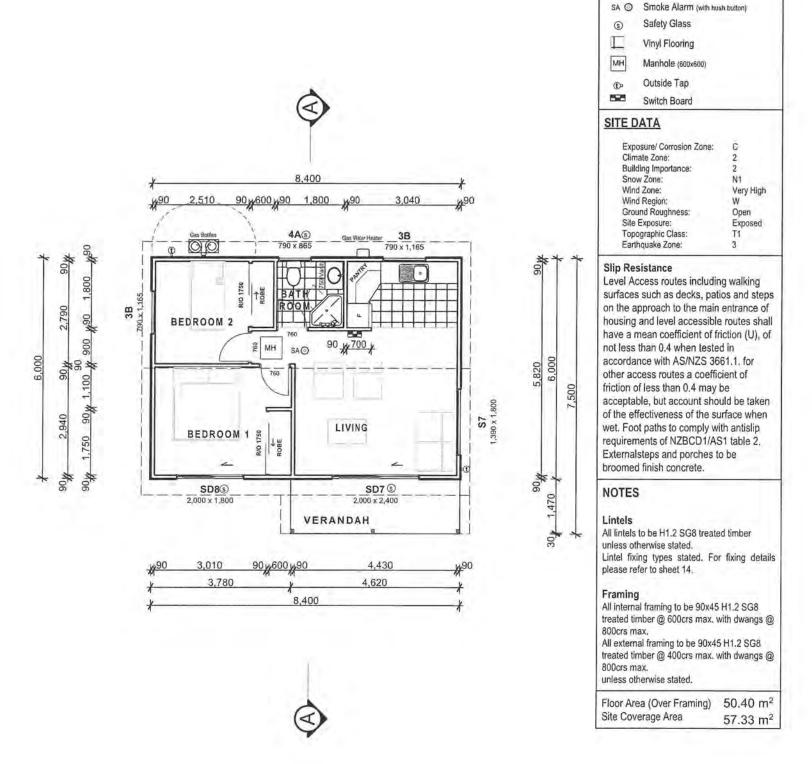

A certifying gas fitter is to provide a compliance certificate to council.

Hot water pipework from the HWC is to be insulated in accordance with NZBC H1.

VERSATILE®
HOMES & BUILDINGS

JUDE WADSWORTH,
137 WEGGERY DRIVE, WAIKANAE

DRAWING TITLE

FLOOR PLAN

LEGEND

SCALE: DATE: 28/07/2016 DRAWN: FILE: 160582

16 SHEET: 1

THIS IS A C.A.D. DRAWING AND MUST NOT BE ALTERED BY MANUAL METHODS CONTRACTOR TO VERIFY ALL DIMENSIONS PRIOR TO STARTING
 ALL DIMENSIONS IN MM UNLESS STATED
 O FRONT ELEVATION Colorsteel Corrugated Roofing Colorsteel Fascia & Gutter Superclad roll-formed Cladding on Cavity LEFT ELEVATION REAR ELEVATION RIGHT ELEVATION

©Spanbild New Zealand Limited. Copyright vests in, and at all times remains with, Spanbild New Zealand Limited and cannot be used or copied without Spanbild New Zealand Limited's prior written consent.

BUILDING ENVELOPE RISK MATRIX  Front Elevation					
Wind zone (per NZS 3604)	Very high risk	2			
Number of storeys	Low risk	0			
Roof/wall intersection design	Low	0			
Eaves width	High risk	2			
Envelope complexity	Low risk	0			
Deck design	Low	0			
Total Risk Score:		4			

BUILDING ENVELOPE RISK MATRIX  Left Elevation						
Wind zone (per NZS 3604)	Very high risk	2				
Number of storeys	Low risk	0				
Roof/wall intersection design	Low	0				
Eaves width	High risk	2				
Envelope complexity	Low risk	0				
Deck design	Low	0				
Total Risk Score:		4				

BUILDING ENVELOPE RISK MATRIX  Rear Elevation					
Wind zone (per NZS 3604)	Very high risk	2			
Number of storeys	Low risk	0			
Roof/wall intersection design	Low	0			
Eaves width	High risk	2			
Envelope complexity	Low risk	0			
Deck design	Low	0			
Total Risk Score:		4			

BUILDING ENVELOPE RISK MATRIX						
Right Elevation						
Risk Factor	Risk Severity I	Risk Score				
Wind zone (per NZS 3604)	Very high risk	2				
Number of storeys	Low risk	0				
Roof/wall intersection design	Low	0				
Eaves width	High risk	2				
Envelope complexity	Low risk	0				
Deck design	Low	0				
Total Risk Score:		4				



JUDE WADSWORTH,

137 WEGGERY DRIVE, WAIKANAE

DRAWING TITLE


ELEVATIONS


SCALE: DATE:
1:100 28/07/2016

DRAWN: FILE:
IC 160582

SHEET: OF:

### i) ROOF PLANE BRACE

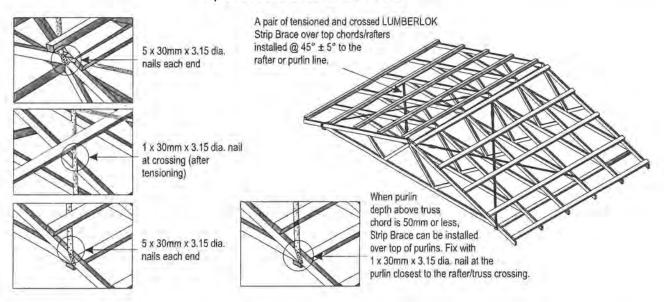

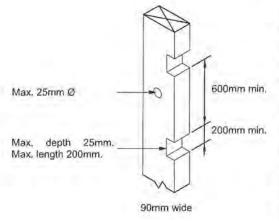

90mm x 45mm

### WALL STUD

Hole in the face and notches in the edge of a stud shall:

(a) Be placed anywhere over the face of the stud except that:

In brick veneer cladding, at least 50mm clear of the outside face of the stud supporting the veneer, to prevent damage from the fixings to services.

(b) Be not more in diameter or depth than: 90mm deep studs: 25mm. This may be increased to 35mm where not more than 3 consecutive studs are drilled or notched.

(c) Notches in studs to be spaced vertically not less than 600mm apart, irrespective of the edge containing

(d) 100mm min. offset between hole and notch.


### TOP PLATES:

The sizes of holes or notches shall comply with dimensions as per NZS3604 Section 8.7.5. Where the size of a hole or notch exceeds these dimensions the plates shall be strengthened by one of the following

(a) A 70mm x 45mm member x 600mm long nailed to the exterior side of the plate with 4/75x3.15 nails on each side of the hole or notch.

(b) A 70mm x 45mm eaves runner connected to all studs and no more than 250mm below the top plate. (c) A 70mm x 45mm blocking fitted between ceiling joists or trusses above cut top plates and the steel angle.

\*100mm min. offset between hole and notch.

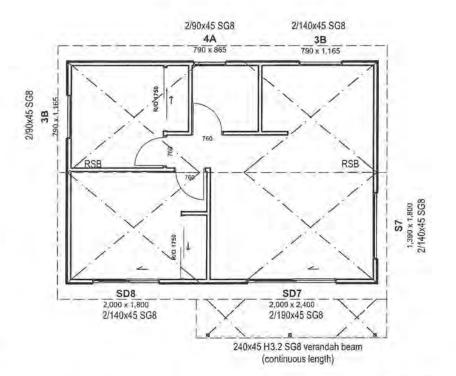

### LEGEND

- - Strip Brace

Roof Space Brace (RSB)

### NOTES

#### Lintels

All lintels to be H1.2 SG8 treated timber unless otherwise stated.

\*All lintels sized by Carters. Please refer to Carters Truss Lintel fixing types stated. For fixing details

please refer to sheet 14.

All internal framing to be 90x45 H1.2 SG8 treated timber @ 600crs max. with dwangs @ 800crs max.


All external framing to be 90x45 H1.2 SG8 treated timber @ 400crs max. with dwangs @ 800crs max.

unless otherwise stated


### Roof Bracing

Tensioned Strip Brace over top chords/purlins with 5/30x3.15 nails each end 2/30x3.15 nail each cross (top chord/purlin)

(A) Less than 2m long.

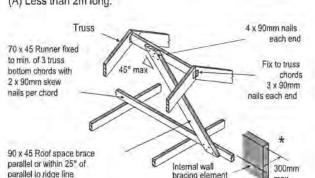

(C) Not directly under the ridge - less than 2m long.

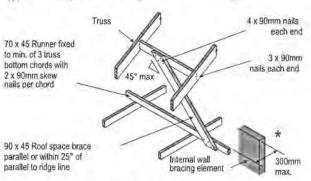

(D) Not directly under the ridge - more than 2m long.

VERSATILE **HOMES & BUILDINGS** 

Max. depth 25mm.

Max. length 200mm.

Max. 25mm Ø

PROPOSED SLEEPOUT FOR:

JUDE WADSWORTH, 137 WEGGERY DRIVE, WAIKANAE DRAWING TITLE

FRAMING PLAN

SCALE: DATE: 28/07/2016 DRAWN: FILE: 160582 IC


SHEET:

OF:

3

©Spanbild New Zealand Limited. Copyright vests in, and at all times remains with, Spanbild New Zealand Limited and cannot be used or copied without Spanbild New Zealand Limited's prior written consent

US AUG 2016 BY:

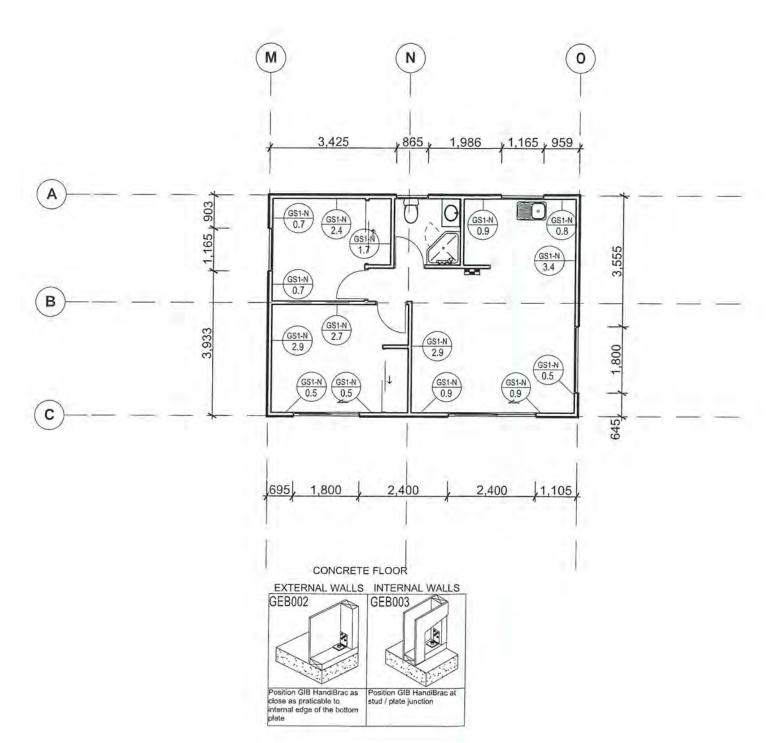

### Gib Notes

Moisture Content of timber framing must be 18% or less at time of lining. Gib linings are a finishing product and are not to walked on. Shoe marks are not acceptable under any circumstances.

### **Bracing Elements**

Note: All GIB elements are stated as minimums. Bracing elements MUST be MAXIMUM length on site. Refer to "Length of GIB EzyBrace Elements" a GIB bulletin in the supporting documents for fixing locations.

#### GS1-N

10mm GIB Standard Plasterboard to one side fixed Vertical or Horizontal.

### TOP PLATE JOINTING AS PER CLAUSE 8.7.3 NZS 3604:2011

### **Top Plate Connections**

The top plate of a wall that contains one or more wall bracing elements shall be jointed according to the rating of the highest-rated individual wall bracing elements as follows:

(a) Rating not exceeding 100 bracing units: A 3kN connection as shown or by an alternative fixing of 3kN capacity in tension or compression along the plate; (b) Rating exceeding 100 bracing units: A 6kN connection as shown or by an alternative fixing of 6kN capacity tension or compression along the plate.

### Top Plates in Line

Connection capacity LUMBERLOK Connector

3 kN Tylok 6T5 OR Strap Nail 6 kN Tylok 6T10 OR 2 x Strap Nails

### Top Plates at Right Angles

Connection capacity LUMBERLOK Connector

6 kN Tylok 6T10 OR 2 x Strap Nails

12 kN 2 x Sheet Brace Straps fixed with 6 x LUMBERLOK Product Nails 30mm x 3.15 dia. per end per strap (24 nails total)

#### 8.7.3.4

Each wall that contains one or more wall bracing elements shall be connected at the top plate level, either directly, or through a framing member in the line of the wall, to external walls at right angles to it.

Top plate fixings(s) of the capacity in tension or compression along the line of the wall bracing element are given as follows:

 For each wall containing wall bracing elements with a total bracing capacity of not more than 125 bracing units: to at least one such external wall by a fixing as shown in figure 8.16 of 6kN capacity;

 For each wall containing wall bracing elements with a total bracing capacity of not more than 250 bracing units: to at least 2 external walls by fixings as shown in figure 8.16 each of 6 kN capacity;

c) For each wall containing wall bracing elements with a total bracing capacity of more than 250 bracing units; to at least 2 external walls by fixings as shown in figure 8.16 each having a rating of not less than 2.4 kN per 100 bracing units.



PROPOSED SLEEPOUT FOR:

JUDE WADSWORTH, 137 WEGGERY DRIVE, WAIKANAE DRAWING TITLE

BRACING PLAN

SCALE: DATE: 1:100 2 DRAWN: FILE:

28/07/2016 160582 OF

0F:


SHEET:

THIS IS A C.A.D. DRAWING AND MUST NOT BE ALTERED BY MANUAL METHODS

CONTRACTOR TO VERIFY ALL DIMENSIONS PRIOR TO STARTING

©Spanbild New Zealand Limited. Copyright vests in, and at all times remains with, Spanbild New Zealand Limited and cannot be used or copied without Spanbild New Zealand Limited's prior written consent

Provide electrical certification after completion and prior to Code Compliance Certificate being issued

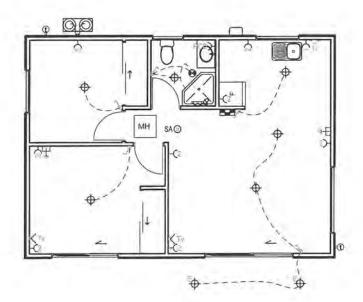

### LEGEND

- Downlight (CA135 rated)
- ❸ Heat/Fan/Light External Light
- Light Switch
- > Double Power Point
- > Single Power Point
- Tv > Tv Point
- → Data Point
- SAO Smoke Alarm (with hush button) RCD
- Switchboard
- Outside Tap Man Hole (600x600mm)

Note: Electrician to confirm with client on site positioning of all electrical outlets before work commences.



PROPOSED SLEEPOUT FOR: JUDE WADSWORTH, 137 WEGGERY DRIVE, WAIKANAE DRAWING TITLE

ELECTRICAL PLAN

SCALE: DATE: 28/07/2016 1:100 DRAWN:

SHEET:

OF:

5

IC 160582

©Spanbild New Zealand Limited. Copyright vests in, and at all times remains with, Spanbild New Zealand Limited and cannot be used or copied without Spanbild New Zealand Limited's prior written consent BULDER TO ENSURE THAT


PROPOSED FOUNDATION
HEIGHT WILL ALLOW A
SATISFACTORY DRAINAGE
CONNECTION TO THE
COUNCILS SEWER.



### **ENGINEERS DESIGN**

This project contains elements specifically designed by an engineer. The owner/builder is required to ensure the engineer inspects the work and provides KCDC with written evidence of the inspection.

A drainage inspection is required.

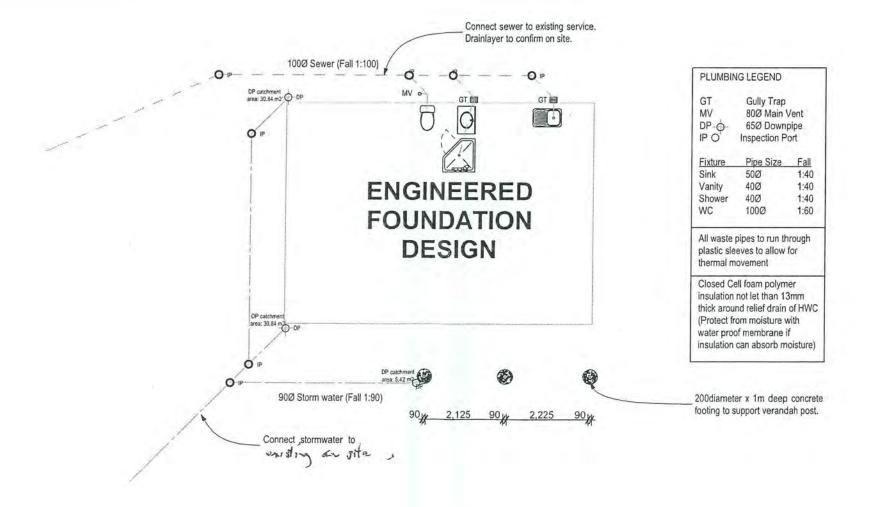

A CERTIFYING PLUMBER/DRAINLAYER TO FILL OUT ATTACHED PRODUCER STATEMENT FORMS AND RETURN TO COUNCIL .ALSO PROVIDE NEAT ASBUILT DRAINAGE PLAN SHOWING SEWER STORMWATER AND WATER.



PROPOSED SLEEPOUT FOR:

JUDE WADSWORTH, 137 WEGGERY DRIVE, WAIKANAE DRAWING TITLE

FOUNDATION PLAN


SCALE: DATE: 1:100 28/07/2016 DRAWN: FILE:

160582

OF:

SHEET:

©Spanbild New Zealand Limited. Copyright vests in, and at all times remains with, Spanbild New Zealand Limited and cannot be used or copied without Spanbild New Zealand Limited's prior written consent

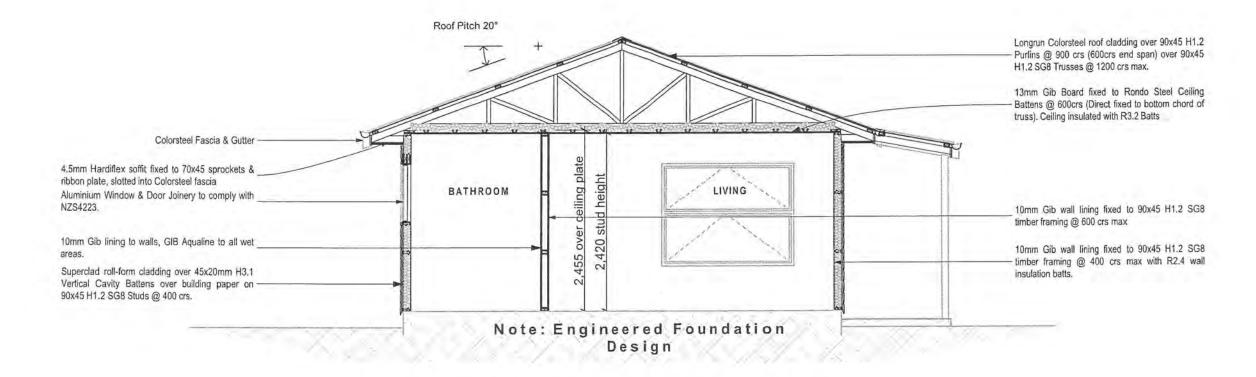





PROPOSED SLEEPOUT FOR: JUDE WADSWORTH, 137 WEGGERY DRIVE, WAIKANAE DRAWING TITLE


CROSS SECTION

SCALE: DATE: 28/07/2016 1:50 DRAWN: FILE: 160582

SHEET:

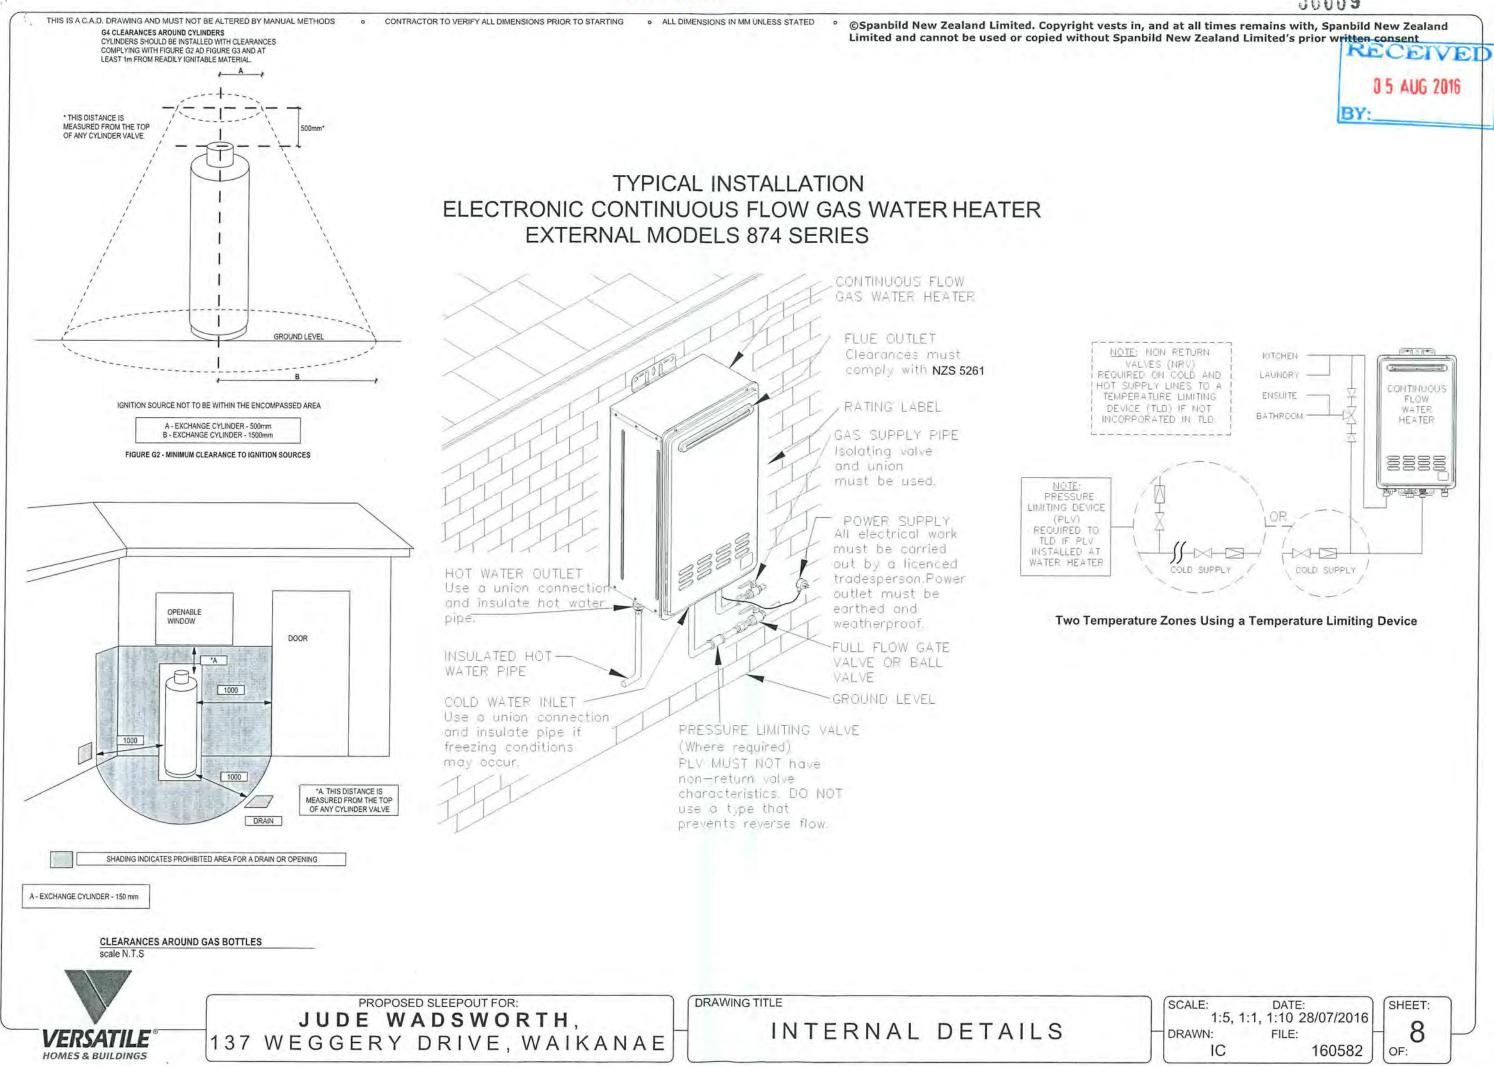

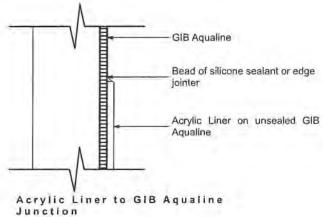

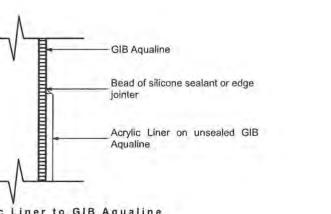

GIB Aqualine

Aqualine


Tap Body


Pipe Penertration Acrylic Liner

Note: Where impact noise from pipes is an issue, fix all pipes on resilient brackets.


Silicone Sealant

Acrylic liner over unsealed GIB

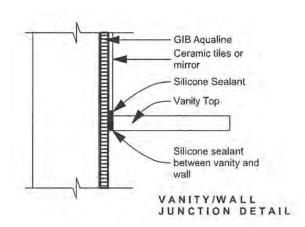


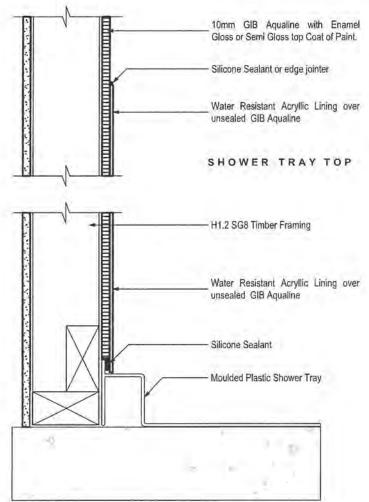



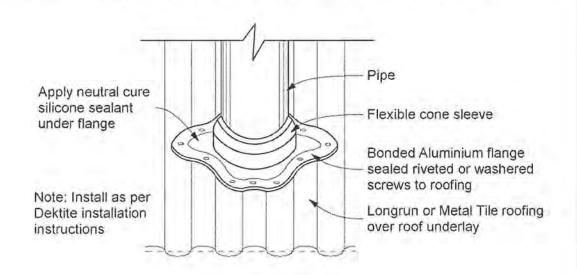

#### DEKTITE PIPE PENETRATION DETAIL

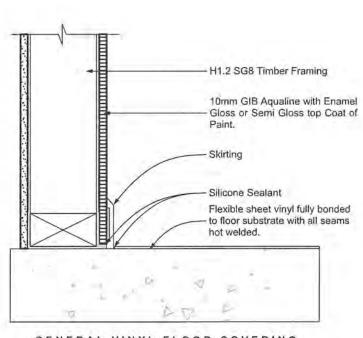

GENERAL VINYL FLOOR COVERING



PROPOSED SLEEPOUT FOR: JUDE WADSWORTH, 137 WEGGERY DRIVE, WAIKANAE DRAWING TITLE

INTERNAL DETAILS

SCALE: DATE: 1:5, 1:1, 1:10 28/07/2016 FILE: DRAWN: 160582

SHEET: OF:

THIS IS A C.A.D. DRAWING AND MUST NOT BE ALTERED BY MANUAL METHODS

CONTRACTOR TO VERIFY ALL DIMENSIONS PRIOR TO STARTING

· ALL DIMENSIONS IN MM UNLESS STATED

©Spanbild New Zealand Limited. Copyright vests in, and at all times remains with, Spanbild New Zealand CSpanblid New Zealand Limited. Copyright vests in, and at an emission control written consent Limited and cannot be used or copied without Spanbild New Zealand Limited's prior written consent

0 5 AUG 2016


BY:

475 Roof Pitch 20° 150x60mm Gutter Cross sectional area = 9000mm (complying with E1, Fig 15) Provide Blocking to Block Air flow 4.5mm hardies soffit lining on 70x45 into roofspace or Ribbon plate & sprockets skew nailed staple building to 140x45 fasica board wrap to ribbon plate. 70x45 Soffit Bearer fixed to framing Internal corner flashing to return under hardi soffit board, cover cladding by 50mm min Prepainted Superclad fixed over 45x20 H3.1 cavity battens over building wrap.


#### SUPERCLAD SOFFIT DETAIL Scale 1:10

DETAIL Scale 1:10

Note: Hard fill has a height limit Bottom Plate on DPC to extend over of 600mm in NZS3604, this means that if your hard fill goes Bottom plate fixing M12 x 140 higher SED foundation is Through bolt @ 900crs, fixed with required. galv 50x50x3mm washers, fix at least Superclad roll-form cladding over 50mm from edge of concrete. 45x20mm H3.1 Vertical Cavity Battens over Building Wrap on 90x45 H1.2 SG8 Studs @ 400 crs. PVC Vermin channel at base of cavity. Prepainted Superclad (A2) Base ENGINEERED FOUDNATION DESIGN **FOUNDATION** 

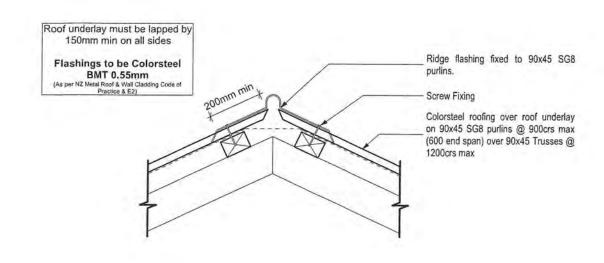

RIDGE DETAIL

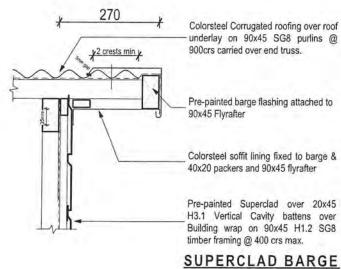

SUPERCLAD BARGE DETAIL Scale 1:10



PROPOSED SLEEPOUT FOR:

JUDE WADSWORTH, 137 WEGGERY DRIVE, WAIKANAE DRAWING TITLE


DETAILS 1

SCALE: DATE: 1:10 DRAWN:


IC

28/07/2016 FILE: 160582


SHEET: OF:

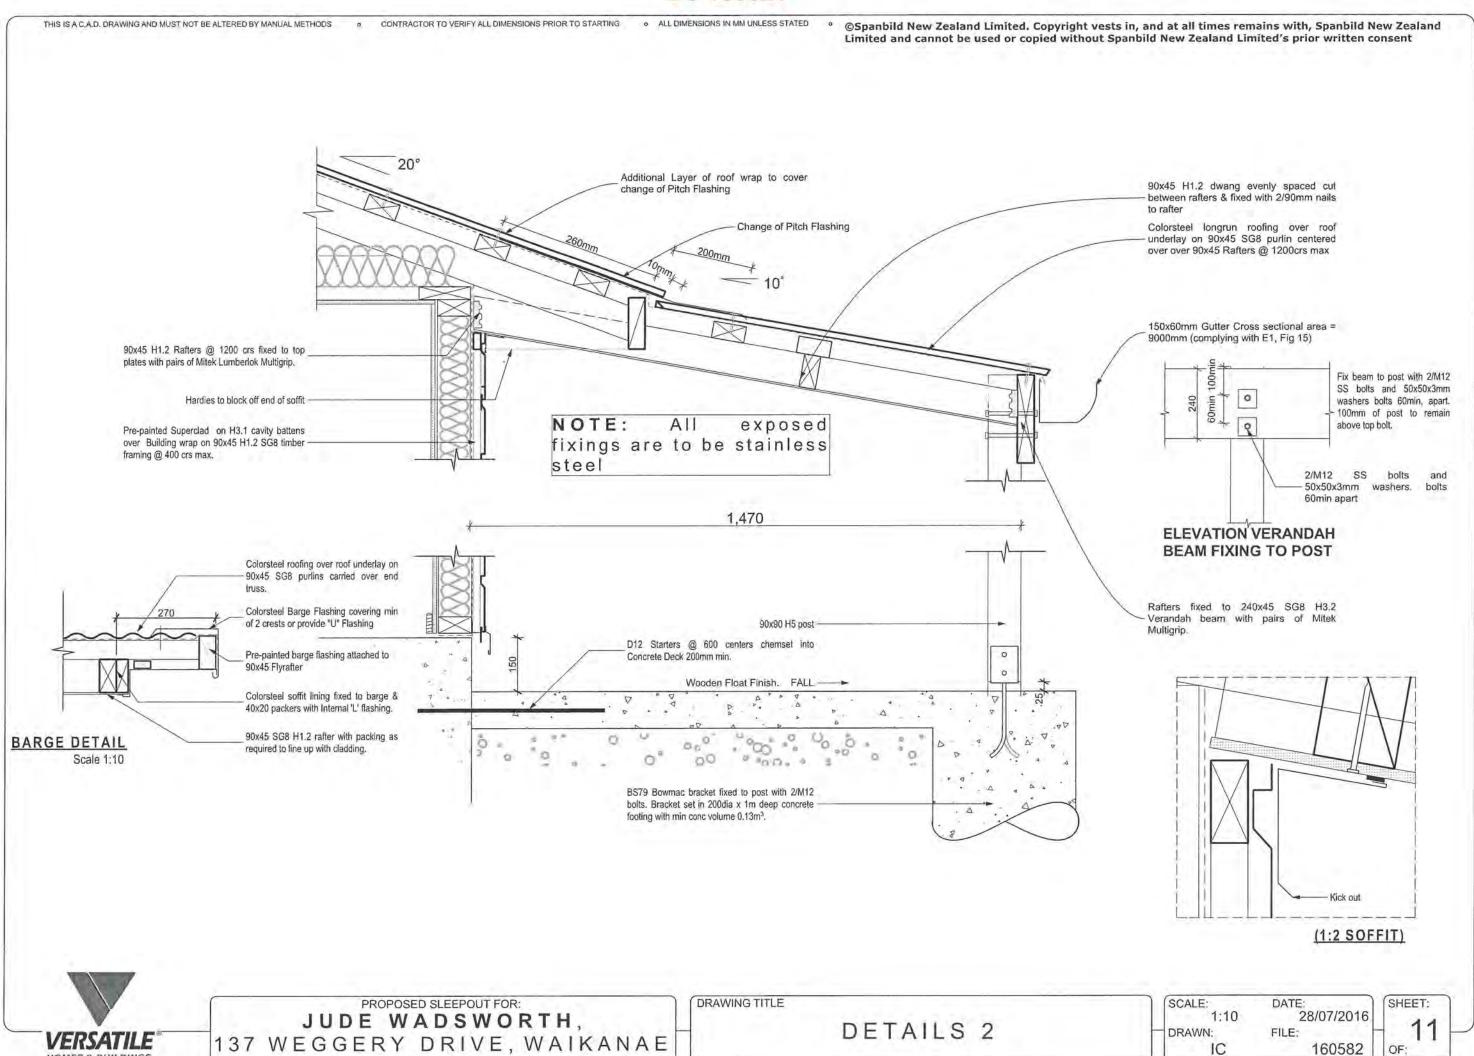


· ALL DIMENSIONS IN MM UNLESS STATED

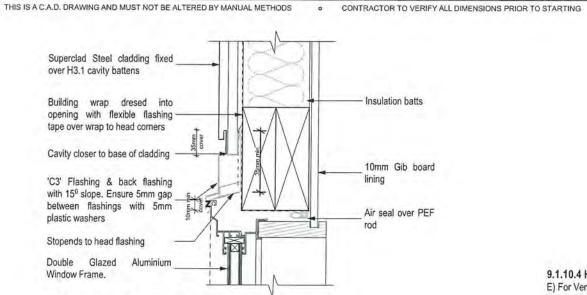

### ALUMINIUM WINDOW HEAD DETAIL Scale 1:5

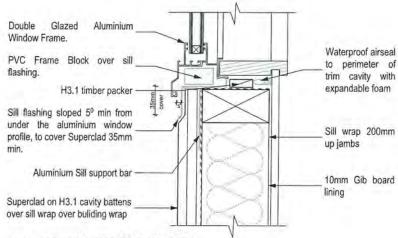


ALUMINIUM WINDOW SILL
DETAIL Scale 1:5

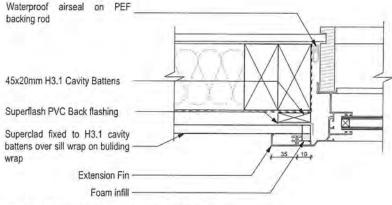



ALUMINIUM WINDOW JAMB
DETAIL Scale 1:5


9.1.10.4 Head flashings

E) For Very High and Extra high wind zones, have sealant installed between underside of head flashing and top edge of window head flange - Refer Figure 71 (C)

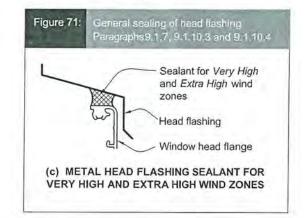

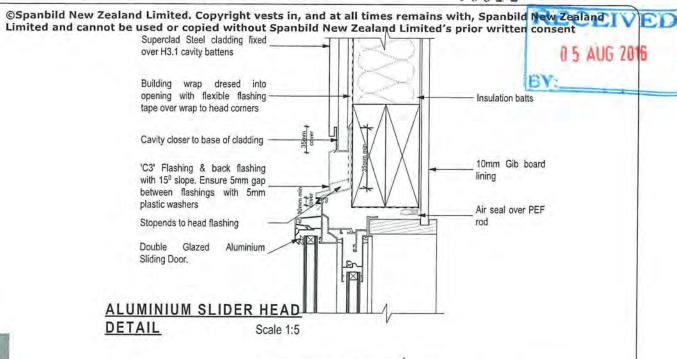

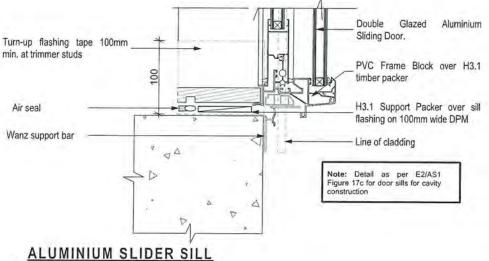

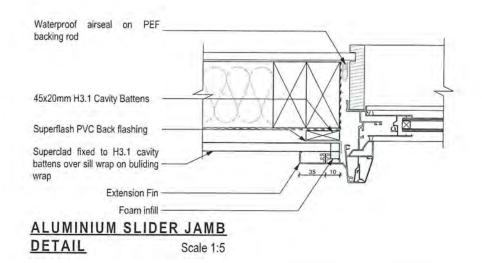

Scale 1:5



JUDE WADSWORTH,

137 WEGGERY DRIVE, WAIKANAE


DRAWING TITLE

DETAILS 3

DETAIL

SCALE: DATE: 28/07/2016
DRAWN: FILE: 1C 160582

SHEET:
12
OF:

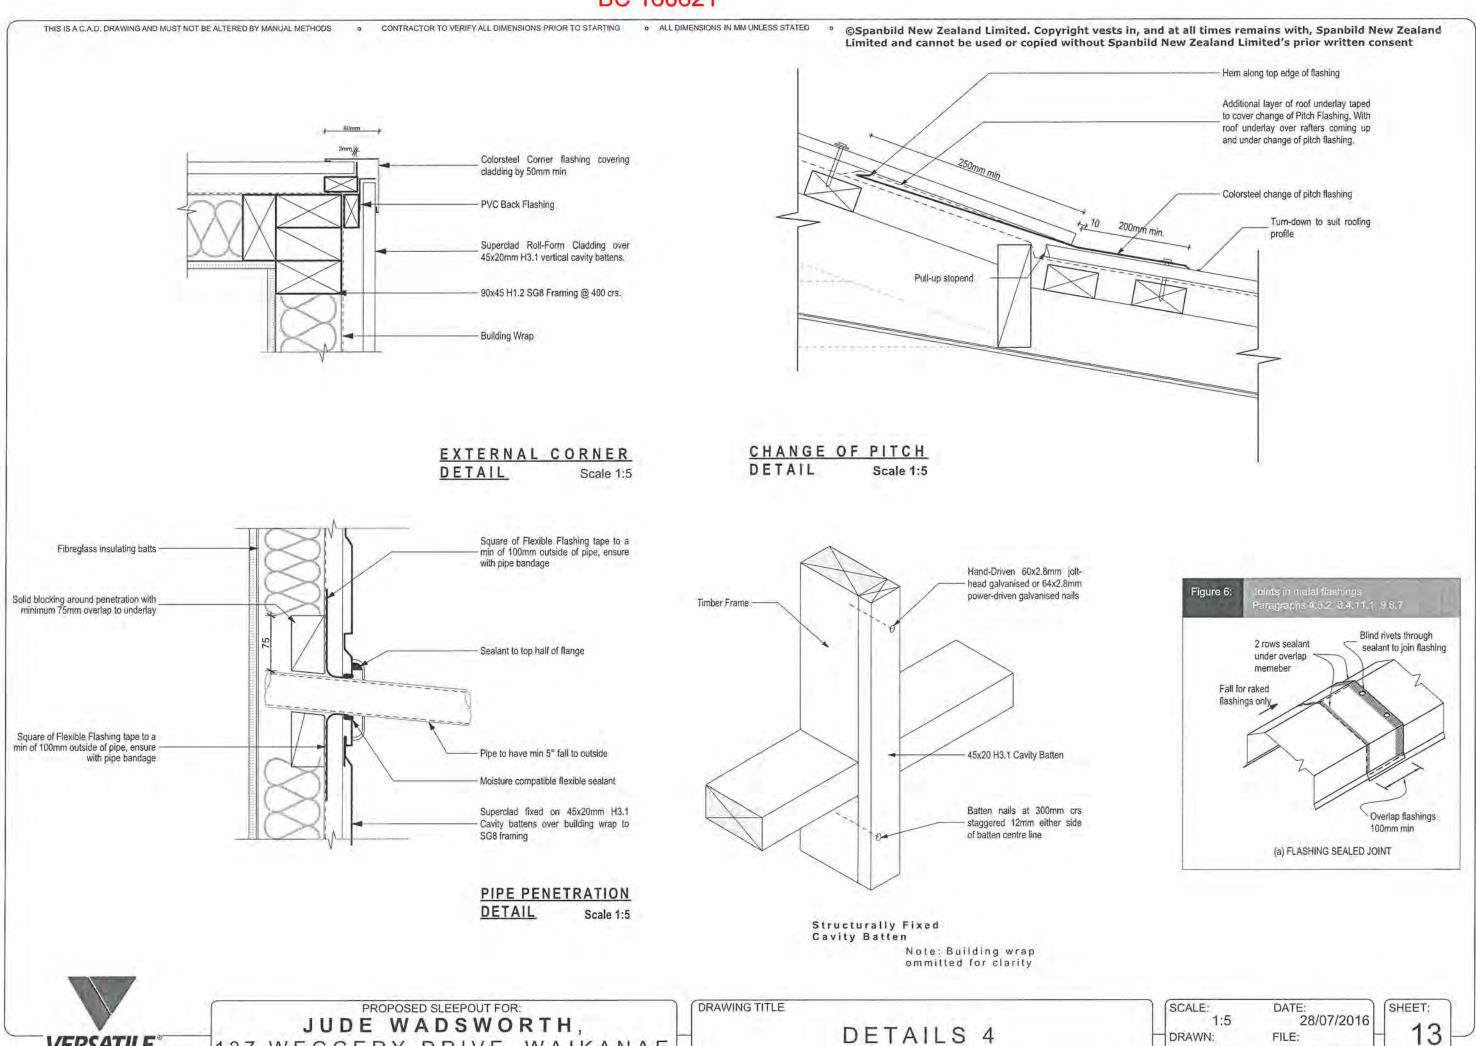

OF:

160582

IC

VERSATILE

137 WEGGERY DRIVE, WAIKANAE

RECEIVED

0 5 AUG 2016

· ALL DIMENSIONS IN MM UNLESS STATED


PURLIN FIXINGS:

(MiTek alternative solution to NZS3604:2011 Table 10.10)

ROOF WEIGHT	MAX. MAX.	The second of the Control of the Con	WIND ZONE				
KOOI WEIGHT	PURLIN SPAN (mm)	PURLIN CRS. (mm)	L	М	Н	VH	EH
HEAVY ROOF Tile Battens	900	370	Α	А	А	А	А
LIGHT ROOF	900	370	Α	А	В	С	С
Tile Battens	1200	370	Α	В	С	С	С
LIGHT GOOD	900	900	С	С	С	С	D
LIGHT ROOF Purlins	1200	900	С	С	С	(D)	D
	1200	1200	С	С	D	E	E

#### **FIXING TOLERANCES**

LUMBERLOK BLUE SCREW

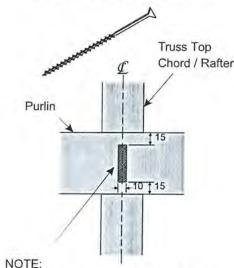

Locate fixings within the shaded area. Care to be taken to avoid over tightening of screws.

Purlin / Batten FIXING TYPE D 3.45kN 2 BLUE SCREWS 2 SKEW NAILS plus 2 WIRE DOGS

**FIXING TYPE** C, D or E OVER **PURLIN SPLICE** 

90 x 35mm block fixed to chord or rafter with 4 x 75mm nails

· TYPE C 1 SCREW to each purlin


· TYPE D & E

# (for purlin on edge)




#### 1 NAIL plus 1 SCREW to each purlin

#### All lintels require Lintels Fixings as per NZS3604:2011

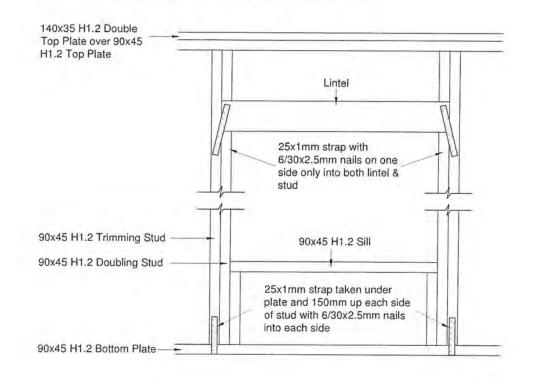

©Spanbild New Zealand Limited. Copyright vests in, and at all times remains with, Spanbild New Zealand Limited and cannot be used or copied without Spanbild New Zealand Limited's prior written consent

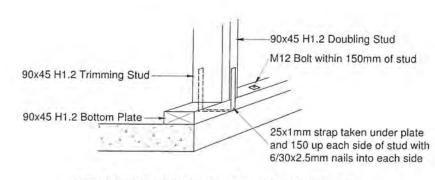

STUD TO BOTTOM PLATE FIXING DETAIL

#### NOTE:

- ★ All purlin and batten sizes are as per NZS 3604:2011.
- All fixings assume that the purlin and battens are installed on their flat over the top of the rafter or truss.
- The minimum fixing requirements apply to all purlin locations within the roof area.

  The LUMBERLOK BLUE SCREW where specified requires a minimum of 30mm penetration into rafter or truss i.e. it is suitable for rough sawn timber up to 50mm thick at 18% moisture content.

PROPOSED SLEEPOUT FOR:

JUDE WADSWORTH, 137 WEGGERY DRIVE, WAIKANAE DRAWING TITLE

PURLIN & LINTEL FIXINGS

SCALE: 1:1 DRAWN:

DATE: 28/07/2016 FILE:

160582


SHEET: 14 OF:

THIS IS A.C.A.D. DRAWING AND MUST NOT BE ALTERED BY MANUAL METHODS

CONTRACTOR TO VERIFY ALL DIMENSIONS PRIOR TO STARTING

. ALL DIMENSIONS IN MM UNLESS STATED

©Spanbild New Zealand Limited. Copyright vests in, and at all times remains with, Spanbild New Zealand Limited and cannot be used or copied without Spanbild New Zealand Limited's prior written consent

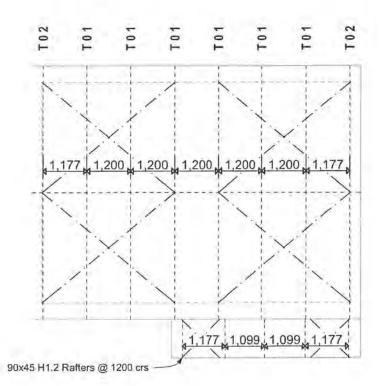

#### Span and Load Chart:

Live Load = Top Chord - 1.1kN concentrated load, 0.25kPa uniform load, Bottom Chord - 0.9kN concentrated load above 1200mm head height and 1.4kN load above 1200mm head height. Dead Load = 0.15 kPa (Top Chord). 0.20 kPa (Bottom Chord) trusses @ 1200crs with ceiling.

Wind: Roof = Cfig = -1.1

Purlin Spacing = 900 max

Truss Centres Wind Load 1200 Very High

> All top and bottom chords are to be H1.2 SG10 90x45 and webs to be min H1.2 SG8 70x45 Pinus Radidata

Treatment: Boron H1.2 Moisture Content: Dry

Roof Bracing:

Single row of tensioned Strip Brace over top chords/purlins. 5/ 30x3.15 nails each end 2/ 30x3.15 nail each cross (top chord/purlin)

Truss Fixing: 2xCPC40 per each end of truss



PROPOSED SLEEPOUT FOR:

JUDE WADSWORTH, 137 WEGGERY DRIVE, WAIKANAE DRAWING TITLE

ROOF FRAMING LAYOUT

SHEET: 15 OF:

SCALE: DATE: 28/07/2016 1:100 DRAWN: FILE: IC 160582

RECEIVED

BC 160621 THIS IS A C.A.D. DRAWING AND MUST NOT BE ALTERED BY MANUAL METHODS CONTRACTOR TO VERIFY ALL DIMENSIONS PRIOR TO STARTING ALL DIMENSIONS IN MM UNLESS STATED ©Spanbild New Zealand Limited. Copyright vests in, and at all times remains with, Spanbild New Zealand Limited and cannot be used or copied without Spanbild New Zealand Limited's prior written consent 2,000 2,000 3B 3B 4A **OPAQUE** Safety glass 2,400 1,800 1,183 1,183 883 883 2,000 S 999 S SD7 SD8 Safety glass Safety glass

2,000 **S7** 

Finish

Powdercoated aluminium

Reveal

H3.1 Paint finished grooved pinus radiata

Glazing

Clear Double glazed as per NZS4223

Frame

35mm Residential Suite



PROPOSED SLEEPOUT FOR: JUDE WADSWORTH, 137 WEGGERY DRIVE, WAIKANAE WINDOWS & DOORS SCHEDULE

DATE: 28/07/2016 SCALE: 1:50 DRAWN: FILE:

160582

IC

SHEET: 16 OF:

J0014



#### Form 2A

Memorandum from licensed building practitioner: Certificate of design work

Section	30C	or se	ection	45,	Building	Act	2004
The buil	dina						

Section 30C or section 45, E The building	Building Act 2004		
2 Bedroom self-contained un	it		
The owner			
Name: Jude Wadsworth			
Address: 137 Weggery Drive W	lajkanae		
Telephone number: Craig Sn	nith Versatile Homes and Buildi	ngs 0274827029	
Email address: Craigs@vers	atile-wgn.co.nz		
	that is restricted building w		
I carried out or supervised the	following design work that is re	stricted building work:	19.6
Design work that is restricted building work	Description	Carried out/ supervised	Reference to plans and specifications
Primary structure			
Foundations and (X) wind zone determination	Investigation and design of foundations and wind zone determination for self- contained unit	(X) Carried out	Foundation report and plans(10pp) Wind zone report (3pp)
Are waivers or modifications	of the building code required?	() Yes (X)	No
Name: Stuart Dean Clark			
LBP or registration number: 5	58384		-
The practitioner is a: ()	Design LBP ( ) Registe architec		ssional
Mailing address: PO Box 40-	339 Upper Hutt		
Street address: 81 Gillespie	es Rd Upper Hutt		
Phone number: Landline:	04 5264109 Mobile	e: 027 4492837	
Daytime:	0274 492837 After I	nours: 04 5264180	
Fax number: 04 5264190 Ema	ail address: stu@nzet.net.nz		
Declaration			
I Stuart Dean Clark			
professional in carrying out or	skill and care reasonably require supervising the Restricted Buil state that the RBW: (a) compli	ding Work described on this f	form

Date: 05/07/2016

00022



#### Memorandum from licensed building practitioner: Certificate of design work

Section 45 and section 30C, Building Act 2004

Please fill in the form as fully and correctly as possible.

THE SUIL DING	
Street address: 137 Weggery Driv	/e
Suburb:	
Town/City: Waikanae	Postcode:
Manufall  Name(s): Jude Wadsworth	
Mailing address: 137 Weggery Dri	ve
Suburb:	PO Box/Private Bag:
Town/City: Walkanae	Postcode:
Phone number:	Email address:

1.1-11-1-1-1-1-1-1-1-1-1-1-1-1-1-1-1-1-	REPUBLICATION OF THE PROPERTY		
am providing this men	norandum in my role as the: Ple	ase tick the option that applies (	ð
	all of the RBW design outlined rk myself – no other person wil		
designers – this	ho carried out some of the RBN memorandum covers their RBN roviding any additional memora	V design work as well as	
design work that	r all but specific elements of RI t I carried out or supervised and elating to their specific RBW de	the other designers will	
	ner who carried out specific ele other designers will be providir		
Dean Murphy	ca	rried out / supervised the	following design work
hat is restricted buildin	g work		
Jusign work Init is RBW	Description of RBW	Carried out or	Neterance to plans and specifications
ick <b>⊘</b> if included. ross <b>⊗</b> if excluded	If appropriate, provide details of the RBW	Tick whether you carried out this design work or supervised someone else carrying out this design work	If appropriate, specify references
NII RBW design work relating O		<ul><li>Carried out</li><li>Supervised</li></ul>	
oundations and		O Carried out	

subfloor framing

O Supervised

Design work that is RBW	Description of RBW	Carried out or supervised	
Tick ⊘if included. Cross ⊗ if excluded	If appropriate, provide details of the RBW	Tick whether you carried out this design work or supervised someone else carrying out this design work	If appropriate, specify references
Walls C	Wall framing & lintels	<ul><li>Carried out</li><li>Supervised</li></ul>	Sheets 1 - 16 Specification
Roof C	Trusses. Pulrins, rafters	Carried out Supervised	Sheets 1 - 18 Specification
Columns and beams	Verandah posts & beam	Carried out Supervised	Sheets 1 - 16 Specification
Bracing C	Wall & Roof bracing	Carried out Supervised	Sheets 1 - 16 Specification
Other C		Carried out Supervised	

Design work that is RBW	Description of RBW	Carried out of supervised	Reference to plans and specifications
Tick Øif included. Cross ⊗ if excluded	If appropriate, provide details of the RBW	Tick whether you carried out this design work or supervised someone else carrying out this design work	If appropriate, specify references
	Hillian High Teach		
All RBW design work relating to E2		<ul><li>Carried out</li><li>Supervised</li></ul>	Sheets 1 - 16 Specification
Damp proofing O		Carried out Supervised	
Roof cladding or roof cladding system		<ul><li>Carried out</li><li>Supervised</li></ul>	
Ventilation system (for example, subfloor or cavity)		Carried out Supervised	
Wall cladding or wall cladding O system		Carried out     Supervised	
Waterproofing O		Carried out     Supervised	
Other O		Carried out     Supervised	

that is RBW	Description of RBW	supervised	
			specifications
Tick ⊘if included. Cross ⊗ if excluded	If appropriate, provide details of the RBW	Tick whether you carried out this design work or supervised someone else carrying out this design work	If appropriate, specify references
HOE EARETY SYSTEM	s C1 - 06		
Emergency warning systems			Smoke Alarm
Evacuation and fire service operation systems		O Carried out O Supervised	Smoke Alarm
Suppression or control systems Other			
Waivers or modifications	of the Building Code are requ	ired O Yes O No	
7.7	the waivers or modifications be		
Clause	Waiver/modification requi		
List relevant clause numbers of building code	Specify nature of waiver or modific		

BRUCE III	
Name and contact details of the licensed building prodesign work that is restricted building work.	actitioner who is licensed to carry out or supervise
Name: Dean Murphy	LBP or Registration number: BP108601
The practitioner is a: O Design LBP O Registere	ed architect O Chartered professional engineer
Mailing address (if different from below):	
Street address/Registered office: 112 Waterloo	Road
Suburb: Sockburn	Town/City: Christchurch
PO Box/Private Bag: PO Box 11013	Postcode: 8013
Phone number: 03 3491280	Mobile: 027 432 4689
After hours:	Fax: 03 3491283
Email address: dean.murphy@spanbild.co.nz	Website: www.spanbild.co.nz

DECLARA	TION	
Dean	Murphy	certify that the design work that is restricted building
work identif	ied on this form:	
• Comp	lies with the building code, or	
	lies with the building code subject t led on this form	o any waiver or modification of the building code
Signature:	D. Muyes	
Date:	27/7/2016	

Builder - tha



### Memorandum from licensed building practitioner: Record of building work

Section 88, Building Act 2004

Please fill in the form as fully and correctly as possible.

Street addres	s: 137 W	KERY J	DRIVE
Suburb:	, , , , , ,		0400
Town/City:	WAILGINAK	*	Postcode:
Building cons			
Banang Cons	ent number:		
- Januari G Coris	ent number:		
	:		
	:		
Vame(e):			The state of the s
Name(s):	REW JENKI	ins Jaga E	ENORG JUDITH WASTERS
Vame(e)	REW JENKI	ins Syra E	ENDRA, JUDITH WASSINGT
Name(s): みん Mailing address	REW JENKI	ins Syra E	ENORG JUDITH WASTERS

PRIMARY STRUCTURE		
Work that is restricted building work	Description of restricted building work	Carried out or supervised
Tick 🕢	If necessary, describe the restricted building work.	Tick whether you carried out the restricted building work or supervised someone else carrying out the restricted building work.
Foundations and subfloor framing		Carried out Supervised
Walls &		Carried out Supervised
doof		Carried out Supervised
olumns and oams		Carried out Supervised
acing		Carried out     Supervised
ner O		Carried out Supervised

Work that is restricted building work	MANAGEMENTS STEMS  Description of restricted building work	Carried out or supervised
Tick Ø	If necessary, describe the restricted building work.	Tick whether you carried out the restricted building work or supervised someone else carrying out the restricted building work.
Damp proofing Q	VERSATILE BUILDINGS PO BOX 54060 MANA 5247	Carried out Supervised
Roof cladding or roof cladding System		Carried out Supervised
Ventilation system (for example, subfloor or cavity)		Carried out Supervised
Vall cladding r wall cladding ystem		Carried out Supervised
aterproofing O		Carried out Supervised
her		Carried out     Supervised

builder

restricted building work.	ding practitioner who is licensed to carry out or supervise
Name:	LBP number:
Class(es) licensed in:	
Plumbers, Gasfitters and Drainlayers registration  Mailing address (if different from below):	*
Street address/RegisterVERSATILE BUILDI	NGS
Suburb: PO BOX 54060 MANA 5247	Town/City: PERIPARA
PO Box/Private Bag	Postcode:
Phone number: 233752P	Mobile:
After hours:	Fax:
mail address: marks e protile was	Website:

work recorded on this form.	carried out or supervised the restricted building
Signature:	
Date:	

Builder - 460 .

## Memorandum from licensed building practitioner: Record of building work

Section 88, Building Act 2004

Please fill in the form as fully and correctly as possible.

VE
Cle
Postcode:
OKA JUDITH WAS EVERYH
OKA, JUDITH WAS ENERGH
Private Bag:
Postcode:
. 00:0006.
i

PRIMARY STRUCTURE		
Work that is restricted building work	Description of restricted building work	Carried out or supervised
Tick 🕖	If necessary, describe the restricted building work.	Tick whether you carried out the restricted building work or supervised someone else carrying out the restricted building work.
Foundations and subfloor framing		Carried out Supervised
Walls d		Carried out     Supervised
Roof		Carried out Supervised
Columns and earns		Carried out     Supervised
racing		Carried out Supervised
her		Carried out Supervised

Work that is restricted building work	MANAGEMENT SYSTEMS  Description of restricted building work	Carried out or supervised
Tick 🕢	If necessary, describe the restricted building work.	Tick whether you carried out the restricted building work or supervised someone else carrying out the restricted building work.
Damp proofing	VERSATILE BUILDINGS PD BOX 54060 WANA 5247	Carried out Supervised
Roof cladding or roof cladding system		Carried out Supervised
Ventilation system (for example, subfloor or cavity)		Carried out Supervised
Vall cladding or wall cladding system		Carried out Supervised
Vaterproofing (		Carried out     Supervised
ther		Carried out     Supervised

balder to.

Date:

restricted building work.	building practitioner who is licensed to carry out or supervise
Name:	LBP number:
Class(es) licensed in:	
Plumbers, Gasfitters and Drainlayers regist	tration number (if applicable):
Mailing address (if different from below): 18	
Street address/Registered office:	, projuger years
Suburb: VERSATILE BUIL! PO BOX 54060	Town/City:
PO Box/Private Bag MANA 5247	Postcode:
Phone number: (04) 2337578	Mobile:
After hours:	Fax:
mail address: markse versatile w	Website:
	J. (2. 1)2
ECLAPATION	

## Memorandum from licensed building practitioner: Record of building work

Section 88, Building Act 2004

PLYMGING / DRAINLAYING

Please fill in the form as fully and correctly as possible.

Street address: 137 WELLER	Y DRIJE
Suburb:	
Town/City: WAIKANAI.	Postcode:
Building consent number:	
Building consent number:	
Building consent number:	
Building consent number:  Jewiki ルス	, JORG ENOKG, JUDITH WADSWERTH
Building consent number:  Jewking  Jew	, JORA ENOKA, JUDITH WARSWERTH
Building consent number:  Name(s): みしたい ブミルバルス Mailing address: お7 いたによれ	, JORG ENOKG, JUDITH WADSWERTH

PRIMARY STRUCTURE		
Work that is restricted building work	Description of restricted building work	Carried out or supervised
Tick 🕢	If necessary, describe the restricted building work.	Tick whether you carried out the restricted building work or supervised someone else carrying out the restricted building work.
Foundations and subfloor framing		Carried out Supervised
Walls		Carried out     Supervised
Roof		Carried out Supervised
Columns and Deams		Carried out Supervised
Bracing O		Carried out Supervised
ither		Carried out Supervised

Work that is rest building work	tricted	Description of restricted building work	Carried out or supervised
Tick ②		If necessary, describe the restricted building work.	Tick whether you carried out the restricted building work or supervised someone else carrying out the restricted building work.
Damp proofing	0		Carried out     Supervised
Roof cladding or roof cladding system	0		Carried out     Supervised
Ventilation system (for example, subfloor or cavity)	0		Carried out Supervised
Vall cladding r wall cladding ystem	0		Carried out     Supervised
aterproofing	0		Carried out Supervised
her	0		Carried out Supervised

Name and contact details of the licensed building practitioner who is licensed to carry out or supervise restricted building work. Name: CROIS HODERSON PLYMBING &
Classical licensed in: DRAMAGE LTO. LBP number: Plumbers, Gasfitters and Drainlayers registration number (if applicable): Mailing address (if different from below): Street address/Registered office: 154 MojuHapa Suburb: Town/City: PO Box/Private Bag Postcode: Phone number: Mobile: After hours: Fax: Email address: Website: carried out or supervised the restricted building work recorded on this form. Signature: Date:

	7	STRUCTURAL Complete for all projects incorporating specific structural design	*
	а	Structural Calculations If any design work required the services of a structural engineer, attach 2 copies of the calculations with this. The calculations must be prefaced with information explaining the design philosophy and justification of assumptions and methodologies used in analysis	_ [
d	b	Expert Opinion (Producer Statements) Expert Opinion including Producer Statements certifying compliance with the New Zealand Building Code, a copy must be attached with this application. (Note all structural Producer Statements are required to have accompanying calculations.)	/-
	8	SPECIFICATIONS  Complete for all applications  Note: the specification must be specific to the project and cover all aspects of the proposed work	
	а	Specification: General	
D	a	<ul> <li>Elements of structure (size, spacing, timber treatment)</li> <li>Finish or fixings to meet durability requirements</li> <li>Plumbing and drainage materials and design that installation is to comply with</li> <li>Wet area surfaces</li> <li>Ventilation systems</li> <li>Flooring slip resistance for access routes</li> <li>Glazing</li> <li>Type of smoke detectors (including existing smoke detectors where they will remain)</li> </ul>	_
	b	External Claddings  For each of the following claddings provide details of the product name, manufacturer, maintenance requirements and warranties offered  Building wraps  Wall claddings  Roof claddings  Membranes (roof and decks)  Tanking  Joinery	
The last	9	DEMOLITION / REMOVAL  Complete for all projects involving demolition of significant parts of buildings or the demolition or removal of whole buildings	
	а	Means of Barricading the Site Provide details of temporary barriers, gates which swing inwards or other means of restricting public access to the area	9
	b	Proposed Tipping Lecation for Demolition Materials (address/landfill)	
	С	Hazardous Building Material Provide safety plan detailing the safe handling and disposal of hazardous materials	
	d	Site Management Plan Covering  Management to control silt runoff, noise and dust	
	е	Proposed Destination for Relocate Building	2
	f	Access To and From the Site (including use of kerb crossings)	/U
	g	Specify Termination of Existing Services  Water  Sewer  Stormwater	