# Proposed New Dwelling for:

# **Cambridge Homes North Waikato**

At: 152 Rimu Street, Lakeside, Te Kauwhata

Lot:49 DP: 542256

Plan Type "Oakland"

Sheet Index		
No.	Layout Name	
100	Cover Page	
101	Information	
102	Location Plan	
103	Site Plan	
104	Site Setout Plan	
105	Drainage Plan	
106	Earthworks Plan	
201	Floor Plan	
202	Foundation Plan	
203	Roofing Plan	
204	Bracing Plan	
301	Elevations	
401	Sections	
501	Post / Porch Details	
502	Roof Details	
503	Joinery Details	
504	Cladding Details	
505	Cladding Details	
506	Fixing Details	
507	Wetroom Details	
508	Bracing & Site Details	
601	Window / Door Schedul	
602	Lighting Plan	

Waikato District Council Building Consent Number BLD0440/24

**APPROVED** 





## **Scope of Works:**

Single storey dwelling constructed with:

- Waffle Foundation
- JH Hardieflex Sheet & Battens Wall Cladding
- Trapezoidal Roofing

## The dwelling consists of:

- Open living area
- 3 Bedrooms
- Bathroom & WC

## **REVISION 1: 10/12/2023**

- \* Bottom plate fixing noted
- \* Lintel design noted updated

#### Additional Changes: 10/12/2023

- \* 7mm Ecoply rigid air barrier
- Detail updated
- \* Bracing updated
- \* Nogs to entire dwelling changed to 1200crs
- \* R8 Ceiling insulation added
- \* uPVC joinery change
- \* D003 Removed
- \* Truss heel heights increased

The Copyright of these plans shall remain with Cambridge Homes Waikato (North).

 $Cambridge\ Homes\ Waikato\ (North)\ accepts\ no\ responsibility\ for\ any\ work\ undertaken\ that\ is\ not\ in\ strict\ accordance\ with\ these\ drawings$ 

All construction shall be in strict accordance with the New Zealand Building Code.

Contractor shall check and verify all dimensions, setouts, and levels on site, prior to commencing contract, and shall immediately notify Cambridge Homes Waikato (North) of any discrepancies or errors.

#### General:

#### Smoke Alarms:

- (S) = Smoke Alarm
- Shall be in accordance with NZBC clause F7/ AS1.3.1.
- May be battery powered & shall be located at top of stairs, in every sleeping space, or within 3.0m of every sleeping space door.

#### Mechanical Ventilation:

(E) = Extractor Fan

#### Lighting:

- All downlights shall be CA rated, refer to specification.

#### Floor Surfaces:

- All floor surfaces on accessible routes & any vinyl or tiled surface shall comply with NZBC clause D1, section 2.1, such that they shall have a coefficient of friction  $\mu$ , of not less than 0.4 when tested in accordance with AS/NZS 3661.1.

#### Fixings:

All brackets, bolts, washers and fixings sheltered or exposed to wetting or in contact with H3.2 & above to be of 304 stainless steel

#### Framing: VERY HIGH ZONE

- Internal & external walls to be kiln dried H1.2 SG8 (unless specified elsewhere). Stud height is 2420mm (2455mm over extra top plate) Studs centres as stated below Load bearing external walls:

- 2.4m Stud 90x45 @ 400crs Load bearing internal walls:

90x45 @ 600crs - 2.4m Stud Non load bearing internal walls:

- 2.4m Stud 90x45 @ 600crs

(nogs as stated under cladding section)

#### **GIB Lining:**

- 10mm GIB to wall
- 10mm Aqualine to wet area walls
- 13mm GIB to ceilings
- 13mm Aqualine to wet area ceilings

- Farthwool/R218 to walls (excluding garage)

- Earthwool R8.0 to ceiling (excluding garage)

- EarthwoohR3,6 to perimeter of ceiling as

shown in cross sections - 500mm

(refer sheet 203 for location of R3.6 insulation)

- 100mm H Grade Expol insulation under entire foundation
- Resene Duratherm Blue to foundation edge

## Cladding:

#### Cladding:

- James Hardie Flex & Batten. Battens @ 400crs

Colour: Gravel

IRV = 12- H3.2 45x20mm treated timber cavity batten

- Nogs @ 1200crs

#### Air Barrier:

- 7mm Ecoply Barrier (Rigid)

## Soffit Linings:

- 4.5mm Hardieflex

#### Roofing:

- Selected Trapezoidal roof cladding

Colour: Flaxpod

- 28° roof pitch

- Colorcote 185 Multifit fascia

Colour: Flaxpod

LRV = 6

LRV = 6

LRV = 6

- Colorsteel 1/4 round spouting Colour: Flaxpod

- 80mm Dia. pvc downpipes

Colour: Flaxpod

LRV = 6- Soffit overhangs to be 150mm (unless specified)

- Verge overhangs to be 150mm (unless specified)

#### Roofing Underlay:

- Thermakraft 215 Bituminous Self Supporting Roofing Underlay

#### Roof Framing:

- 70x45 H1.2 SG8 purlins

End Spacing: 600crs Intermediate spacings: 900crs

#### **Ceiling Framing:**

- 35mm Rondo metal ceiling battens @ 600crs

#### Window & Doors:

- All dimensions are given as trim sizes & site measure MUST be done before joinery manufacturing

#### External Joinery:

- 2000mm head height (unless stated otherwhere)
- Joinery units are not rebated
- Starke uPVC joinery

#### Colour: Flaxpod

LRV = 6

- Clear double glazed, Low E, Argon filled throughout (excluding garage)
- (- 1/9 mm H3.1) pre-primed timber liners
- Safety & Obscure glass to all bathrooms &
- Safety glass to panels as shown on window schedule (refer sheet 601)
- Glazing must be installed as per NZS 4223
- Safety glass in glazing below 2000mm above FFL & in all bathroom & ensuite window joinery in accordance with NZS 4223.3
- flexible flashing tape around bottom and corners of window openings

#### Internal Joinery:

- 1980mm head height (unless stated otherwhere)
- Sizes as per floor plan (refer sheet 201)

#### Garage Door:

- 2000mm head height

Colour: Flaxpod LRV = 6

## **Plumbing Fixtures:**

#### Bathroom:

- 1700 Shub
- 900mm single bowl vanity
- Standard WC

## WC:

- Standard WC

#### Hot water system:

- 190L Heat pump hot water cylinder (Ecospring)

## **Impervious Surfaces:**

- 39mm Duroapl Laminate Bench tops
- Tiled splashback behind hob
- Tiled splashback behind sink (1 tile high)
- Wet Area walls to be painted with semi-gloss

Waikato District Council **Building Consent Number** BLD0440/24

**APPROVED** 

BUILDING ENVELOPE RISK MATRIX		
Worst Case Scenario		
Risk Factor	Risk Severity	Risk Score
Wind zone (per NZS 3604)	Very high risk	2
Number of storeys	Low risk	0
Roof/wall intersection design	Very high risk	5
Eaves width	High risk	2
Envelope complexity	Low risk	0
Deck design	Low risk	0
Total Risk Score:		9

## Additional Changes: 10/12/2023

- \* 7mm Ecoply rigid air barrier
- \* Nogs to entire dwelling changed to 1200crs
- \* R8 Ceiling insulation added
- \* uPVC joinery change

The Copyright of these plans shall remain with Cambridge Homes Waikato (North)

Cambridge Homes Waikato (North) accepts no responsibility for any work undertaken that is not in strict accordance with these drawings.

All construction shall be in strict accordance with the New Zealand Building Code.

Contractor shall check and verify all dimensions, setouts, and levels on site, prior to commencing contract, and shall immediately notify Cambridge Homes Waikato (North) of any discrepancies or errors



#### **CAMBRIDGE HOMES**

Enquires: 021 932 038 Website: www.cambridgehomes.co.nz Drawn By: JP Designs Ltd

## Information

Plan Type "Oakland"

## **Cambridge Homes North Waikato**

152 Rimu Street, Lakeside

/ERSION:	REVISION:	DATE:
1.0	Consent	21/10/2023
1.0	Revision	10/12/2023

@A3

LS - 49

101



Waikato District Council Full Application Received 26/10/2023

The Copyright of these plans shall remain with Cambridge Homes Waikato (North).

Cambridge Homes Waikato (North) accepts no responsibility for any work undertaken that is not in strict accordance with these drawings.

All construction shall be in strict accordance with the New Zealand Building Code.

Contractor shall check and verify all dimensions, setouts, and levels on site, prior to commencing contract, and shall immediately notify Cambridge Homes Waikato (North) of any discrepancies or errors.



## **CAMBRIDGE HOMES**

Enquires: 021 932 038 Website: www.cambridgehomes.co.nz Drawn By: **JP Designs Ltd** 

SHEET TITLE

## Location Plan

Plan Type "Oakland"

- - - - - -

## **Cambridge Homes North Waikato**

152 Rimu Street, Lakeside

UERCION PERIODI


1.0 Consent 21/10/2023

@A3

102

DB NUMBER:


LS - 49

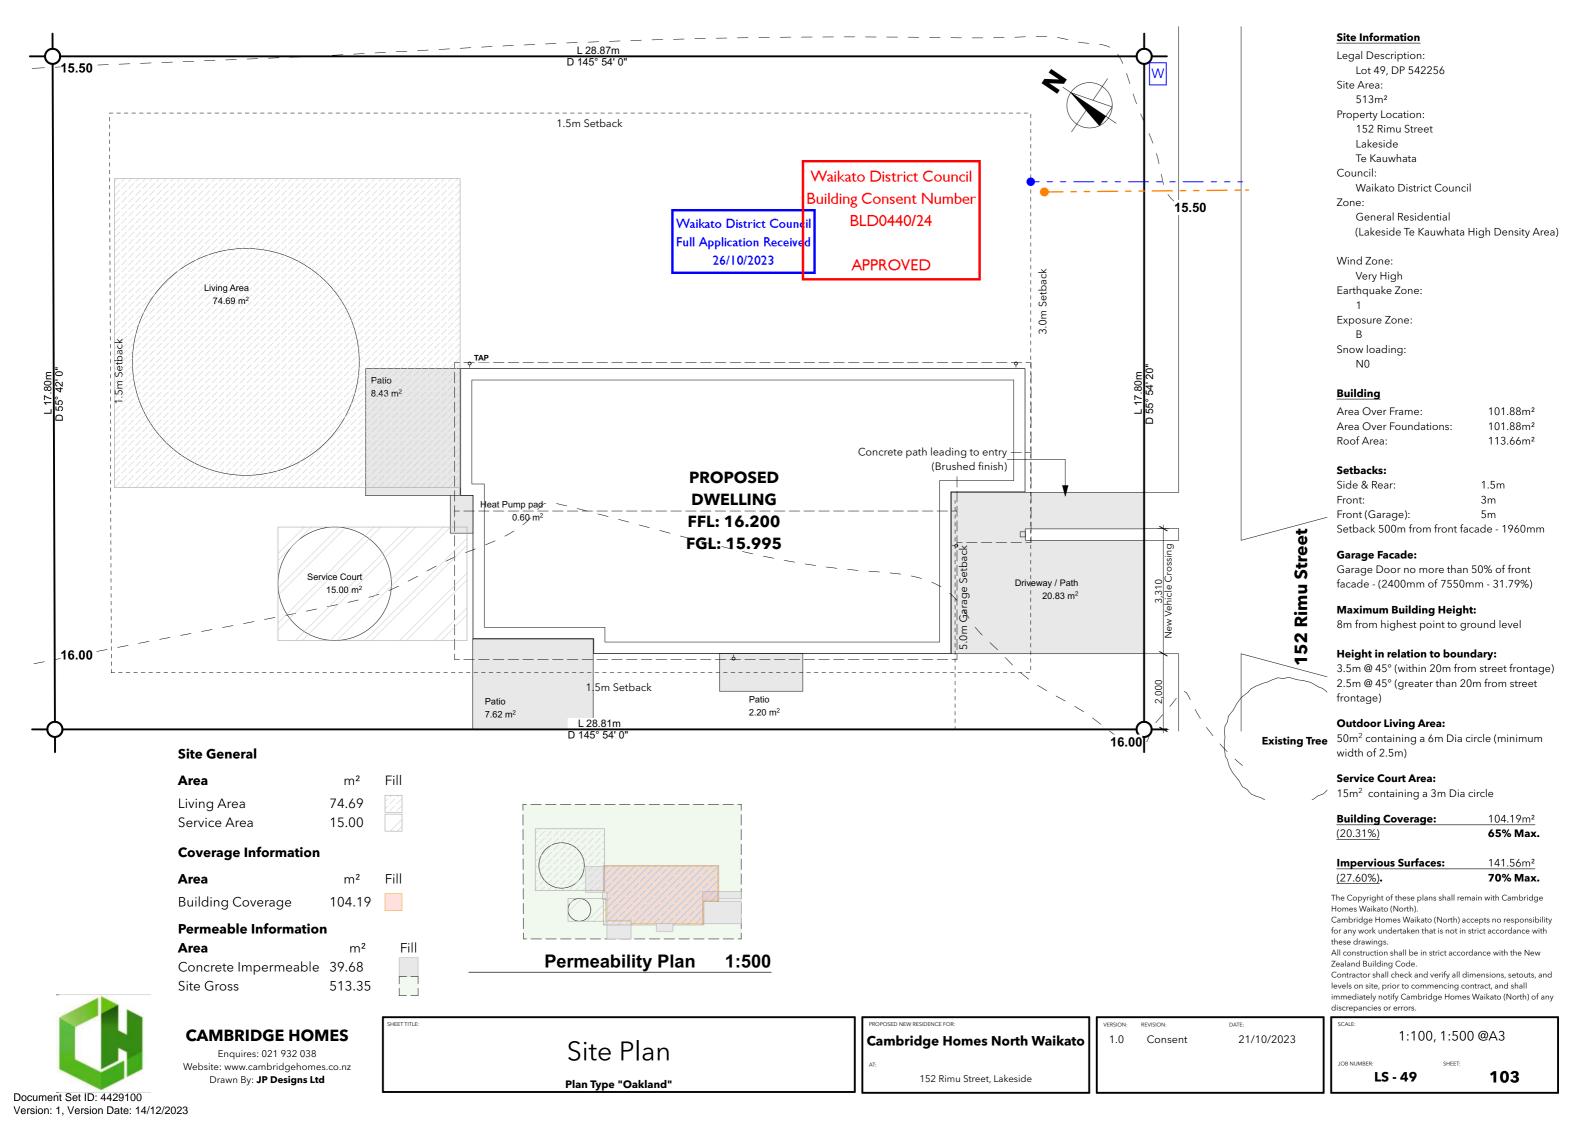

Waikato District Council Full Application Received 26/10/2023

Waikato District Council **Building Consent Number** BLD0440/24

**APPROVED** 

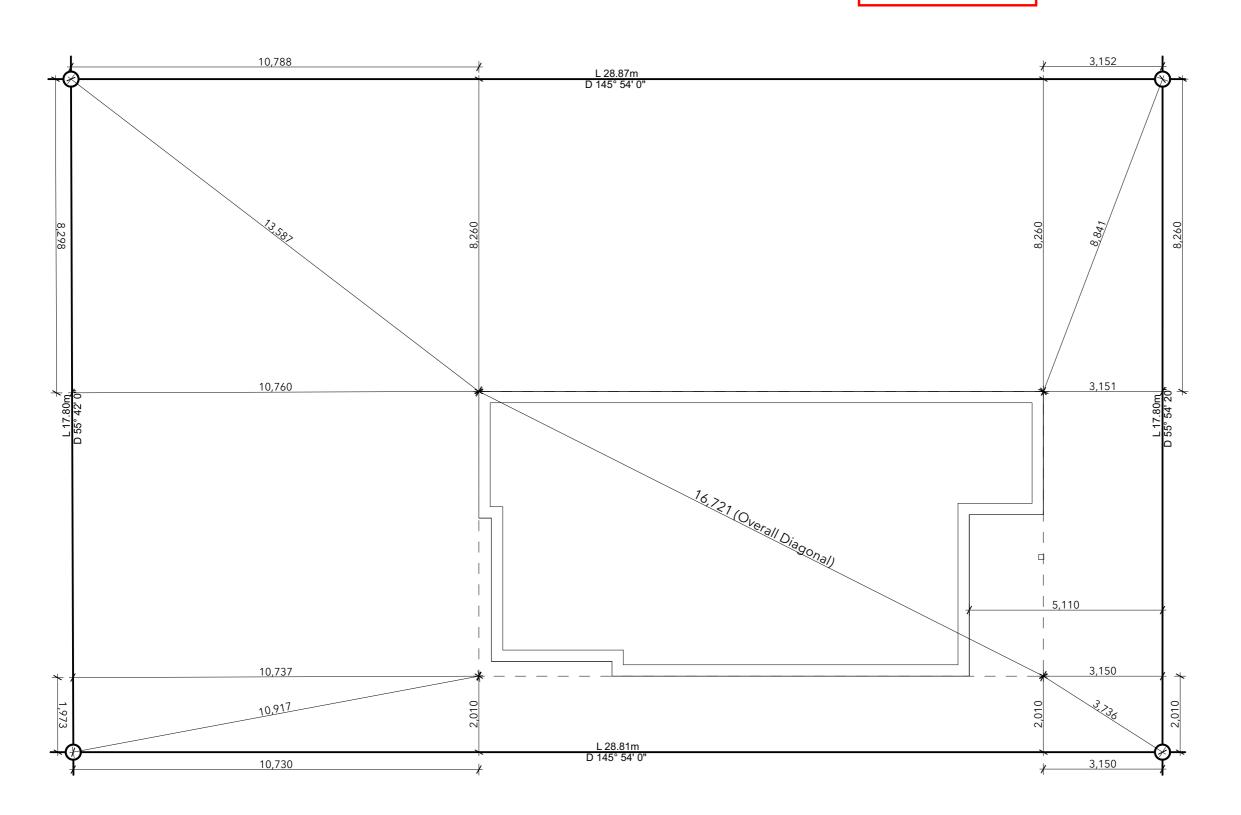

The Copyright of these plans shall remain with Cambridge Homes Waikato (North).

Cambridge Homes Waikato (North) accepts no responsibility for any work undertaken that is not in strict accordance with these drawings.
All construction shall be in strict accordance with the New

Zealand Building Code.

Contractor shall check and verify all dimensions, setouts, and levels on site, prior to commencing contract, and shall immediately notify Cambridge Homes Waikato (North) of any discrepancies or errors.



## **CAMBRIDGE HOMES**

Enquires: 021 932 038 Website: www.cambridgehomes.co.nz Drawn By: JP Designs Ltd

## Site Setout Plan

Plan Type "Oakland"

## **Cambridge Homes North Waikato**

152 Rimu Street, Lakeside

1.0 Consent 21/10/2023

1:100 @A3

LS - 49

104

#### Plumbing & Drainage; All plumbing in accordance with NZBC G13 Waste Water Gradients: Up to DN80 uPVC Over DN80 uPVC = 1:60 Stormwater Gradients DN100 uPVC = 1:100

Legend;	
<b>──</b>	=Slope Direction
	= Stormwater Drain
	= Wastewater Drain
DP	= 80mm uPVC Downpipe
IB	= Inspection Bend
IJ	= Inspection Junction
GT	= Gully Trap
ORG	= Overflow Relief Gully
TV	= Terminal Vent (80mm)
AAV	= Air Admission Valve
В	= Basin
S	= Sink
SHR	= Shower
TUB	= Laundry Tub
WC	= Water Closet


#### **Plumbing Notes:**

- Low flow fixtures to be installed when possible

Plumbing Fi	ixtures, Unit Ra	tings (UR), & Pipe Sizes
Kitchen	fixture unit rating	trap & waste
sink with	3	= DN50 trap/ DN50 waste
dishwasher		
Bathroom		
basin	1	= DN40 trap/ DN50 waste
shower	2	= DN40 trap/ DN50 waste
WC	4	= DN80 trap/ DN80 waste
wc		
WC	4	= DN80 trap/ DN80 waste
Laundry		
tub/cw	5	= DN50 trap/ DN50 waste
machine		•

## **PLAN MUST BE PRINTED IN COLOUR**

Waikato District Council **Building Consent Number** BLD0440/24 **APPROVED** 

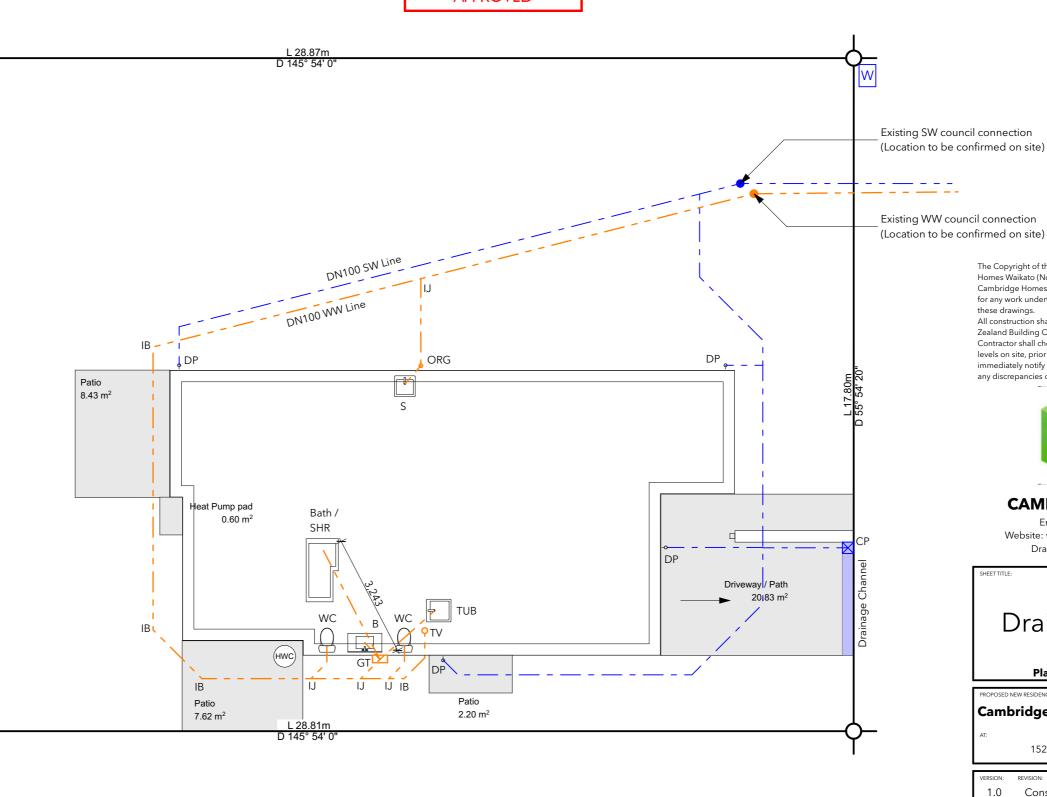

Waikato District Council **Full Application Received** 26/10/2023

The Copyright of these plans shall remain with Cambridge Homes Waikato (North).

Cambridge Homes Waikato (North) accepts no responsibility for any work undertaken that is not in strict accordance with these drawings.

All construction shall be in strict accordance with the New Zealand Building Code.

Contractor shall check and verify all dimensions, setouts, and levels on site, prior to commencing contract, and shall immediately notify Cambridge Homes Waikato (North) of any discrepancies or errors.



#### **CAMBRIDGE HOMES**

Enquires: 021 932 038 Website: www.cambridgehomes.co.nz Drawn By: JP Designs Ltd

## Drainage Plan

Plan Type "Oakland"

## **Cambridge Homes North Waikato**

152 Rimu Street, Lakeside

1.0 Consent 21/10/2023

1:100 @A3

LS - 49

105



Waikato District Council **Building Consent Number** BLD0440/24 **APPROVED** 


Datum (on road outside Lot 359) WWMH B/5 LL = 14.23



- Plans must be read in conjunction with Soil Investigation Report by Probase Engineering Limited (Ref P22085)
- All surface water must slope away from the dwelling

- Earthworks and sediment control to be in accordance with the district plan & regional plan Approximately 50m³ of soil to be stripped from building platform & Driveway and stockpiled on
- be brought on to site

- and stable for the duration of the intended land use; be geographically sound; withstand and
- measures will be adopted to minimise any sediment leaving the site and entering any
- that no earthworks shall obstruct and stormwater overland flow path; to keep roads clean and free to create a dust nuisance
- re-grassed as soon as practical

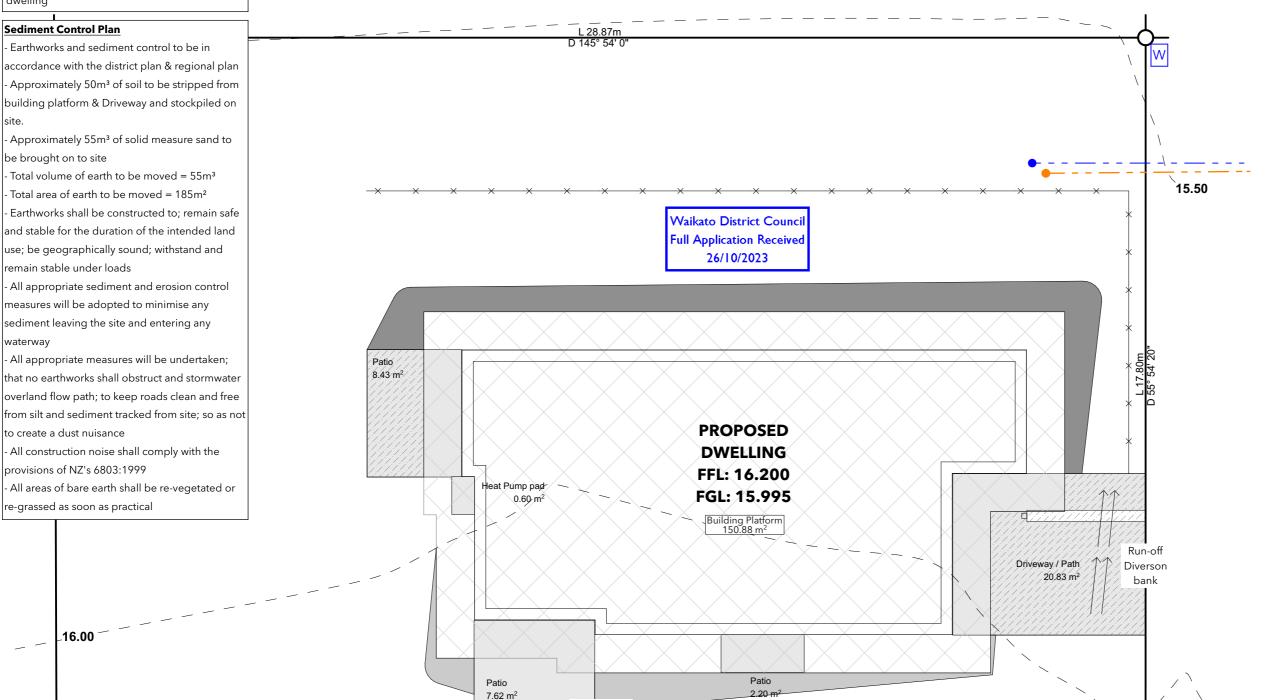

The Copyright of these plans shall remain with Cambridge Homes Waikato (North).

Cambridge Homes Waikato (North) accepts no responsibility for any work undertaken that is not in strict accordance with these drawings.

All construction shall be in strict accordance with the New Zealand Building Code.

Contractor shall check and verify all dimensions, setouts, and levels on site, prior to commencing contract, and shall immediately notify Cambridge Homes Waikato (North) of any discrepancies or errors



## **CAMBRIDGE HOMES**

Enquires: 021 932 038 Website: www.cambridgehomes.co.nz Drawn By: JP Designs Ltd

## Earthworks Plan

Plan Type "Oakland"

**Cambridge Homes North Waikato** 

152 Rimu Street, Lakeside

1.0 Consent 21/10/2023

1:100 @A3

LS - 49

16.00

106

Rooms require openings with a net openable area of no less

than 5% of the floor area of the space

Bathroom

Floor Area = 6.00m<sup>2</sup> (5% = 0.3m<sup>2</sup>) Net openable area = 0.6m<sup>2</sup> (10.00%)

WC:


Floor Area = 1.91m<sup>2</sup> (5% = 0.0955m<sup>2</sup>) Net openable area = 0.6m<sup>2</sup> (31.41%)

Laundry / Garage

Floor Area = 17.13m<sup>2</sup> (5% = 0.86m<sup>2</sup>) Net openable area = 1.8m<sup>2</sup> (10.50%)

Waikato District Council Building Consent Number BLD0440/24

**APPROVED** 

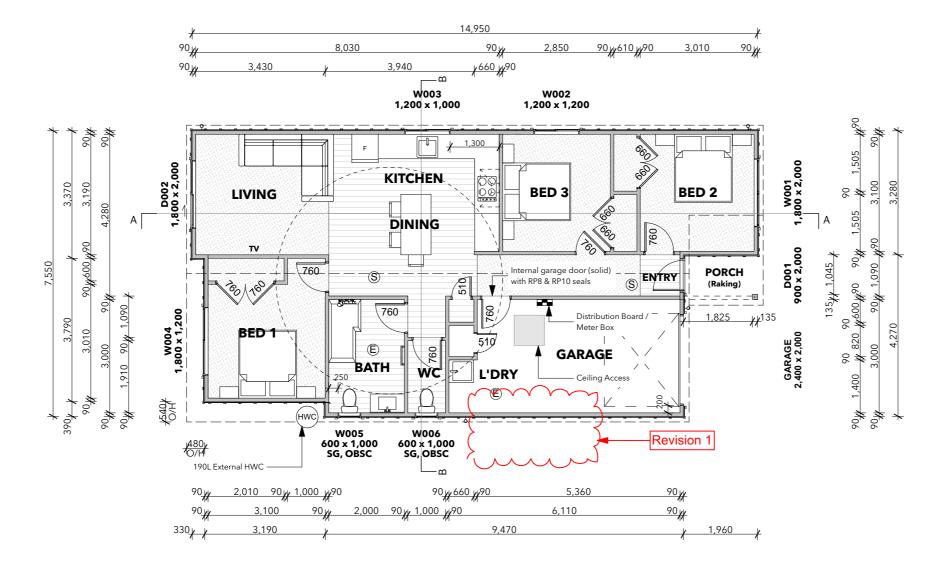

Areas:

Living Area: 83.24m<sup>2</sup>
Garage Area: 18.64m<sup>2</sup>
Total Area (O/Frame): 101.88m<sup>2</sup>

Total Area (O/Foundation): 101.88m²

Roof Area: 113.66m<sup>2</sup> Porch Area: 2.31m<sup>2</sup>

Additional Changes: 10/12/2023

D003 Removed

The Copyright of these plans shall remain with Cambridge Homes Waikato (North).

Cambridge Homes Waikato (North) accepts no responsibility for any work undertaken that is not in strict accordance with these drawings.

All construction shall be in strict accordance with the New Zealand Building Code.

Contractor shall check and verify all dimensions, setouts, and levels on site, prior to commencing contract, and shall immediately notify Cambridge Homes Waikato (North) of any discrepancies or errors.



#### **CAMBRIDGE HOMES**

Enquires: 021 932 038 Website: www.cambridgehomes.co.nz Drawn By: **JP Designs Ltd** 

SHEET TITLE

## Floor Plan

Plan Type "Oakland"

## Cambridge Homes North Waikato

152 Rimu Street, Lakeside

2 1.0 Consent 21/10/2023 1.0 Revision 10/12/2023

scale: 1:100 @A3

JOB NUMBER: SHEET:

LS - 49 201

Carpet

Concrete

Planking

#### Notes:

Plans must be read in conjunction with the following reports:

- Soil report by Probase Consulting Engineers (REF P22085)

#### Slab

Firth Ribraft Floor. Refer drawings / specifications for further information Current Codemark certificate V3 and current Firth Ribraft 2020 Manual take precedence over general foundation details shown within plans


#### Insulation:

- 100mm H Grade Expol insulation under
- entire foundation
- Resene Duratherm Edge

Sawcut to be spaced @ 6m crs maximum


## NO LOAD BEARING INTERNAL WALLS NO INTERNAL SLAB THICKENINGS

DPM to be Mitre 10 Trade 250mu laid underneath the waffle slab and on top of the sand pad

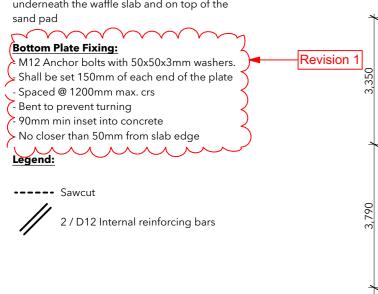

Waikato District Council Building Consent Number BLD0440/24

**APPROVED** 

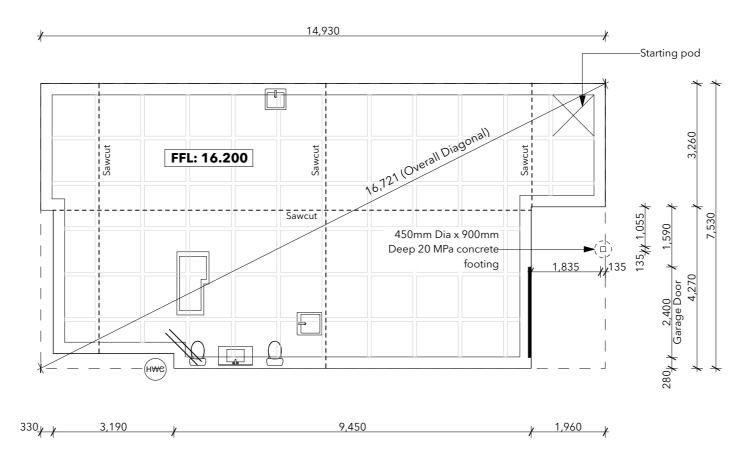

#### **REVISION 1: 10/12/2023**

\* Bottom plate fixing noted

The Copyright of these plans shall remain with Cambridge Homes Waikato (North)

Cambridge Homes Walkato (North) accepts no responsibility for any work undertaken that is not in strict accordance with these drawings.

All construction shall be in strict accordance with the New Zealand Building Code.

Contractor shall check and verify all dimensions, setouts, and levels on site, prior to commencing contract, and shall immediately notify Cambridge Homes Waikato (North) of any discrepancies or errors.



## **CAMBRIDGE HOMES**

Enquires: 021 932 038 Website: www.cambridgehomes.co.nz Drawn By: **JP Designs Ltd** 

HEET TITLE:

## Foundation Plan

Plan Type "Oakland"

## Cambridge Homes North Waikato

AT:

152 Rimu Street, Lakeside

 VERSION:
 REVISION:
 DATE:

 1.0
 Consent
 21/10/2023

 1.0
 Revision
 10/12/2023

SCALE:

@A3

CH

LS - 49

202

## Very High Wind Zone Roof Pitch 28°

Refer to buildable truss layout by Mitre 10 (Waikato
Frame & Truss)
Lintel sizes and fixings are designed by
Architectural Designer

Job 1ef. 93 175-12

Top plate fixing as per alternative fixing from lumberlok

 $\overline{B} = 2/90 \text{ X}$  3.15 End nails & 2 wire dogs (All top plate fixings are B)


#### Verges

70x45 H1.2 SG8 cantilevers purlins (max. 300mm cantilever)

#### **Purlins**

70x45 H1.2 SG8 @ 900crs max. End Span 600mm, Intermediate span 900crs with T1 fixing pattern

T1 fixing pattern = Fix every crest

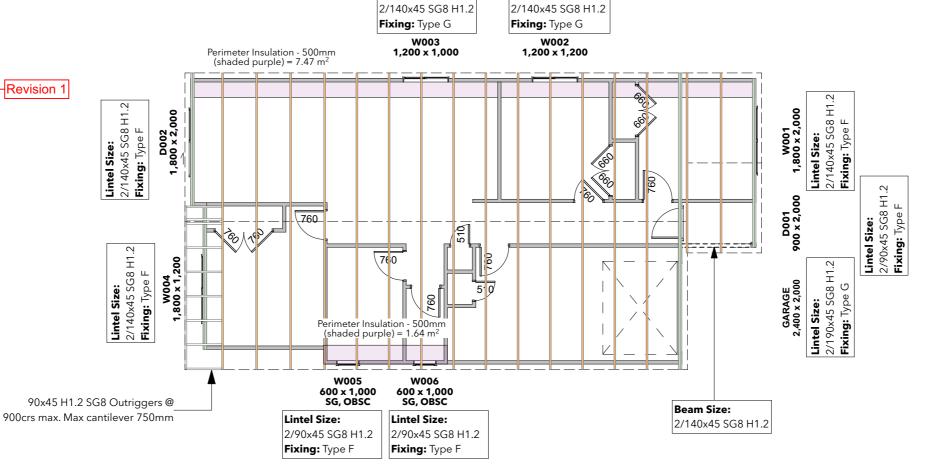

**Lintel Size:** 

Lintel Size:


## Roof Framing Plan 1:100

Waikato District Council Building Consent Number BLD0440/24

**APPROVED** 

## **Spouting** = Steel & Tube Multiline

6850mm<sup>2</sup> cross sectional area 54m<sup>2</sup> max, roof area per outlet as per Steel and Tube specifications and building code E1. Figure 15 70m<sup>2</sup> max roof area per downpipe

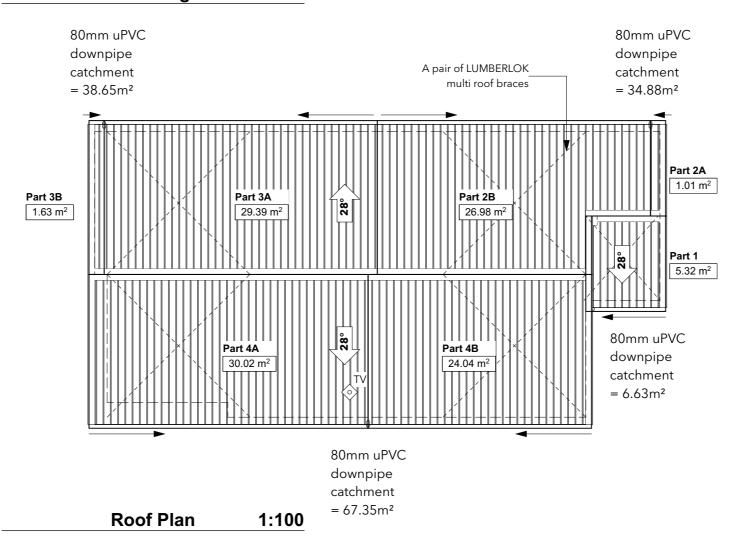

## **REVISION 1: 10/12/2023**

- \* Lintel design noted updated
- \* D003 Removed

The Copyright of these plans shall remain with Cambridge Homes Waikato (North).

Cambridge Homes Waikato (North) accepts no responsibility for any work undertaken that is not in strict accordance with these drawings.

All construction shall be in strict accordance with the New Zealand Building Code.

Contractor shall check and verify all dimensions, setouts, and levels on site, prior to commencing contract, and shall immediately notify Cambridge Homes Waikato (North) of any discrepancies or errors.



#### **CAMBRIDGE HOMES**

Enquires: 021 932 038 Website: www.cambridgehomes.co.nz Drawn By: **JP Designs Ltd** 

SHEET TITLE

## Roofing Plan

Plan Type "Oakland"

#### PROPOSED NEW RESIDENCE FOR:

## Cambridge Homes North Waikato

152 Rimu Street, Lakeside

 VERSION:
 REVISION:
 DATE:

 1.0
 Consent
 21/10/2023


1.0 Revision 10/12/2023

1.10

1:100 @A3

UMBER: **LS - 49** 

203

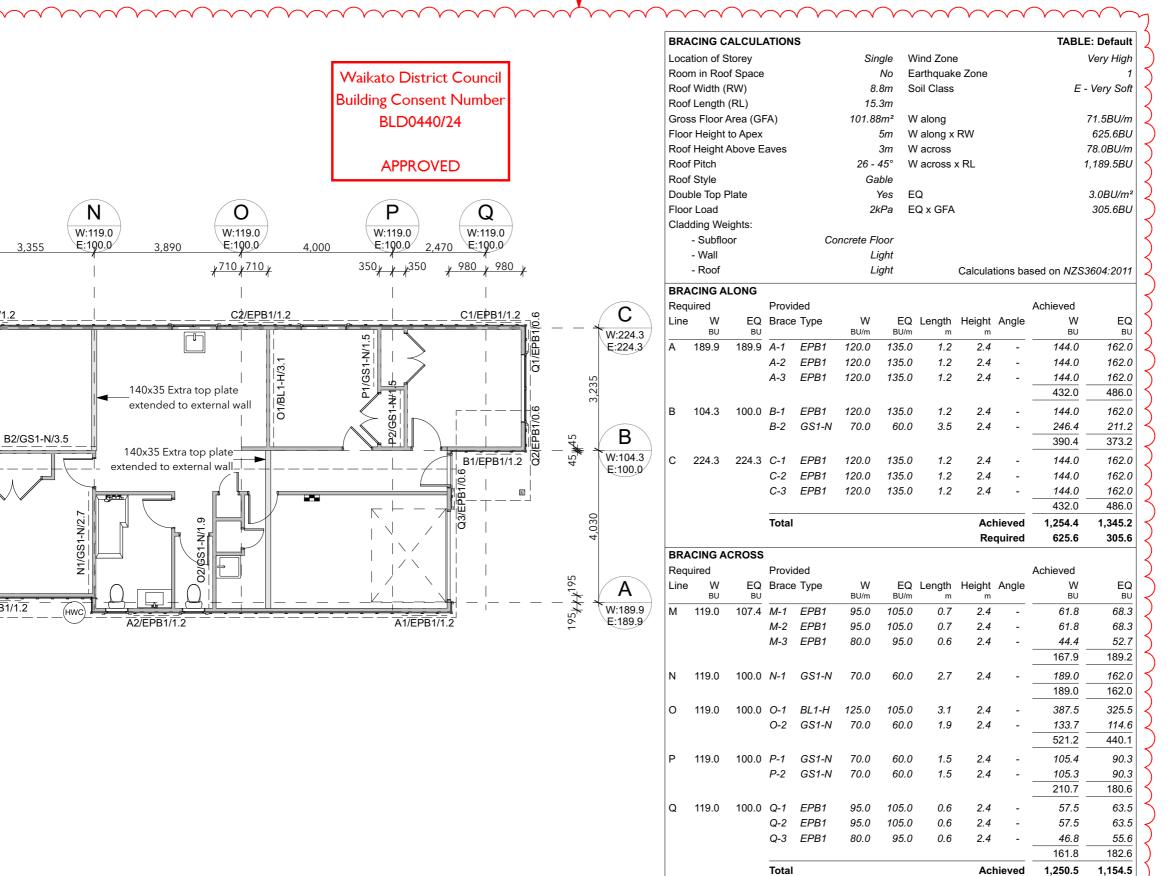

Revision 1

The Copyright of these plans shall remain with Cambridge Homes Waikato (North).

Cambridge Homes Waikato (North) accepts no responsibility for any work undertaken that is not in strict accordance with these drawings.

All construction shall be in strict accordance with the New Zealand Building Code.

Contractor shall check and verify all dimensions, setouts, and levels on site, prior to commencing contract, and shall immediately notify Cambridge Homes Waikato (North) of any discrepancies or errors.



#### **CAMBRIDGE HOMES**

Enquires: 021 932 038 Website: www.cambridgehomes.co.nz Drawn By: **JP Designs Ltd** 

SHEET TITLE

# Bracing Plan

Plan Type "Oakland"

## Cambridge Homes North Waikato

152 Rimu Street, Lakeside

 VERSION:
 REVISION:
 DATE:

 1.0
 Consent
 21/10/2023

 1.0
 Revision
 10/12/2023

LE:

1,189.5

Required

305.6

1:100 @A3

....

LS - 49

204

M

W:119.0

E:107.4

165,4,4165

M1/EPB1

M2/EPB1/0.


C3/EPB1/1.2


A3/EPB1/1.2



\* D003 Removed




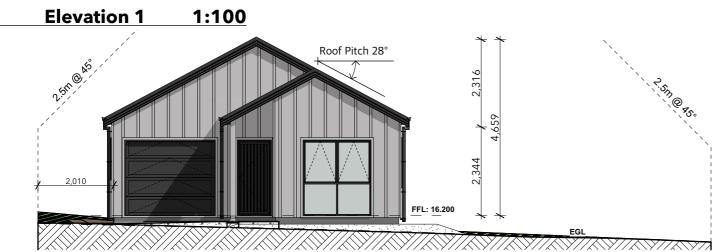

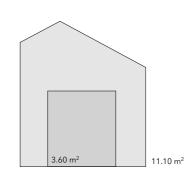

#### Front Glazing

Total front wall Area: Window Area: 11.10m<sup>2</sup> 3.60m<sup>2</sup>(32.43%)

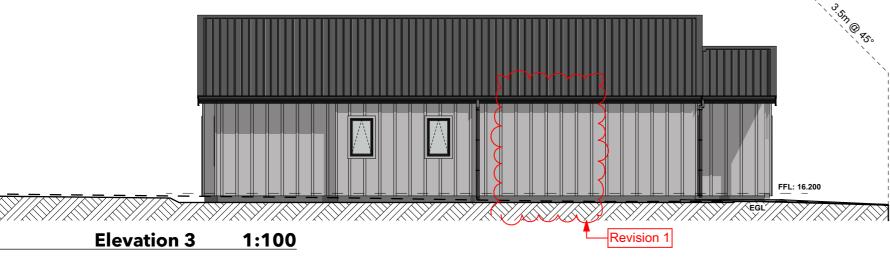



**Elevation 4** 1:100

**Elevation 2** 

1:100

Document Set ID: 4429100 Version: 1, Version Date: 14/12/2023 The Copyright of these plans shall remain with Cambridge Homes Waikato (North). Cambridge Homes Waikato (North) accepts no responsibility

Cambridge Homes Waikato (North) accepts no responsibility for any work undertaken that is not in strict accordance with these drawings.

All construction shall be in strict accordance with the New Zealand Building Code.

Contractor shall check and verify all dimensions, setouts, and levels on site, prior to commencing contract, and shall immediately notify Cambridge Homes Waikato (North) of any discrepancies or errors.



## **CAMBRIDGE HOMES**

Enquires: 021 932 038 Website: www.cambridgehomes.co.nz Drawn By: **JP Designs Ltd** 

SHEET TITLE

## Elevations

Plan Type "Oakland"

## Cambridge Homes North Waikato

IT:


152 Rimu Street, Lakeside


VERSION:	REVISION:	DATE:
1.0	Consent	21/10/2023
1.0	Revision	10/12/2023

1:100 @A3

OB NUMBER:

LS - 49 301

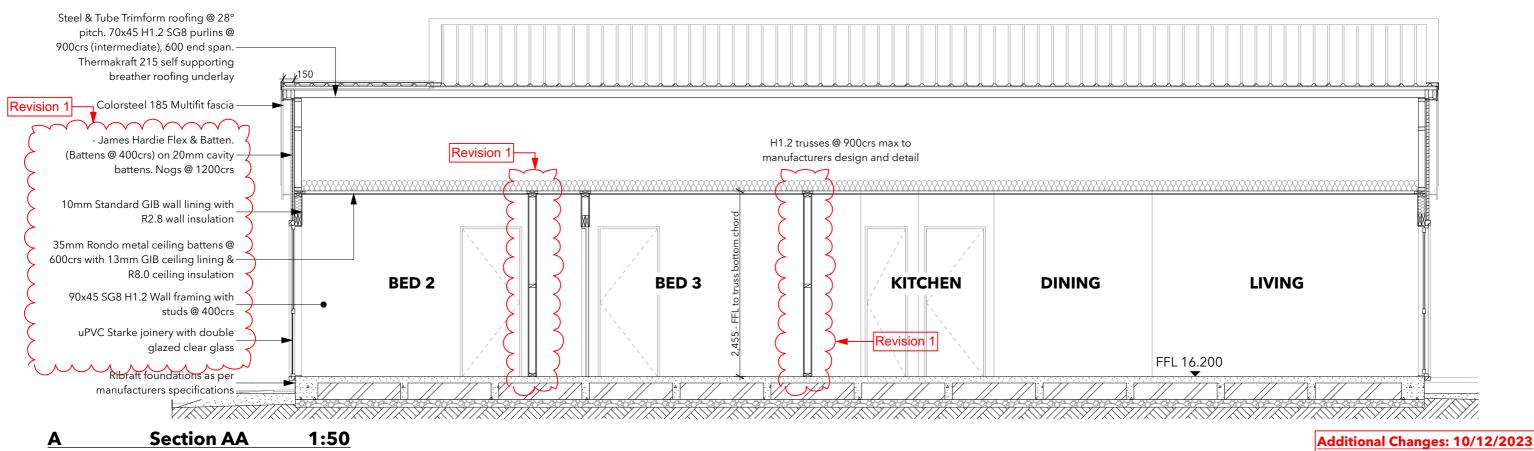

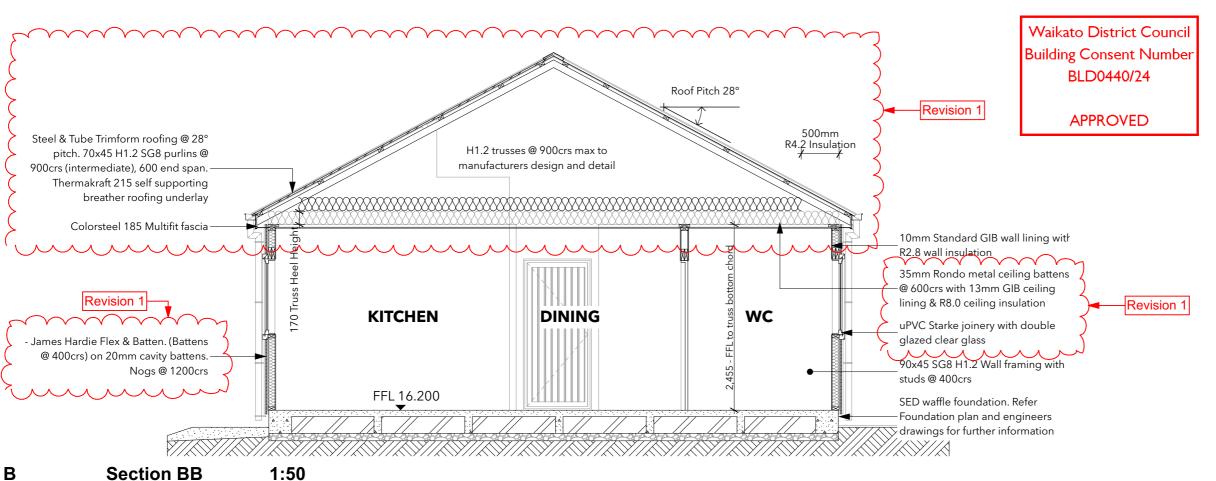

## \* No sector outino de collinar alcanara

- \* Nogs to entire dwelling changed to 1200crs
- \* R8 Ceiling insulation added
- \* uPVC joinery change
- \* Truss Heel height increased

The Copyright of these plans shall remain with Cambridge Homes Waikato (North).

Cambridge Homes Waikato (North) accepts no responsibility for any work undertaken that is not in strict accordance with these drawings.

All construction shall be in strict accordance with the New Zealand Building Code.

Zealand Building Code.

Contractor shall check and verify all dimensions, setouts, and levels on site, prior to commencing contract, and shall immediately notify Cambridge Homes Waikato (North) of any discrepancies or errors.

1:50 @A3

JOB NUMBER: SHEET:

LS - 49 401


**CAMBRIDGE HOMES** 

Enquires: 021 932 038 Website: www.cambridgehomes.co.nz Drawn By: **JP Designs Ltd**  Sections
Plan Type "Oakland"

Cambridge Homes North Waikato

152 Rimu Street, Lakeside

1.0 Consent 21/10/2023 1.0 Revision 10/12/2023

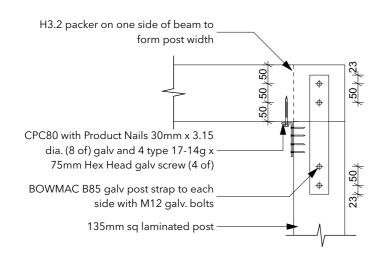


## **POST / BEAM DETAIL**

**SCALE 1:10** 

135mm sq laminated post 4 x 10mm Dia. 75mm long stainless steel coach screw 450mm sq x 900mm deep concrete footing 135mm sq laminated post 450mm sq x 900mm deep concrete footing

## **POST TO BASE DETAIL**

SCALE 1:10

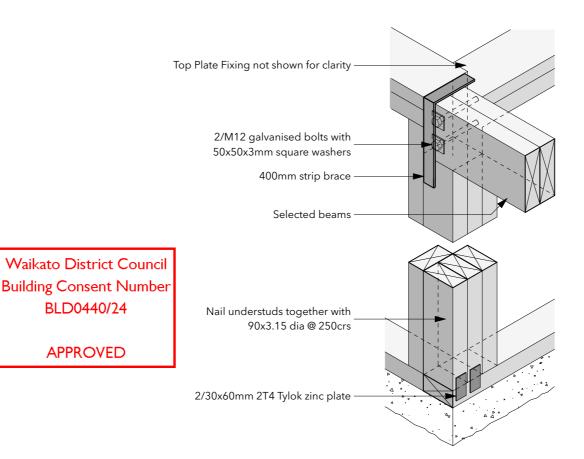

## **BEAM TO FRAME DETAIL**


**SCALE 1:10** 

#### Note:

BLD0440/24

**APPROVED** 

Use Raftmix or Raftmix Pump 20MPa concrete typically, or Raftmix25 or Raftmix Pump25 25MPa concrete in exposure zone 'D' Refer to Ribraft technical manual for further

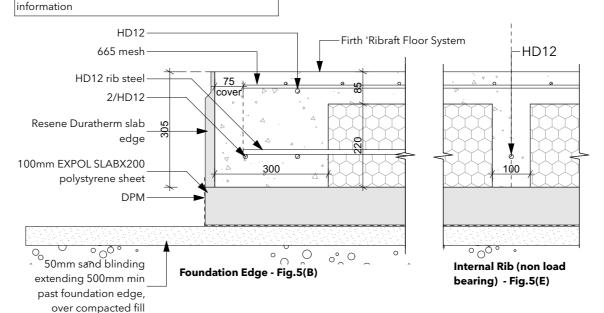

## FIRTH 'RIBRAFT' FOUNDATION ELEMENTS

SCALE 1:10

Waikato District Council **Full Application Received** 26/10/2023

> The Copyright of these plans shall remain with Cambridge Homes Waikato (North).

Cambridge Homes Waikato (North) accepts no responsibility for any work undertaken that is not in strict accordance with these drawings.

All construction shall be in strict accordance with the New Zealand Building Code.

Contractor shall check and verify all dimensions, setouts, and levels on site, prior to commencing contract, and shall immediately notify Cambridge Homes Waikato (North) of any discrepancies or errors



#### **CAMBRIDGE HOMES**

Enquires: 021 932 038 Website: www.cambridgehomes.co.nz Drawn By: JP Designs Ltd

# Post / Porch Details

Plan Type "Oakland"

# **Cambridge Homes North Waikato**


152 Rimu Street, Lakeside

Consent 21/10/2023

1:10 @A3


LS - 49


501

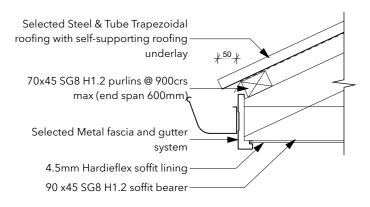


## **FASCIA DETAIL**

STEEL & TUBE - TRAPEZOIDAL SCALE: 1:10

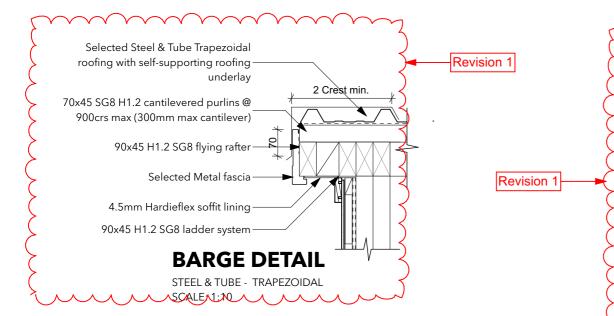


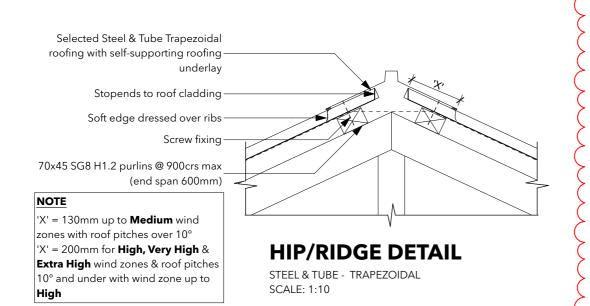

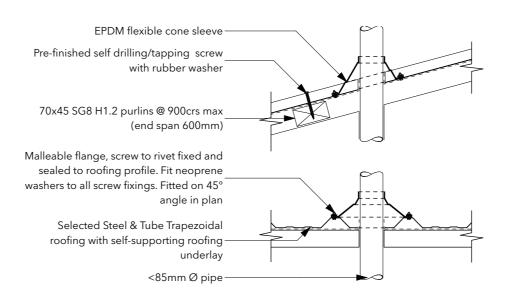

## <85mmØ PIPE PENETRATION DETAIL

STEEL & TUBE - TRAPEZOIDAL SCALE: 1:10

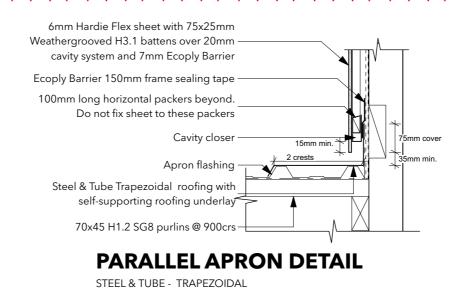

Scale: 1:10

6mm Hardie Flex sheet with 75x25mm Weathergrooved H3.1 battens over 20mm cavity system and 7mm Ecoply Barrier Ecoply Barrier 150mm frame sealing Flashing upstand behind Ecoply 90x45 Timber wall framing

\* Apron flashing with tapered

Selected Trapezoidal roofing on 70x45 purlins @ 900crs over Thermakraft roofing underlay

End of spouting must be 10mm min clear of cladding

When 50 year durability for \* flashing is required, refer to NZBC, E2/AS1 Table 20

## **3D APRON FLASHING**

HARDIE FLEX SHEET & BATTENS SCALE: 1:20

#### Additional Changes: 10/12/2023

\* 7mm Ecoply rigid air barrier Details updated

Waikato District Council **Building Consent Number** BLD0440/24

**APPROVED** 

The Copyright of these plans shall remain with Cambridge Homes Waikato (North)

Cambridge Homes Waikato (North) accepts no responsibility for any work undertaken that is not in strict accordance with these drawings.

All construction shall be in strict accordance with the New Zealand Building Code.

Contractor shall check and verify all dimensions, setouts, and levels on site, prior to commencing contract, and shall immediately notify Cambridge Homes Waikato (North) of any discrepancies or errors



#### **CAMBRIDGE HOMES**

Enquires: 021 932 038 Website: www.cambridgehomes.co.nz Drawn By: JP Designs Ltd

## **Roof Details**

Plan Type "Oakland"

## **Cambridge Homes North Waikato**


152 Rimu Street, Lakeside

1.0 Consent 21/10/2023 1.0 Revision 10/12/2023

1:10, 1:20 @A3


LS - 49

502

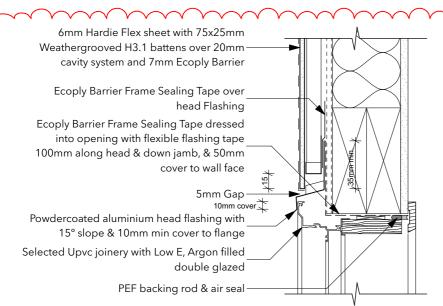


## **WINDOW HEAD DETAIL**

HARDIE FLEX SHEET & BATTENS SCALE 1:5

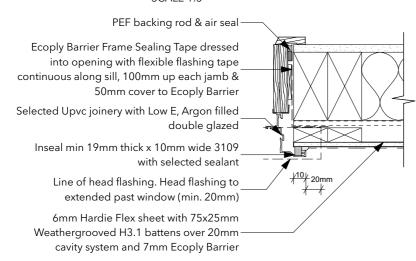

## **WINDOW JAMB DETAIL**

HARDIE FLEX SHEET & BATTENS SCALE 1:5

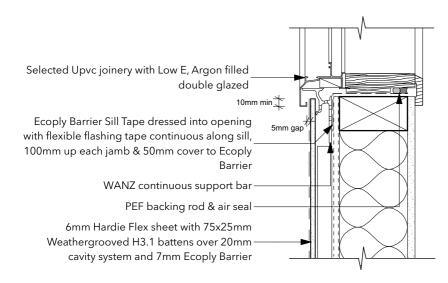

## **WINDOW SILL DETAIL**

HARDIE FLEX SHEET & BATTENS

6mm Hardie Flex sheet with 75x25mm
Weathergrooved H3.1 battens over 20mm cavity system and 7mm Ecoply Barrier
Ecoply Barrier Frame Sealing Tape over head Flashing
Ecoply Barrier Frame Sealing Tape dressed into opening with flexible flashing tape 100mm along head & down jamb, & 50mm cover to wall face uPVC cavity closer


5mm Gap
Powdercoated aluminium head flashing with 15° slope & 10mm min cover to flange

H3.1 Pre-primed garage door liner

PEF backing rod & air seal

## **GARAGE DOOR HEAD DETAIL**

HARDIE FLEX SHEET & BATTENS SCALE 1:5

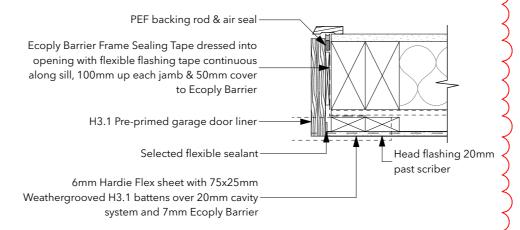

## **GARAGE DOOR JAMB DETAIL**

HARDIE FLEX SHEET & BATTENS SCALE 1:5

Waikato District Council Building Consent Number BLD0440/24

**APPROVED** 

#### Additional Changes: 10/12/2023

- \* 7mm Ecoply rigid air barrier
- \* Details updated

Revision 1

The Copyright of these plans shall remain with Cambridge Homes Waikato (North).

Cambridge Homes Waikato (North) accepts no responsibility for any work undertaken that is not in strict accordance with these drawings.

All construction shall be in strict accordance with the New Zealand Building Code.

Contractor shall check and verify all dimensions, setouts, and levels on site, prior to commencing contract, and shall immediately notify Cambridge Homes Waikato (North) of any discrepancies or errors.



#### **CAMBRIDGE HOMES**

Enquires: 021 932 038 Website: www.cambridgehomes.co.nz Drawn By: **JP Designs Ltd** 

SHEET TITLE:

## Joinery Details

Plan Type "Oakland"

PROPOSED NEW RESIDENCE FOR:

Cambridge Homes North Waikato

....

152 Rimu Street, Lakeside

 VERSION:
 REVISION:
 DATE:

 1.0
 Consent
 21/10/2023

 1.0
 Revision
 10/12/2023


SCALE:

1:5 @A3

B NUMBER:

LS - 49

503

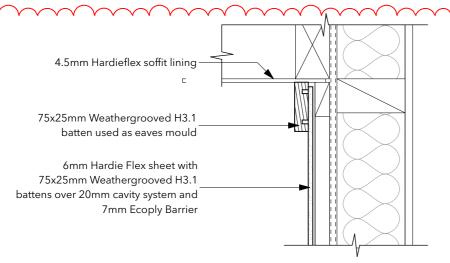

# 4.5mm Hardieflex soffit lining Selected Sealant 75x25mm Weathergrooved H3.1 batten used as eaves mould 6mm Hardie Flex sheet with 75x25mm Weathergrooved H3.1 battens over 20mm cavity system and 7mm Ecoply Barrier

## **BOTTOM RAKING SOFFIT DETAIL**

HARDIE FLEX SHEET & BATTENS SCALE 1:5

## **SOFFIT DETAIL**

HARDIE FLEX SHEET & BATTENS SCALE 1:5

Square of flexible flashing tape to a min of 100mm outside of pipe ensure seal with pipe bandage

Flexible flashing tape bandage min 25mm wide all round pipe


Pipe laid to 5° fall

Hardie Flex Sheet board carefully cut around pipe. Sealed with selected flexible sealant

6mm Hardie Flex sheet with 75x25mm Weathergrooved H3.1 battens over 20mm cavity system and 7mm Ecoply Barrier

## PIPE PENETRATION DETAIL

HARDIE FLEX SHEET & BATTENS SCALE 1:5

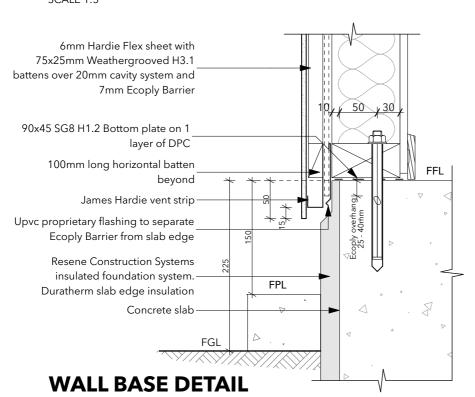

## Note:

Detail must be read in conjunction with Ecoply Structural Rigid Air Barrer specification & installation guide (Sep 2020). Technical maunal takes precedence over architectural details

> Waikato District Council Building Consent Number BLD0440/24

> > **APPROVED**

## Additional Changes: 10/12/2023

- \* 7mm Ecoply rigid air barrier
- \* Details updated

Revision 1

The Copyright of these plans shall remain with Cambridge Homes Waikato (North).

Cambridge Homes Waikato (North) accepts no responsibility for any work undertaken that is not in strict accordance with these drawings.

All construction shall be in strict accordance with the New Zealand Building Code.

Contractor shall check and verify all dimensions, setouts, and levels on site, prior to commencing contract, and shall immediately notify Cambridge Homes Waikato (North) of any discrepancies or errors.



#### **CAMBRIDGE HOMES**

Enquires: 021 932 038 Website: www.cambridgehomes.co.nz Drawn By: **JP Designs Ltd** 

SHEET TITLE

## Cladding Details

Plan Type "Oakland"

PROPOSED NEW RESIDENCE FOR

## Cambridge Homes North Waikato

....

152 Rimu Street, Lakeside


VERSION:	REVISION:	DATE:
1.0	Consent	21/10/2023
1.0	Revision	10/12/2023

SCALE:

1:5 @A3


OB NUMBER: **LS - 49** 

9 504

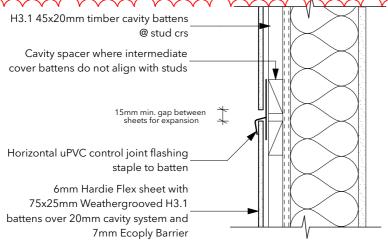


## **HORIZONTAL JOINT DETAIL**

HARDIE FLEX SHEET & BATTENS SCALE 1:5

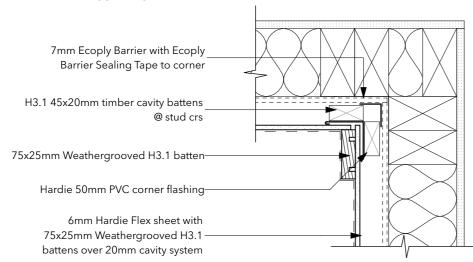

## **INTERNAL CORNER JUNCTION**

HARDIE FLEX SHEET & BATTENS SCALE 1:5

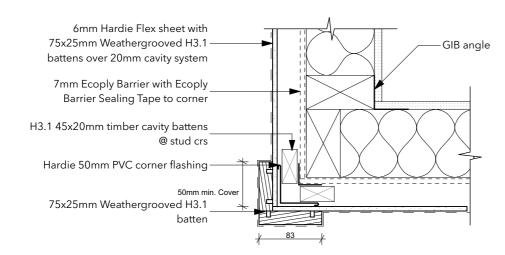

## **EXTERNAL CORNER JUNCTION**

HARDIE FLEX SHEET & BATTENS SCALE 1:5

## 90x45 H1.2 SG8 framing with 10mm GIB board wall lining 2mm min. Expansion gap 6mm Hardie Flex sheet with 75x25mm Weathergrooved H3.1 battens over 20mm cavity system and 7mm Ecoply Fixing as per specifications

## **VERTICAL JOINT DETAIL**

HARDIE FLEX SHEET & BATTENS SCALE 1:5

#### Note:

Detail must be read in conjunction with Ecoply Structural Rigid Air Barrer specification & installation guide (Sep 2020). Technical maunal takes precedence over architectural details

> Waikato District Council Building Consent Number BLD0440/24

> > **APPROVED**

Additional Changes: 10/12/2023 \* 7mm Ecoply rigid air barrier

- Details updated

Revision 1

The Copyright of these plans shall remain with Cambridge Homes Waikato (North).

Cambridge Homes Waikato (North) accepts no responsibility for any work undertaken that is not in strict accordance with these drawings.

All construction shall be in strict accordance with the New Zealand Building Code.

Contractor shall check and verify all dimensions, setouts, and levels on site, prior to commencing contract, and shall immediately notify Cambridge Homes Waikato (North) of any discrepancies or errors



#### **CAMBRIDGE HOMES**

Enquires: 021 932 038 Website: www.cambridgehomes.co.nz Drawn By: JP Designs Ltd

## Cladding Details

Plan Type "Oakland"


## **Cambridge Homes North Waikato**

152 Rimu Street, Lakeside

1.0 Consent 21/10/2023 10/12/2023 Revision

1:5 @A3

505 LS - 49

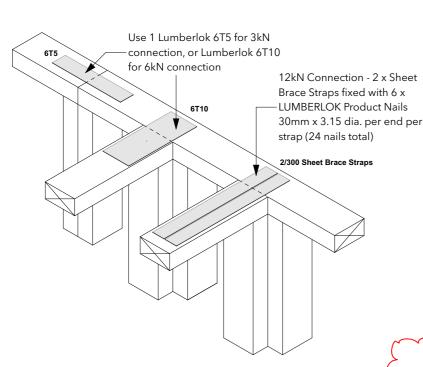

The top plate of a wall that contains one or more wall bracing elements shall be jointed according to the rating of the highest-rated individual wall bracing element as follows: A) Rating not exceeding 100 bracing units: a 3kN connection

as shown or by alternative fixing of 3kN capacity in tension or compression along plate;

B) Rating exceeding 100 bracing units: A 6kN connection as shown or by alternative fixing of 6kN capacity in tension or compression along plate.

Each internal wall that contains one or more bracing elements must be connected to external walls at right angles. Top plate fixing(s) of the capacity in tension or compression along the line of the wall bracing element are given as follows:


A) For each wall containing wall bracing elements with a total of not more than 125 BU's. Must be connected to one external wall by a fixing as shown in NZS 3604;2011 - figure 8.16 of 6Kn capacity

B) For each wall containing wall bracing elements with a total of not more than 250 BU's. Must be connected to two external wall by a fixing as shown in NZS 3604;2011 - figure 8.16 of 6Kn capacity

C) For each wall containing wall bracing elements with a total of more than 250 BU's. Must be connected to two external wall by a fixing as shown in NZS 3604;2011 - figure 8.16 each having a rating of not less than 2.4kN per 100 bracing units

## TOP PLATE JOINTING DETAIL

SCALE: 1:10

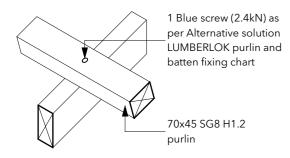

## **PURLIN FIXING** - UP TO VH WIND ZONE


LUMBERLOK FIXING TYPE C - 2.4kN SCALE: 1:10

2 x 90mm x 3.15 dia. plain steel wire nails driven vertically into stud

## STUD TO TOP PLATE FIXING

LUMBERLOK FIXING TYPE B - 4.7kN

SCALE: 1:10

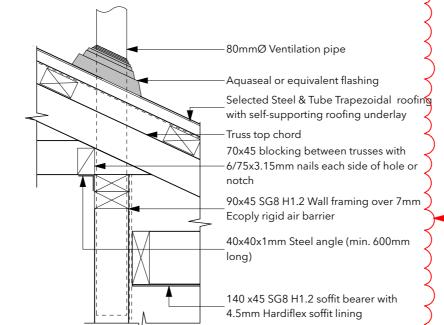

## TOP PLATE STRENGTHENING DETAIL

1 Blue screw (2.4kN) to either purlin


or rafter with 4 x 75mm nails

SCALE: 1:10

as per Alternative solution LUMBERLOK purlin and batten fixing chart Purlins shall be continuous over at least two spans, and may be butt jointed over supports provided that no two adjecent purlins shall be jointed over the same trussor rafter. 70x45 SG8 H1.2 purlin 90x35mm block fixed to truss chord

## **PURLIN SPLICE FIXING** - UP TO VH WIND ZONE

LUMBERLOK FIXING TYPE C - 2.4kN SCALE: 1:10

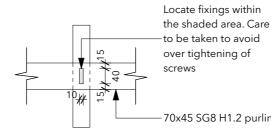

## **PURLIN FIXING TOLERANCE**

SCALE: 1:10

## Additional Changes: 10/12/2023

- \* 7mm Ecoply rigid air barrier
- Details updated

INTERNAL FRAME BOTTOM PLATE FIXING

75x8 powder actuated drive pin

and washer @ 600 crs max

Scale 1:10

Revision 1

Waikato District Council Building Consent Number BLD0440/24

**APPROVED** 

The Copyright of these plans shall remain with Cambridge Homes Waikato (North).

Cambridge Homes Waikato (North) accepts no responsibility for any work undertaken that is not in strict accordance with these drawings.

All construction shall be in strict accordance with the New Zealand Building Code.

Contractor shall check and verify all dimensions, setouts, and levels on site, prior to commencing contract, and shall immediately notify Cambridge Homes Waikato (North) of any discrepancies or errors



#### **CAMBRIDGE HOMES**

Enquires: 021 932 038 Website: www.cambridgehomes.co.nz Drawn By: JP Designs Ltd

## Fixing Details

Plan Type "Oakland"

## **Cambridge Homes North Waikato**

152 Rimu Street, Lakeside


1.0 Consent 21/10/2023 1.0 Revision 10/12/2023

1:10 @A3

LS - 49

506


Document Set ID: 4429100 Version: 1. Version Date: 14/12/2023 70x45 SG8 H1.2 purlin

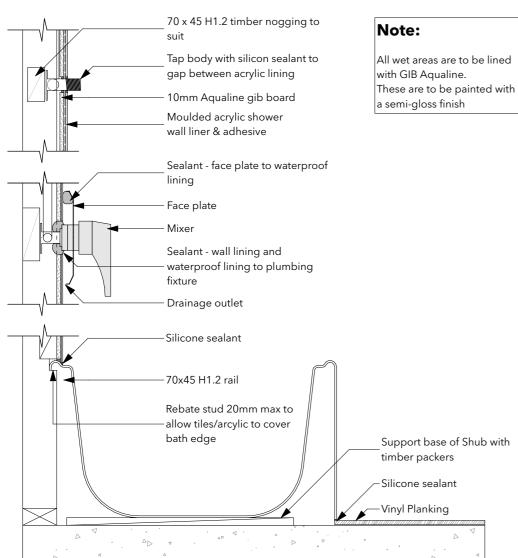

## **SHUB DETAIL**


Scale: 1:10

Straps shall be no more than 100mm from the top & base of the cylinder. Extra center strap for water heaters exceeding 200 litres

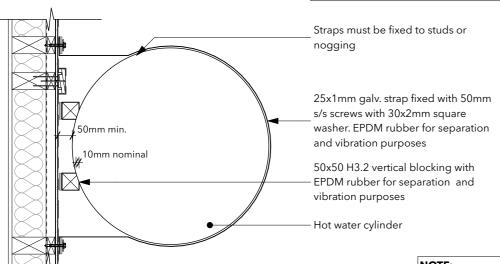

## **HOTWATER CYLINDER DETAIL**

SCALE: 1:10 Pipe lagging comply with H/AS1 section

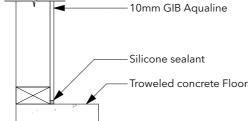

# 10mm GIB Aqualine Bullnose skirting Silicone sealant Vinyl Planking

## WALL/FLOOR DETAIL

SCALE 1:10

## WALL/FLOOR DETAIL

SCALE 1:10


#### Note:

The sealant to be used around the flooring is to be as per flooring specifications

"Hydrokit Water resistant sealing" The sealer between timber or laminate floor joints must be "Clicseal joint sealer"

Application recommendations are to be as per flooring specifications

> Waikato District Council **Full Application Received** 26/10/2023

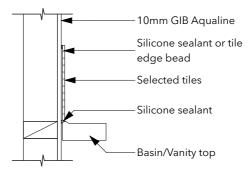

## **BASIN / VANITY DETAIL**

SCALE: 1:10

Waikato District Council **Building Consent Number** BLD0440/24

**APPROVED** 

The Copyright of these plans shall remain with Cambridge Homes Waikato (North).

Cambridge Homes Waikato (North) accepts no responsibility for any work undertaken that is not in strict accordance with these drawings.

All construction shall be in strict accordance with the New Zealand Building Code.

Contractor shall check and verify all dimensions, setouts, and levels on site, prior to commencing contract, and shall immediately notify Cambridge Homes Waikato (North) of any discrepancies or errors



#### **CAMBRIDGE HOMES**

Enquires: 021 932 038 Website: www.cambridgehomes.co.nz Drawn By: JP Designs Ltd



**Cambridge Homes North Waikato** 152 Rimu Street, Lakeside


Plan Type "Oakland"

Consent 21/10/2023

1:10 @A3 507 LS - 49


#### NOTE:

Refer EcoSpring installation and owners manual, Section 4 for connection schematic

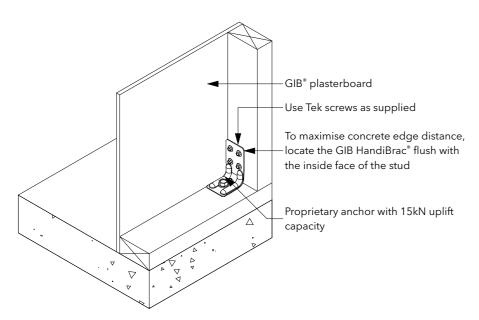


## **BRACING HOLD DOWN FIXING**

GIB HandiBrac® Concrete Floor - External Wall SCALE: 1:10

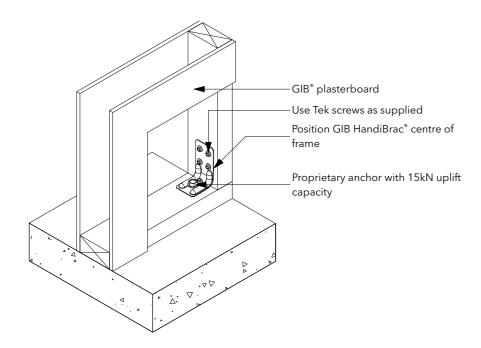

## **BRACING HOLD DOWN FIXING**

GIB HandiBrac® Concrete Floor - Internal Wall SCALE: 1:10

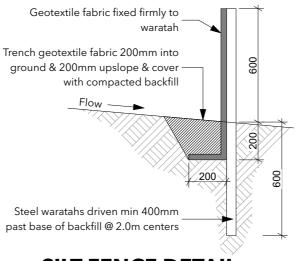

SILT FENCE DETAIL


SCALE 1:20

## Sediment Control Plan

- Earthworks and sediment control to be in accordance with the district plan & Waikato regional plan
- Install a Silt Fence and Contour Drain to positions indicated on plan, in accordance with Environment Waikato Technical Report No.2009/02; erosion & sediment control Guidelines for Soil Disturbing Activities
   Contour Drain shall be inspected daily,
- after each rainfall, and during prolonged rainfall
   Silt Fence shall be inspected weekly,
- after each rainfall, and during prolonged rainfall

 Any required maintenance of the Contour Drain or Silt Fence shall be undertaken as soon as practicable, and as priority work. Waikato District Council Building Consent Number BLD0440/24

**APPROVED** 

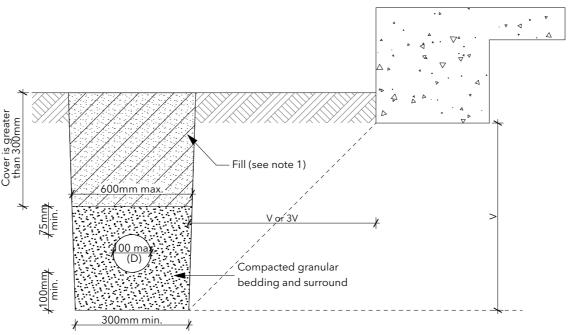

## **BEDDING & BACKFILL DETAIL**

(Cover greater than 375mm) Scale: 1:10

#### NOTE:

- 1. Fill shall be:
- Ordinary fill where drains are located below gardens and open country.
- Compacted selected fill where the drains are located below residential driveways and simllar areas subjected to light weight traffic
- 2. All drains to install before construction of dwelling slab
- 3. For both surface and foulwater drains in accordance with NZBC clause E1 and G13

Waikato District Council Full Application Received 26/10/2023

#### 5.6 Proximity of trench to building

5.6.1 For light timber framed and concrete masonry buildings constructed to NZS 3604 or NZS 4229 in accordance with B1/AS1 pipe trenches which are open for no longer than 48 hours shall be located no closer than V to the underside of any building foundation, as shown in Figure 8. Where the trench is to remain open for periods longer than 48 hours the minimum horizontal separation shall increase to 3V in all ground except rock.

The Copyright of these plans shall remain with Cambridge Homes Waikato (North).

Cambridge Homes Waikato (North) accepts no responsibility for any work undertaken that is not in strict accordance with these drawings.

All construction shall be in strict accordance with the New Zealand Building Code.

Contractor shall check and verify all dimensions, setouts, and levels on site, prior to commencing contract, and shall immediately notify Cambridge Homes Waikato (North) of any discrepancies or errors.



#### **CAMBRIDGE HOMES**

Enquires: 021 932 038 Website: www.cambridgehomes.co.nz Drawn By: **JP Designs Ltd** 

HEET TITLE:

# Bracing & Site Details

Plan Type "Oakland"

TROTOSED NEW RESIDENCE IN

## Cambridge Homes North Waikato

152 Rimu Street, Lakeside

152 Rimu Street, Lakeside

version: revision: DATE:


1.0 Consent 21/10/2023


LE:


1:10, 1:20 @A3


LS - 49


508

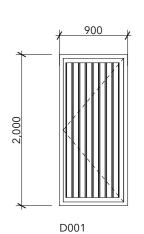


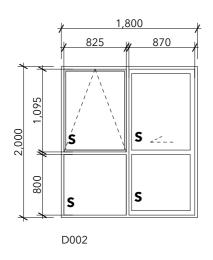


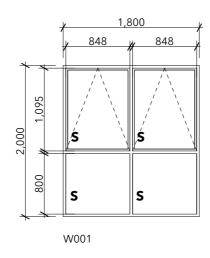


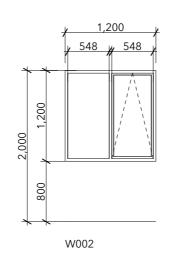

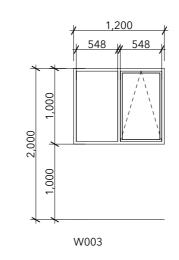

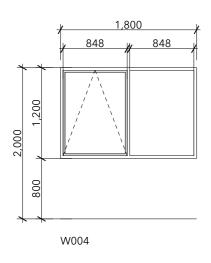

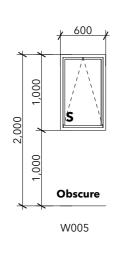

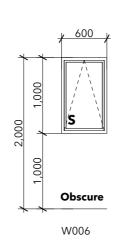

Waikato District Council **Building Consent Number** BLD0440/24

**APPROVED** 

#### Note:

- Check & confirm with elevations & window manufacturers schedule for window configuration

#### S = Safety Glass

Document Set ID: 4429100 Version: 1, Version Date: 14/12/2023 The Copyright of these plans shall remain with Cambridge

Additional Changes: 10/12/2023

D003 Removed

Homes Waikato (North). Cambridge Homes Waikato (North) accepts no responsibility for any work undertaken that is not in strict accordance with these drawings.

All construction shall be in strict accordance with the New Zealand Building Code.

Contractor shall check and verify all dimensions, setouts, and levels on site, prior to commencing contract, and shall immediately notify Cambridge Homes Waikato (North) of any discrepancies or errors.



## **CAMBRIDGE HOMES**

Enquires: 021 932 038 Website: www.cambridgehomes.co.nz Drawn By: JP Designs Ltd

## Window / Door Schedule

Plan Type "Oakland"

**Cambridge Homes North Waikato** 

152 Rimu Street, Lakeside

1.0 Consent 21/10/2023

1.0 10/12/2023 Revision

1:50 @A3

LS - 49


601

Waikato District Council Full Application Received 26/10/2023

#### Note

Rangehood is a Comfee Canopy with an airflow rate of  $430 \, \text{m}^3/\text{hr}$ . Refer specifications for further information.

Extractor Fans are Simx Multi vent Continuous with an airflow rate of  $572\,\mathrm{m}^3$ 

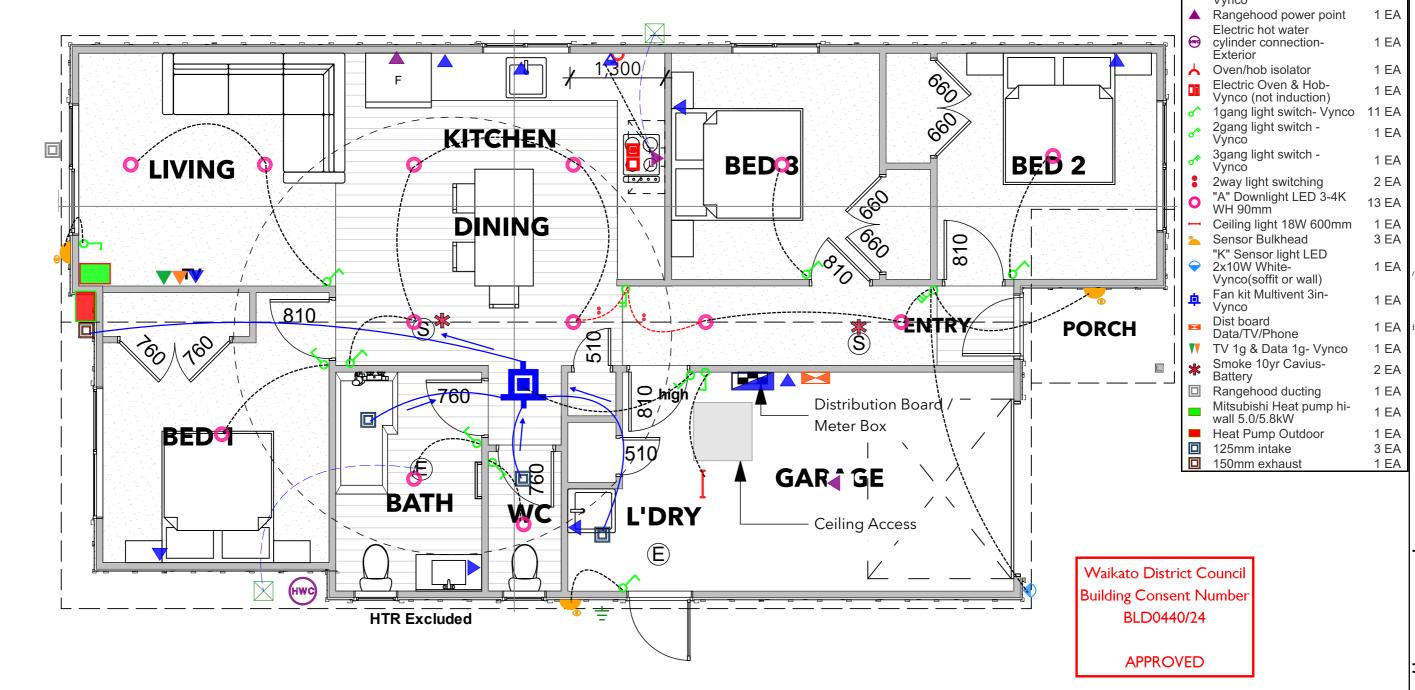

Note:

- Exact position of all lights, power outlets and switch locations to be discussed on site between client and electrician



Name Oakland

**Date** 31/07/23 **Quote** 30401



**Electrical Items** 

Vynco

deep- Jumbo Main Earth & Bonding

extra switch for

Meter dist board 24way

Double power point-

Rangehood- Vynco Single power point -

Double power point with

1 EA

1 EA

9 EA

1 EA

2 EA