Proposed New Dwelling for:

Callavate

At: 25 Raranga Road, Te Kauwhata

Lot: 712 DP: 571030


Sheet Index				
No.	Layout Name	Issue	Issue Date	
100	Cover Page	ENG	04/08/2025	
101	Site Plan	ENG	04/08/2025	
201	Floor Plan	ENG	04/08/2025	
202	Floor Plan Dimensions	ENG	04/08/2025	
203	Foundation Plan	ENG	04/08/2025	
204	Roof Framing Plan	ENG	04/08/2025	
206	Bracing Plan	ENG	04/08/2025	
301	Elevations	ENG	04/08/2025	
302	Elevations	ENG	04/08/2025	
401	Section A & B	ENG	04/08/2025	
402	Section C & D	ENG	04/08/2025	
403	Section E & F1	ENG	04/08/2025	
404	Section F2 & G	ENG	04/08/2025	



Scope of Work:

Proposed New Single Storey Dwelling:

- 3 Bedrooms
- 2 Bathrooms
- Open Plan Kitchen, Dining, Living
- Internal Access Garage
- Colorsteel Trimrib roofing by Roofing Industries
- Colorsteel Trimrib vertical wall cladding by Roofing Industries on 20mm H3.1 Hermpac Vertibat cavity batten system
- Hermpac 18.5mm vertical cedar shiplap weatherboard on 20mm H3.1 Hermpac Vertibat cavity batten system

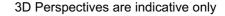



Plans must be read in conjunction with:

- Engineering Assessment and Design Report by Titus Civil Consulting Engineers (ref. 15339)
- Structural Design & Calculations by Titus Civil Consulting Engineers (ref. ?????)
- Buildable Truss Layout by Wecks ITM (ref. #200-3 Truss Reference)
- Topographical Survey Plan by Pilbrow Surveying Limited (dated 12 February 2024)



403 Waerenga Road, RD1, Te Kauwhata Sheena Young | Phone: 027 497 8860 Email: sheena@callavate.co.nz Plans Drawn By: **DRAFTING WAIKATO LTD**.



The Copyright of these plans shall remain with Drafting Waikato Ltd. Drafting Waikato Ltd accepts no responsibility for any work undertaken that is not in strict accordance with these drawings. Do not scale of plans, use factored dimensions only. All construction shall be in strict accordance with the New Zealand Building Code. Contractor shall check and verify all dimensions, setouts, and levels on site, prior to commencing contract, and shall immediately notify Drafting Waikato Ltd of any discrepancies or errors. No claims will be recognised if Drafting Waikato Ltd is not alerted to any discrepancy or error immediately.

Version:

ENG

ublish Date:

4/08/2025


Reference:

Shoot:

100

25-028

Plans for Engineer Design only, not to be used for Resource Consent or Building Consent

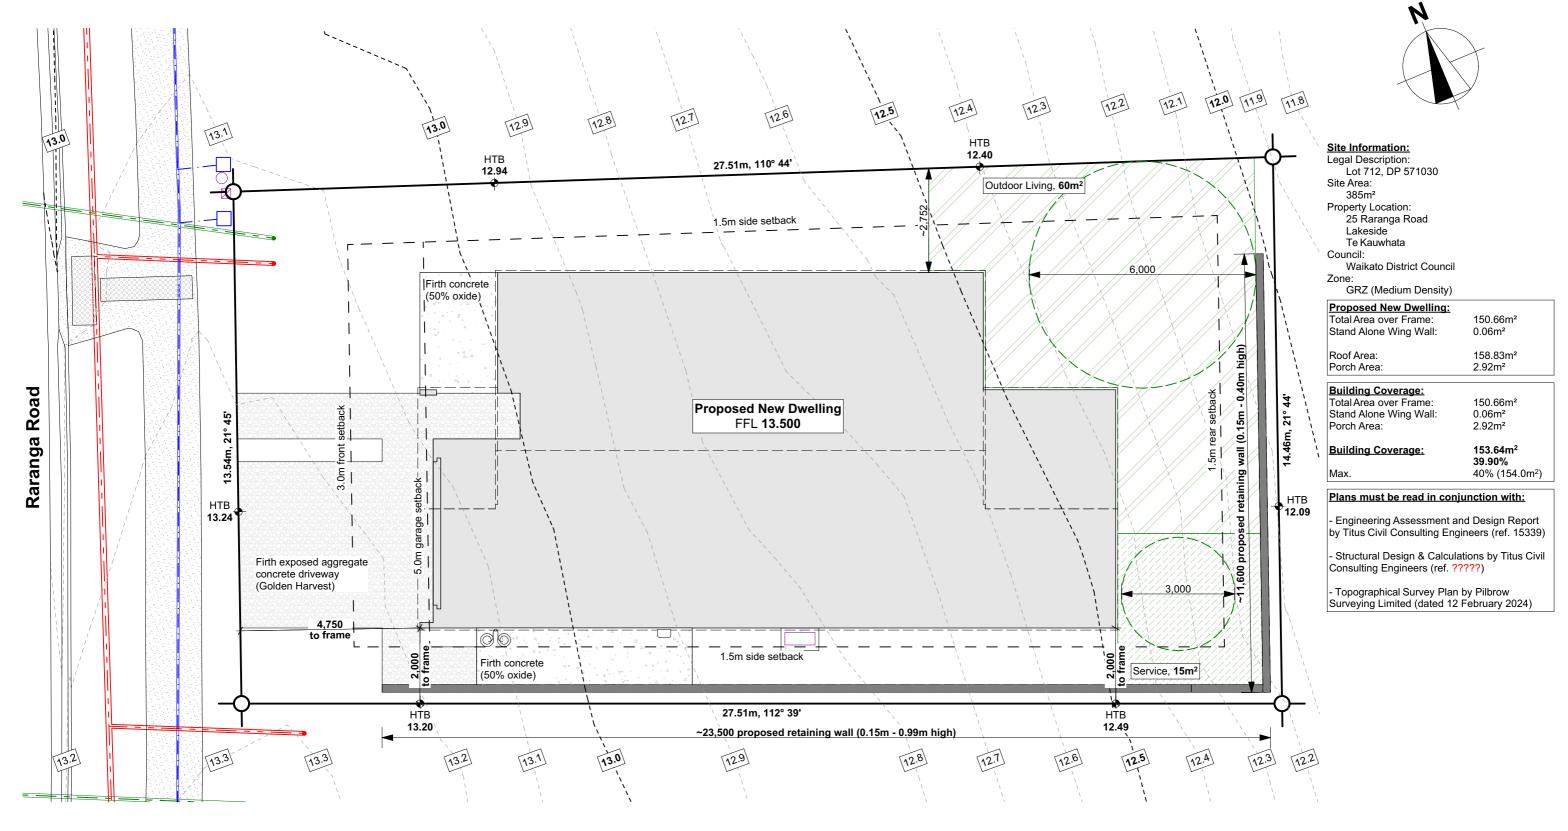

$C\Lambda LL\Lambda V\Lambda TE$ elevating new beginnings

403 Waerenga Road, RD1, Te Kauwhata Sheena Young | Phone: 027 497 8860 Email: sheena@callavate.co.nz
Plans Drawn By: **DRAFTING WAIKATO LTD.**

DRAFTING WAIKATO Ltd New Homes | Additions & Alterations

www.draftingwaikato.co.nz

ingwaikato.co.nz

Jeff Cunningham 027 484 2212

Plans for Engineer Design only, not to be used for Resource Consent or Building Consent

The Copyright of these plans shall remain with Drafting Waikato Ltd.

Drafting Waikato Ltd accepts no responsibility for any work undertaken that is not in strict accordance with these drawings.

Do not scale of plans, use factored dimensions only. All construction shall be in strict accordance with the New Zealand Building Code.

Contractor shall check and verify all dimensions, setouts, and levels on site, prior to commencing contract, and shall immediately notify Drafting Waikato Ltd of any discrepancies or errors.

No claims will be recognised if Drafting Waikato Ltd is not alerted to any discrepancy or error immediately.

Proposed New Dwelling for: Callavate At: Lot 712, 25 Raranga Road, Lakeside, Te Kauwhata

Site Plan	

ersion:	Wind Zone:	Snow Loading:
ENG	High	N0
ublish Date:	Earthquake Zone:	Exposure Zone
4/08/2025	1	В

Scale:	Drawn By:
1:100	DW
@ A3 Reference:	Sheet:
25-028	101
25-028	101

Wall Framing - General:

- All wall framing SG8 H1.2 unless specified
- All top plates shall be 2/90x45 continuous unless specified otherwise
- 2 rows of nogs for stud heights up to 3.6m for internal walls, refer to Cladding Systems for external wall nog crs

Wall Framing - Single Storey Walls: Load bearing external walls:

Up to 2.4m stud: 90x45 studs @ 600crs >2.4m - 3.0m stud: 2/90x45 studs @ 600crs >3.0m - 3.6m stud: 2/90x45 studs @ 300crs Load bearing internal walls:

Up to 3.0m stud: 90x45 studs @ 600crs >3.0m - 3.6m stud: 2/90x45 studs @ 600crs Non load bearing internal walls:

90x45 studs @ 600crs Up to 3.0m stud:

Wall Cladding:

Wall Cladding Systems:

- Colorsteel Trimrib vertical wall cladding by Roofing Industries on 20mm H3.1 Hermpac Vertibat cavity batten system, with nogs evenly spaced @ 1200crs max, 2 rows minimum)

- Hermpac 18.5mm vertical cedar shiplap weatherboard on 20mm H3.1 Hermpac Vertibat cavity batten system, with nogs evenly spaced @ 480crs max.

Air Barrier:

- Thermakraft Watergate Plus building wrap Exterior Joinery:

- All dimensions are given as trim sizes (W x H)
- Site measure all openings prior to joinery manufacture
- Head heights = 2,165mm unless specifically noted otherwise - ThermalHEART powdercoated aluminium
- thermally broken joinery
- 19mm H3.1 timber liners
- 60x10 single bevel architraves
- All bathroom & WC windows, & all windows with sills >1000mm from adjacent ground level shall have restrictor stays Glazina:
- Install glazing in accordance with NZS 4223

Type of Glazing Double pane Thermally improved Spacer Type IGU Glass: Low E₃/Clear Gas: Argon Frame Thermally broken Aluminium Frame R Value = R0.46

- Clear double glazing generally (R0.46)
- Obscure glazing to all bathrooms & WC's
- Safety glass to locations shown on Door & Window Schedule (ref. sheet 701) in accordance with Table 1. NZS 4223.3:2016
- all shower screens/doors, shall be safety glass in sanitary fixtures and sanitary appliances accordance with NZS 4223.3:2016 (ref. Table A4) Interior Joinery:
- All balustrade screens shall be safety glass in accordance with NZS 4223.3:2016

Insulation:

Walls - General:

- 90mm R2.8 Pink Batts Ultra wall insulation to walls (including garage)
- Ceilings General
- 225mm R5.0 Pink Batts Superbatts ceiling insulation to ceiling (including garage)
- Ceilings Perimeter: 180mm R3.6 Pink Batts Classic ceiling insulation to ceiling perimeter (≤460mm wide) to ceiling (including garage) where space <275mm **Garage Door Insulation:**
- 35mm R0.85 35mm Expol Garage Door Insulation Kit for flat panel garage doors

Linings:

Walls - General:

- 10mm Standard GIB lining to walls
- 10mm GIB Aqualine lining to wet area walls Walls - Tiled:
- 10mm GIB Aqualine lining to tiled walls (tile weighs less than 26kg/m²)
- weighs up to 40kg/m²) Ceilings - General:
- 70x35 SG8 H1.2 ceiling battens @ 600crs max.
- · 13mm Standard GIB lining to ceilings
- 13mm GIB Aqualine lining to wet area ceilings General:

Smoke Alarms:

- = Smoke Alarm (Interconnected)
- Type 1 domestic smoke alarm system shall be in accordance with NZS 4514
- Smoke alarms may be wired-in or wireless with a long-life (minimum 10 years), non-removable, sealed battery

Mechanical Ventilation:

(E) = Extractor Fan

RH = Rangehood

- Shall be in accordance with NZBC clause
- G4/AS1, section 1.2.5
- Mechanical extract fans must have a flowrate not less than 25 L/s for showers and baths & 50 I /s for cooktops

Lighting:

- All downlights shall be CA rated, refer to specification.

Food Preparation Surfaces:

- All food preparation surfaces shall
- comply with NZBC clause G3/AS1, section 1.1.3 Floor Surfaces:
- All floor surfaces on accessible routes & any vinyl or tiled surface shall comply with NZBC clause D1/AS1, section 2.1, such that they shall have a coefficient of friction μ , of not less than 0.4 when tested in accordance with AS/NZS 3661.1.
- Spaces containing sanitary fixtures or sanitary appliances shall have floor finishes that comply with NZBC E3/AS1, section 3.1, in open plan - All glazing within 2000mm of FFL in wet areas, & spaces this surface shall extend 1.5m from all
 - Door panels shall be standard 1980mm high, unless specifically noted otherwise, & panel widths are as shown on Floor Plans
 - 60x10 single bevel architraves


Hot Water:

- Rinnai A26 Gas Infinity

Proposed New Dwelling for:

- All hot water pipes shall be insulated with 13-25mm thick closed cell elastomeric thermal lagging

- 13mm GIB Aqualine lining to tiled walls (tiles

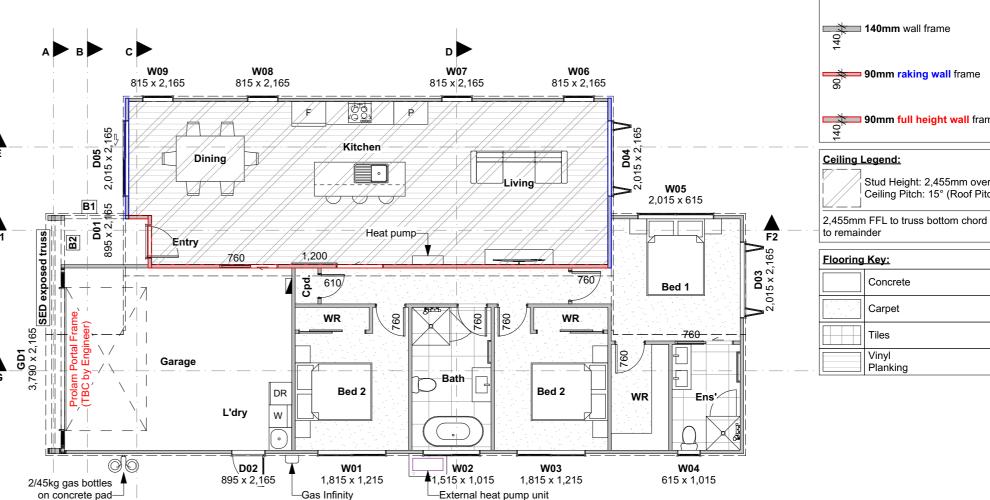

Bathroom:

Standard WC

Towel rail

1600 free standing bath

900 single basin vanity

1000x1000 tiled shower, recessed



403 Waerenga Road, RD1, Te Kauwhata Sheena Young | Phone: 027 497 8860 Fmail: sheena@callavate.co.nz Plans Drawn By: **DRAFTING WAIKATO LTD.**



Jeff Cunningham

027 484 2212 ngwaikato.co.nz www.draftingwaikato.co.nz



Plans for Engineer Design only, not to be used for Resource Consent or Building Consent

The Copyright of these plans shall remain with Drafting Waikato Ltd. Drafting Waikato Ltd accepts no responsibility for any work undertaken that is not in strict accordance with these drawings

Do not scale of plans, use factored dimensions only. All construction shall be in strict accordance with the New Zealand Building Code.

Contractor shall check and verify all dimensions, setouts, and levels on site, prior to commencing contract, and shall immediately notify Drafting Waikato Ltd of any discrepancies or errors. No claims will be recognised if Drafting Waikato Ltd is not alerted to any discrepancy or error immediately

with safety chains

Callavate ^t Lot 712, 25 Raranga Road, Lakeside, Te Kauwhata

Floor Plan

ENG Publish Date 4/08/2025 Wind Zone: Snow Loading High N0 Earthquake Zone Exposure Zone

Ensuite:

Towel rail

Standard WC

900x900 tiled shower, recessed

1200 double basin vanity

Elevations

Proposed New Dwelling:

Total Area over Frame:

Stand Alone Wing Wall

Wall Framing Legend:

Wall Framing - Single Storey Walls

90mm raking wall frame

■ 90mm full height wall frame

Stud Height: 2,455mm over plates

Ceiling Pitch: 15° (Roof Pitch 30°)

90mm wall frame

Concrete

Carpet

Tiles

Vinvl

Planking

Roof Area:

Porch Area

150.66m²


158.83m²

2.92m²

0.06m²

1:100 Reference: 25-028

Drawn By: DW @ A3 Sheet 201

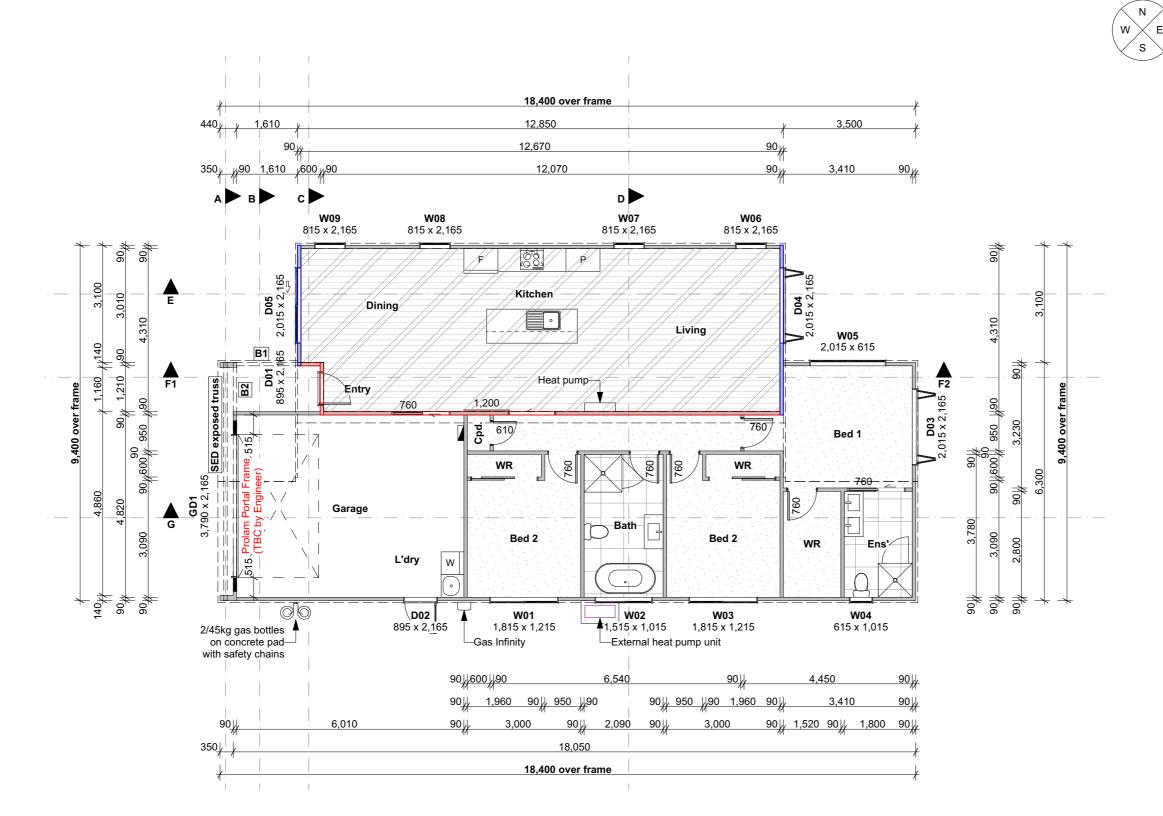

Proposed New Dwelling:

Total Area over Frame: Stand Alone Wing Wall:

0.06m² 158.83m² Roof Area:

150.66m²


2.92m²

Porch Area:

to remainder

Elevations

Beam Key: B1: #6-1 B1 Beam

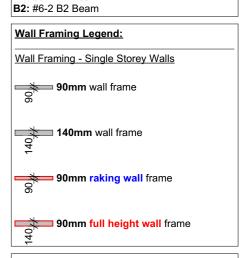



Flooring Key:				
	Concrete			
	Carpet			
	Tiles			
	Vinyl Planking			

$C\Lambda LL\Lambda V\Lambda TE$

403 Waerenga Road, RD1, Te Kauwhata Sheena Young | Phone: 027 497 8860 Email: sheena@callavate.co.nz
Plans Drawn By: DRAFTING WAIKATO LTD.

DRAFTING WAIKATO Ltd New Homes | Additions & Alterations

www.draftingwaikato.co.nz

Jeff Cunningham

027 484 2212

Plans for Engineer Design only, not to be used for Resource Consent or Building Consent

The Copyright of these plans shall remain with Drafting Waikato Ltd.

Drafting Waikato Ltd accepts no responsibility for any work undertaken that is not in strict accordance with these drawings.

Do not scale of plans, use factored dimensions only. All construction shall be in strict accordance with the New Zealand Building Code.

Contractor shall check and verify all dimensions, setouts, and levels on site, prior to commencing contract, and shall immediately notify Drafting Waikato Ltd of any discrepancies or errors. No claims will be recognised if Drafting Waikato Ltd is not alerted to any discrepancy or error immediately.

Proposed New Dwelling for: Callavate


^{t:}Lot 712, 25 Raranga Road, Lakeside, Te Kauwhata

Floor Plan Dimensions

ENG Publish Date 4/08/2025

Wind Zone: Snow Loading: High N0 Earthquake Zone Exposure Zone

1:100 DW @ A3 Sheet: 25-028 202

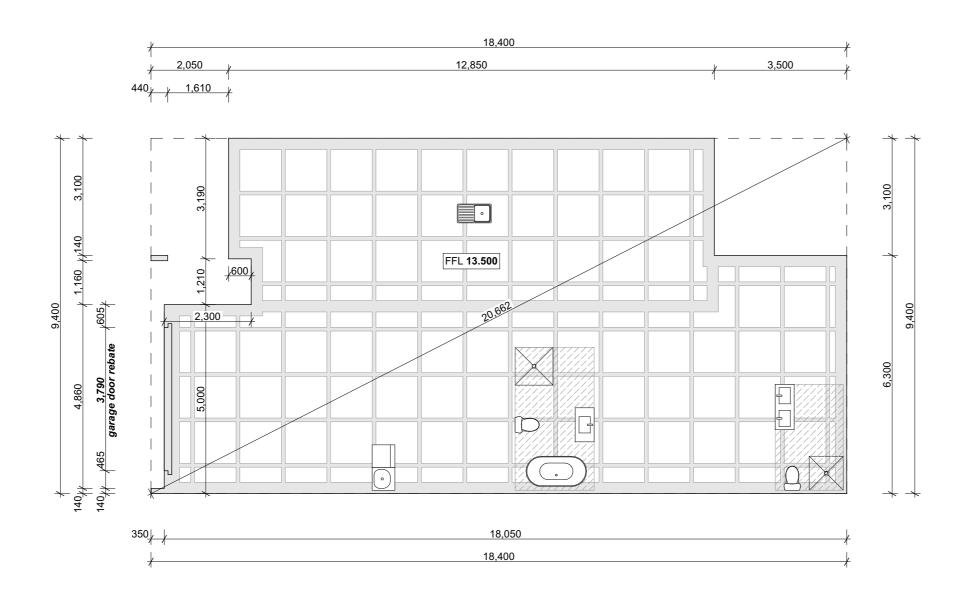



403 Waerenga Road, RD1, Te Kauwhata Sheena Young | Phone: 027 497 8860 Email: sheena@callavate.co.nz
Plans Drawn By: **DRAFTING WAIKATO LTD.**

DRAFTING WAIKATO Ltd

www.draftingwaikato.co.nz

Jeff Cunningham

027 484 2212

New Homes | Additions & Alterations

Plans for Engineer Design only, not to be used for Resource Consent or Building Consent

The Copyright of these plans shall remain with Drafting Waikato Ltd.

Drafting Waikato Ltd accepts no responsibility for any work undertaken that is not in strict accordance with these drawings.

Do not scale of plans, use factored dimensions only. All construction shall be in strict accordance with the New Zealand Building Code.

Contractor shall check and verify all dimensions, setouts, and levels on site, prior to commencing contract, and shall immediately notify Drafting Waikato Ltd of any discrepancies or errors.

No claims will be recognised if Drafting Waikato Ltd is not alerted to any discrepancy or error immediately.

Proposed New Dwelling for:

Callavate At: Lot 712, 25 Raranga Road, Lakeside, Te Kauwhata

Foundation Plan

ENG Publish Date: 4/08/2025

Wind Zone: High N0 1:100 @ A3 Earthquake Zone Exposure Zone Reference:

Plans must be read in conjunction with:

- Engineering Assessment and Design Report by Titus Civil Consulting Engineers (ref. 15339)
- Structural Design & Calculations by Titus Civil Consulting Engineers (ref. ?????)
- Buildable Truss Layout by Wecks ITM (ref. #200-3 Truss Reference)

Note:

Selected DPC:

- Selected DPM: - Thermakraft Thermathene Black 250um
- Thermakraft Supercourse 500 DPC
- Selected DPC separation layer required between all concrete & timber


- All dimensions are to slab edge unless specified otherwise
- Design criteria for ground conditions to be confirmed prior to construction
- Ground preparation shall be undertaken in accordance with site specific geotechnical report recommendations
- All construction shall be in strict accordance with the New Zealand Building Code
- Contractor <u>must</u> check and verify all dimensions, setouts, and levels on site, prior to commencing contract, and shall immediately notify Drafting Waikato Ltd of any discrepancies
- No claims will be recognised if Drafting Waikato Ltd is not alerted to any discrepancy or error immediately

25-028

DW

203

Sheet:

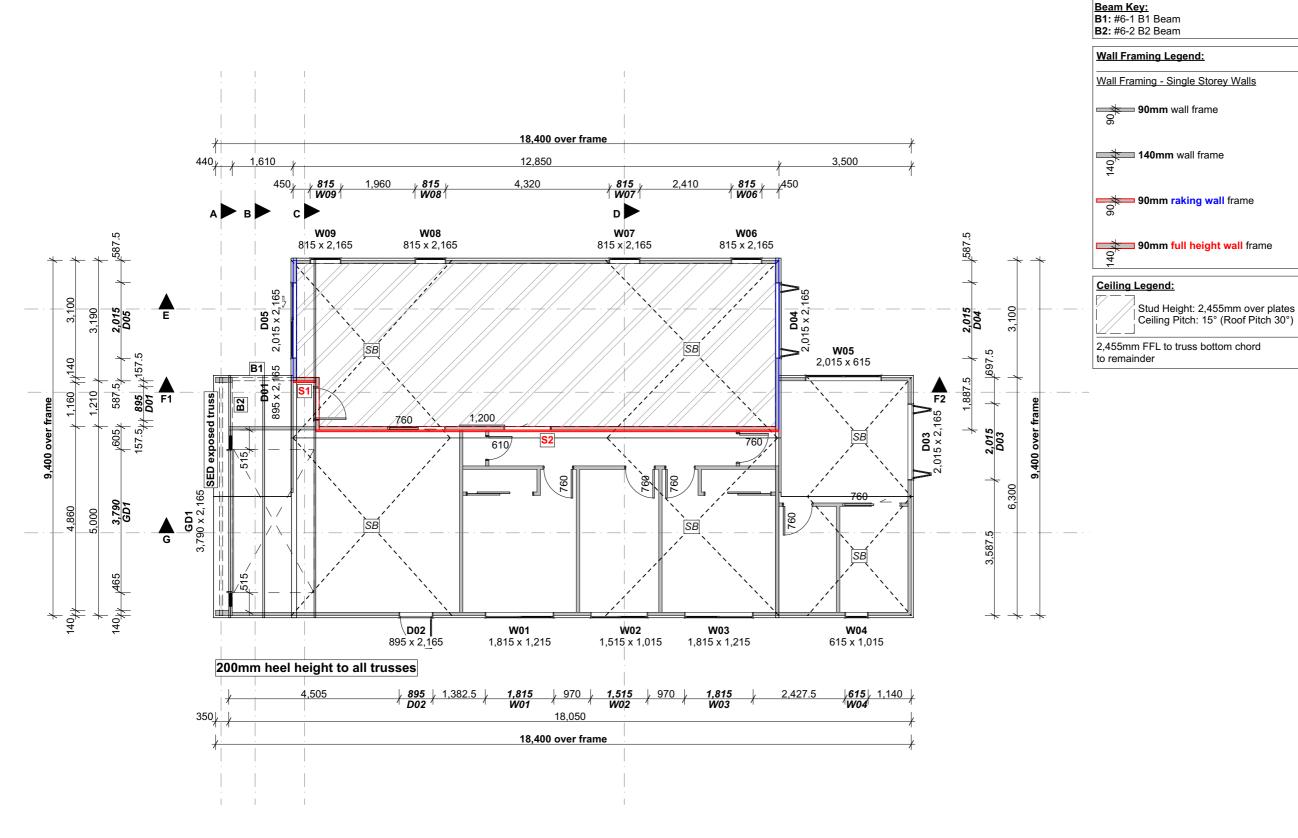

· Structural Design & Calculations by Titus Civil Consulting Engineers (ref. ?????)

Buildable Truss Layout by Wecks ITM (ref. #200-3 Truss Reference)

Roof Framing:

- Refer to Buildable Truss Layout by Wecks ITM (ref. #200-3 Truss Reference) for truss fixing & location

Purlins: 70x45 SG8 H1.2, typical

- Intermediate Spacings: 900crs max.

- End Spacings: 600crs max.

MiTek - Cantilever Purlins:

- 70x45 SG8 H1.2 cantilever purlins @ 900crs max. (End Spacings: 600crs max.)

= 300mm max. cantilever

Note: Cantilever purlins to extend over at least 3 supports and be fixed in accordance with MiTek Structural Fixings On-Site Guide

Stringer Key & Fixing:

Fixing: ???

S2: ???

Fixing: ???

Fixing Type K - 3.93kN = 2/90x3.15 dia. nails + 1 BOWMAC StudLok

SL125 (Green) @ stud crs (600crs max.) Min. stringer size 90x45 SG8 H1.2

- Refer Sheet ??? for MiTek StudLok Stringer to Stud Fixing

- Stringer size & fixing as per MiTek Studlok Stringer to Stud Fixing Schedule (2024)

Roof Bracing:



Pair of Lumberlok Strip Brace fixed in accordance with MiTek Structural Fixings On-Site Guide 2024

Top Plate Fixings:

- Top plate fixing as per alternative fixing from Lumberlok or Bowmac

All top plate fixings = **Stud-Lok SL**

- Refer Sheet ??? for Stud to Top Plate Fixing

Jack Stud to Top Plate Fixings:

- Jack stud to top plate & lintel fixing as per alternative fixing from Lumberlok or Bowmac
- Refer Sheet ??? for Jack Stud to Top Plate & Lintel Fixing

Lintel Fixings:

- Lintel fixing as per alternative fixing from Lumberlok

Type 'E' - 1.4kN = As per figure 8.12 **Type 'F' - 4.0kN** = As per figure 8.12

Type 'G' - 7.5kN = As per figure 8.12 **Type 'H' - 13.5kN** = As per figure 8.12

- Refer Sheet ??? for Lintel Fixing Details

$C\Lambda LL\Lambda V\Lambda TE$

403 Waerenga Road, RD1, Te Kauwhata Sheena Young | Phone: 027 497 8860 Email: sheena@callavate.co.nz Plans Drawn By: **DRAFTING WAIKATO LTD**.

DRAFTING WAIKATO Ltd

www.draftingwaikato.co.nz

Jeff Cunningham

027 484 2212

New Homes | Additions & Alterations

ngwaikato.co.nz

Plans for Engineer Design only, not to be used for Resource Consent or Building Consent

The Copyright of these plans shall remain with Drafting Waikato Ltd.

Drafting Waikato Ltd accepts no responsibility for any work undertaken that is not in strict accordance with these drawings

Do not scale of plans, use factored dimensions only. All construction shall be in strict accordance with the New Zealand Building Code.

Contractor shall check and verify all dimensions, setouts, and levels on site, prior to commencing contract, and shall immediately notify Drafting Waikato Ltd of any discrepancies or errors.

No claims will be recognised if Drafting Waikato Ltd is not alerted to any discrepancy or error immediately Proposed New Dwelling for:

Callavate tt Lot 712, 25 Raranga Road, Lakeside, Te Kauwhata


Roof Framing Plan

ENG Publish Date 4/08/2025 Wind Zone: High N0 Earthquake Zone Exposure Zone

1:100 @ A3 Sheet: 25-028

DW

204

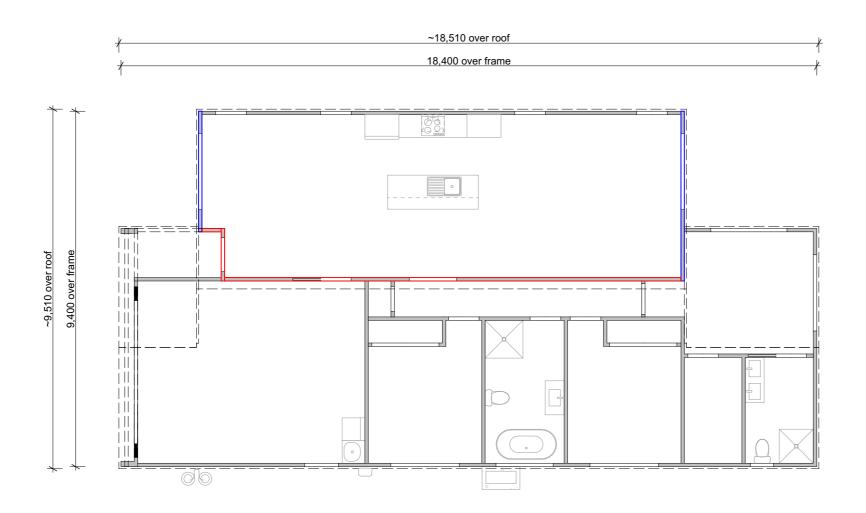



403 Waerenga Road, RD1, Te Kauwhata Sheena Young | Phone: 027 497 8860 Email: sheena@callavate.co.nz Plans Drawn By: **DRAFTING WAIKATO LTD**.

DRAFTING WAIKATO Ltd New Homes | Additions & Alterations Calla

Jeff Cunningham 027 484 2212 jeff@draftingwaikato.co.nz www.draftingwaikato.co.nz

Plans for Engineer Design only, not to be used for Resource Consent or Building Consent

The Copyright of these plans shall remain with Drafting Waikato Ltd.

Drafting Waikato Ltd accepts no responsibility for any work undertaken that is not in strict accordance with these drawings.

Do not scale of plans, use factored dimensions only. All construction shall be in strict accordance with the New Zealand Building Code.

Contractor shall check and verify all dimensions, setouts, and levels on site, prior to commencing contract, and shall immediately notify Drafting Waikato Ltd of any discrepancies or errors.

No claims will be recognised if Drafting Waikato Ltd is not alerted to any discrepancy or error immediately.

Proposed New Dwelling for:

Sheet Title:

Toposca New Dwelling for:	Officer fille.
Callavate	
Lot 712, 25 Raranga Road, Lakeside, Te Kauwhata	

	Version:
Bracing Plan	Publish Date:

Braci	ng Element ID————————————————————————————————————			
Brace Typ	pe Legend:			
GS1-N Any 10mm or 13mm GIB Standard plasterboard to one side only, no additional hold-downs				
1	I I			

Length of Element (m)


Bracing Legend:

Brace Line ID

Brace Type Legend:			
GS1-N	Any 10mm or 13mm GIB Standard plasterboard to one side only, no additional hold-downs		
BL1-H	10mm or 13mm GIB Braceline to one side only, additional hold-downs required		
BLP-H	10mm or 13mm GIB Braceline to one side of the frame plus minimum 7mm structural plywood manufactured to AS/NZ 2269.0:2012 to the other side, additional hold-downs required		
EP1	Ecoply one side, additional hold-downs required		
EPBS	Ecoply Barrier one side, no additional hold-downs		

	Wind Zone:	Snow Loading:	Scale:	Drawn By:
ENG	High	N0	1:100 @ A3	DW
	Earthquake Zone:	Exposure Zone:	Reference:	Sheet:
4/08/2025	1	В	25-028	206



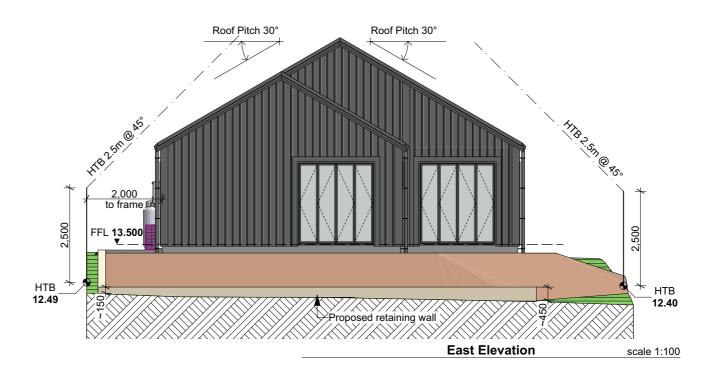

BUILDING ENVELOPE RISK MATRIX Worst Case Scenario Risk Severity Risk Score Risk Factor Wind zone (per NZS 3604) High risk Low risk Number of storeys 0 Roof/wall intersection design Very high risk 5 5 Eaves width Very high risk Envelope complexity Medium risk 1 Deck design Low risk Λ Total Risk Score: 12

Roofing:
Roof Cladding: Colorsteel Trimrib roofing by Roofing Industries

Roof Pitch: 30°

Fascia/Barge: Colorsteel 150mm Multifit fascia by Roofing Industries Spouting: Colorsteel 150mm OG spouting by

Roofing Industries Downpipes: DN80 uPVC
Wall Cladding:

Wall Cladding Systems:

- Colorsteel Trimrib vertical wall cladding by Roofing Industries on 20mm H3.1 Hermpac Vertibat cavity batten system

- Hermpac 18.5mm vertical cedar shiplap weatherboard on 20mm H3.1 Hermpac Vertibat cavity batten system

Exterior Joinery:

- Site measure all openings prior to joinery manufacture
- ThermalHEART powdercoated aluminium thermally broken joinery
- All bathroom & WC windows, & all windows with sills >1000mm from adjacent ground level shall have restrictor stays Glazing:
- Install glazing in accordance with NZS 4223 - Clear double glazing generally (R0.46)
- Obscure glazing to all bathrooms & WC's
- Safety glass to locations shown on Door &
- Window Schedule (ref. sheet 701) in accordance with Table 1, NZS 4223.3:2016
- All glazing within 2000mm of FFL in wet areas, & all shower screens/doors, shall be safety glass in accordance with NZS 4223.3:2016 (ref. Table A4)

 $C\Lambda LL\Lambda V\Lambda TE$ elevating new beginnings

403 Waerenga Road, RD1, Te Kauwhata Sheena Young | Phone: 027 497 8860 Email: sheena@callavate.co.nz
Plans Drawn By: DRAFTING WAIKATO LTD.

027 484 2212

Plans for Engineer Design only, not to be used for Resource Consent or Building Consent

The Copyright of these plans shall remain with Drafting Waikato Ltd. **DRAFTING WAIKATO Ltd** New Homes | Additions & Alterations Jeff Cunningham

> ngwaikato.co.nz www.draftingwaikato.co.nz

Proposed New Dwelling for: Callavate

^t Lot 712, 25 Raranga Road, Lakeside, Te Kauwhata

Ine Copyright of these plans shall remain with Drafting Waikato Ltd.

Drafting Waikato Ltd accepts no responsibility for any work undertaken that is not in strict accordance with these drawings.


Do not scale of plans, use factored dimensions only. All construction shall be in strict accordance with the New Zealand Building Code.

Contractor shall check and verify all dimensions, setouts, and levels on site, prior to commencing contract, and shall immediately notify Drafting Waikato Ltd of any discrepancies or errors.

No claims will be recognised if Drafting Waikato Ltd is not alerted to any discrepancy or error immediately.

Elevations

Version:	Wind Zone:	Snow Loading:	Scale:	Drawn By:
ENG	High	N0	1:100 @ A3	DW
Publish Date:	Earthquake Zone:	Exposure Zone:	Reference:	Sheet:
4/08/2025	1	В	25-028	301

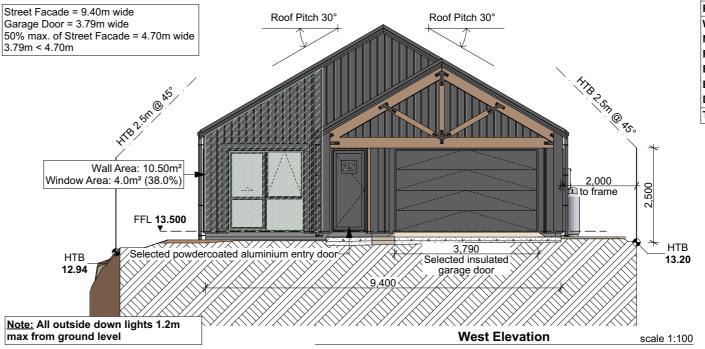



BUILDING ENVELOPE RISK MATRIX Worst Case Scenario Risk Factor Risk Severity Risk Score Wind zone (per NZS 3604) High risk Low risk Number of storeys 0 Roof/wall intersection design Very high risk 5 5 Eaves width Very high risk Envelope complexity Medium risk 1 Deck design Low risk Λ Total Risk Score: 12

Roofing:
Roof Cladding: Colorsteel Trimrib roofing by Roofing Industries

Roof Pitch: 30° Fascia/Barge: Colorsteel 150mm Multifit fascia

by Roofing Industries Spouting: Colorsteel 150mm OG spouting by

Roofing Industries Downpipes: DN80 uPVC
Wall Cladding:

Wall Cladding Systems:

- Colorsteel Trimrib vertical wall cladding by Roofing Industries on 20mm H3.1 Hermpac Vertibat cavity batten system

- Hermpac 18.5mm vertical cedar shiplap weatherboard on 20mm H3.1 Hermpac Vertibat cavity batten system

Exterior Joinery:

- Site measure all openings prior to joinery manufacture
- ThermalHEART powdercoated aluminium thermally broken joinery
- All bathroom & WC windows, & all windows with sills >1000mm from adjacent ground level shall have restrictor stays Glazing:
- Install glazing in accordance with NZS 4223 - Clear double glazing generally (R0.46)
- Obscure glazing to all bathrooms & WC's
- Safety glass to locations shown on Door & Window Schedule (ref. sheet 701) in accordance with Table 1, NZS 4223.3:2016
- All glazing within 2000mm of FFL in wet areas, & all shower screens/doors, shall be safety glass in accordance with NZS 4223.3:2016 (ref. Table A4)

$C\Lambda LL\Lambda V\Lambda TE$ elevating new beginnings

403 Waerenga Road, RD1, Te Kauwhata Sheena Young | Phone: 027 497 8860 Email: sheena@callavate.co.nz Plans Drawn By: **DRAFTING WAIKATO LTD**.

DRAFTING WAIKATO Ltd New Homes | Additions & Alterations

> ngwaikato.co.nz www.draftingwaikato.co.nz

Jeff Cunningham 027 484 2212

Plans for Engineer Design only, not to be used for Resource Consent or Building Consent

The Copyright of these plans shall remain with Drafting Waikato Ltd.

Ine Copyright of these plans shall remain with Drafting Waikato Ltd.

Drafting Waikato Ltd accepts no responsibility for any work undertaken that is not in strict accordance with these drawings.

Do not scale of plans, use factored dimensions only. All construction shall be in strict accordance with the New Zealand Building Code.


Contractor shall check and verify all dimensions, setouts, and levels on site, prior to commencing contract, and shall immediately notify Drafting Waikato Ltd of any discrepancies or errors.


No claims will be recognised if Drafting Waikato Ltd is not alerted to any discrepancy or error immediately.

Proposed New Dwelling for:

Callavate Lot 712, 25 Raranga Road, Lakeside, Te Kauwhata

Version:	Wind Zone:	Snow Loading:	Scale:	Drawn By:
ENG	High	N0	1:100	DW
Publish Date:	Earthquake Zone:	Exposure Zone:	@ A3 Reference:	Sheet:
4/08/2025	1	В	25-028	302

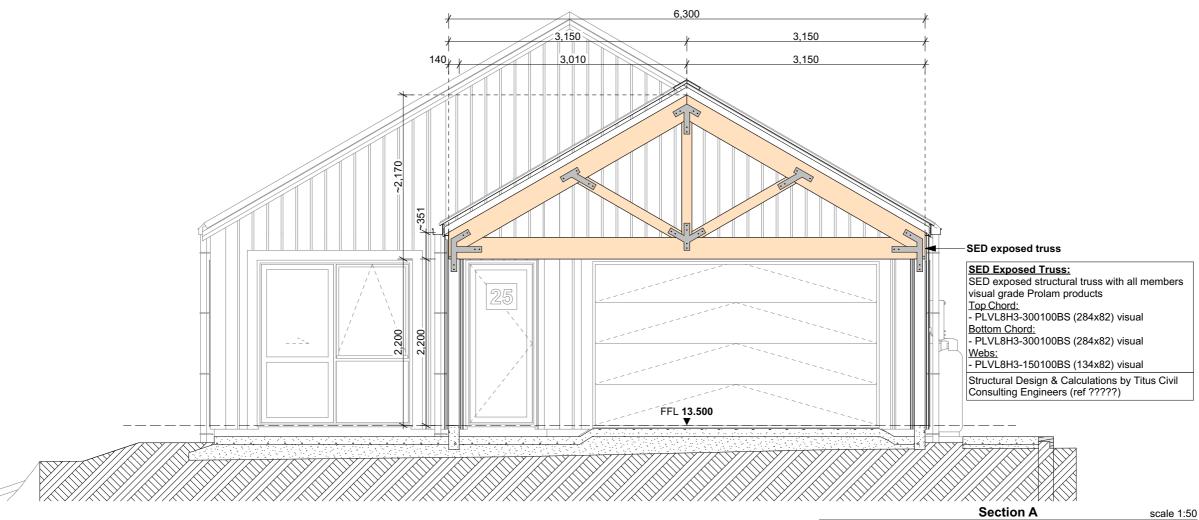

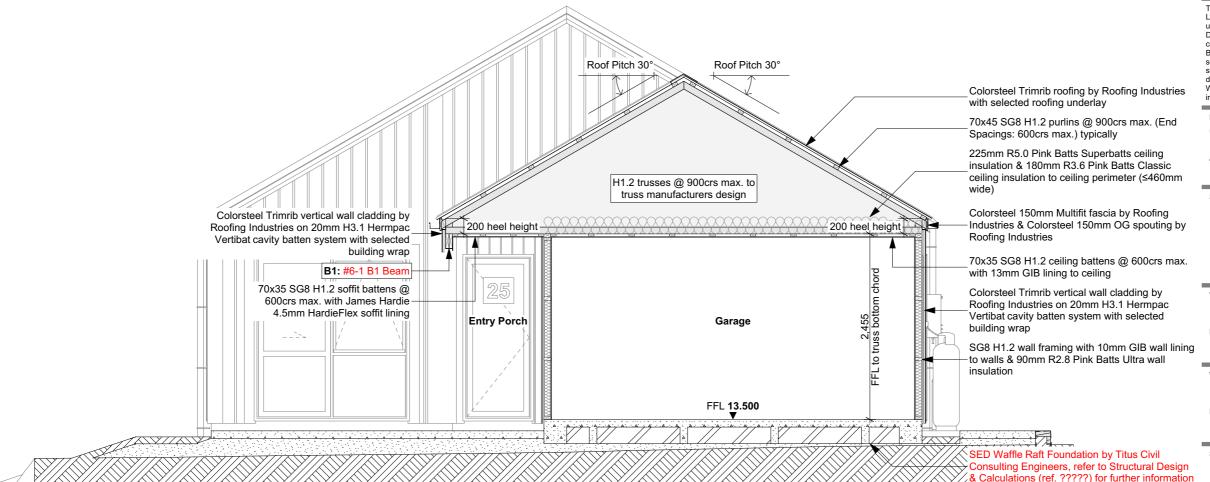

- Engineering Assessment and Design Report by Titus Civil Consulting Engineers (ref. 15339)

- Structural Design & Calculations by Titus Civil Consulting Engineers (ref. ?????)

- Buildable Truss Layout by Wecks ITM (ref. #200-3 Truss Reference)

Note

Selected DPM:

- Thermakraft Thermathene Black 250um Selected DPC
- Thermakraft Supercourse 500 DPC
- Selected DPC separation layer required between all concrete & timber
- Selected Air Barrier:
- Thermakraft Watergate Plus building wrap Selected Roofing Underlay:
- Themakraft Covertek 401 roofing underlay - Roof pitch ≥10° underlay support <u>is not</u> required

CALLAVATE

elevating new beginnings

403 Waerenga Road, RD1, Te Kauwhata Sheena Young | Phone: 027 497 8860 Email: sheena@callavate.co.nz Plans Drawn By: **DRAFTING WAIKATO LTD.**

DRAFTING WAIKATO Ltd

New Homes | Additions & Alterations



Jeff Cunningham

none: 027 484 2212 jeff@draftingwaikato.co.nz www.draftingwaikato.co.nz



The Copyright of these plans shall remain with Drafting Waikato Ltd. Drafting Waikato Ltd accepts no responsibility for any work undertaken that is not in strict accordance with these drawings. Do not scale of plans, use factored dimensions only. All construction shall be in strict accordance with the New Zealand Building Code. Contractor shall check and verify all dimensions, setouts, and levels on site, prior to commencing contract, and shall immediately notify Drafting Waikato Ltd of any discrepancies or errors. No claims will be recognised if Drafting Waikato Ltd is not alerted to any discrepancy or error

Proposed New Dwelling for:

Callavate

At Lot 712, 25 Raranga Road, Lakeside, Te Kauwhata

Sheet Title

Section A & B

DW

401

Version:

ENG

Publish Date:

4/08/2025

Wind Zone: Snow Loading:
High N0


Earthquake Zone: Exposure Zone:
1 B


eference: 25-028

1:50

@ A3

scale 1:50

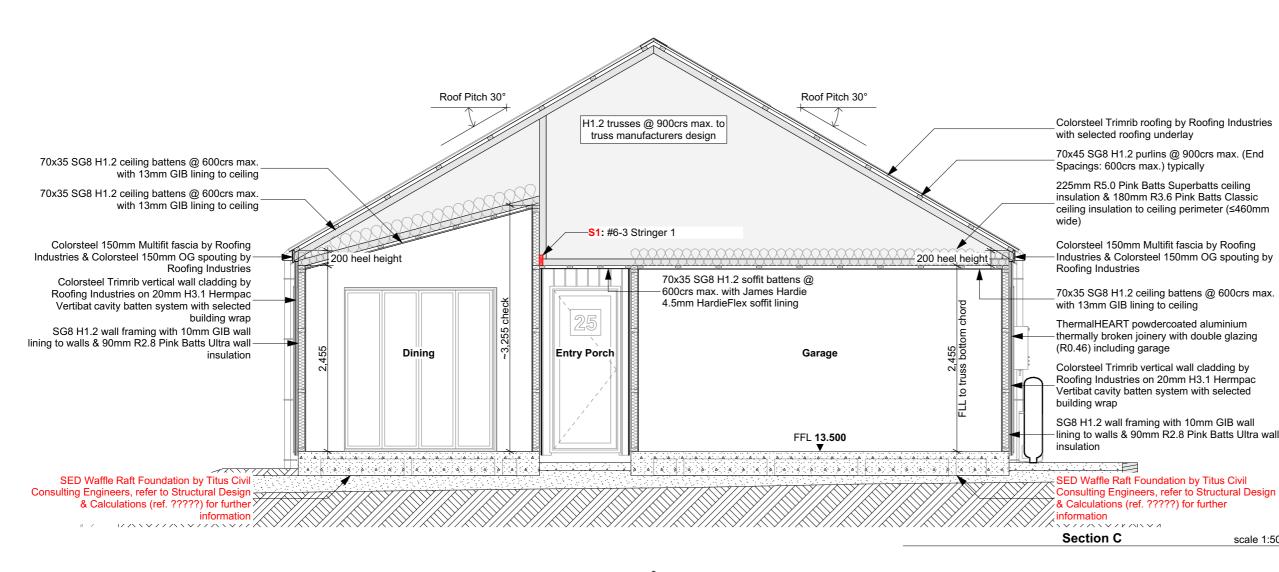

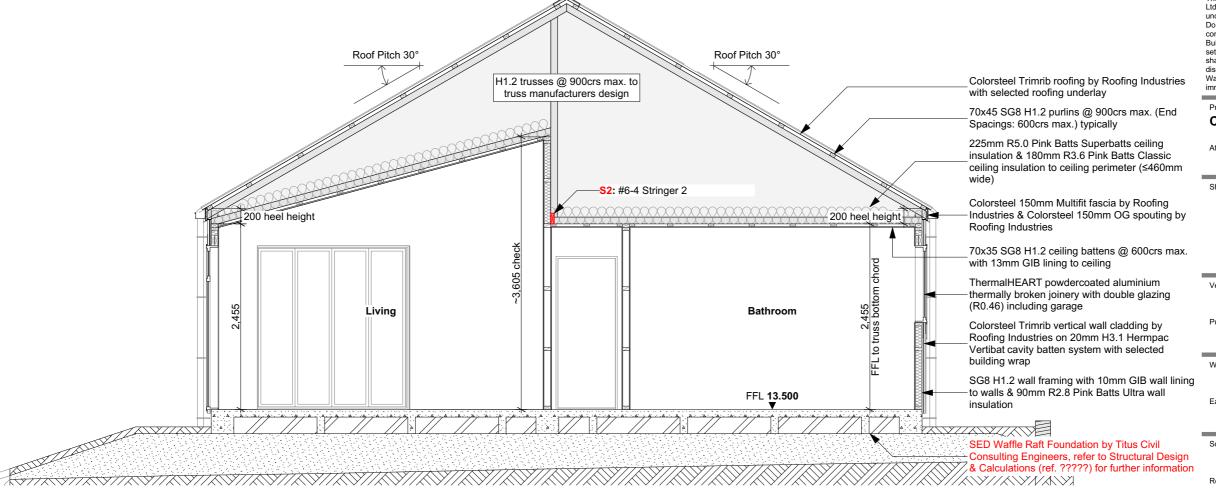

- Engineering Assessment and Design Report by Titus Civil Consulting Engineers (ref. 15339)

Structural Design & Calculations by Titus Civil Consulting Engineers (ref. ?????)

- Buildable Truss Layout by Wecks ITM (ref. #200-3 Truss Reference)

Selected DPM:

- Thermakraft Thermathene Black 250um Selected DPC
- Thermakraft Supercourse 500 DPC
- Selected DPC separation layer required between all concrete & timber Selected Air Barrier:
- Thermakraft Watergate Plus building wrap Selected Roofing Underlay:
- Themakraft Covertek 401 roofing underlay Roof pitch ≥10° underlay support is not required

403 Waerenga Road, RD1, Te Kauwhata Sheena Young | Phone: 027 497 8860 Email: sheena@callavate.co.nz Plans Drawn By: DRAFTING WAIKATO LTD.

DRAFTING WAIKATO Ltd

New Homes | Additions & Alterations



scale 1:50

Section D

Jeff Cunningham

027 484 2212 jeff@draftingwaikato.co.nz www.draftingwaikato.co.nz



construction shall be in strict accordance with the New Zealand Building Code. Contractor shall check and verify all dimensions, setouts, and levels on site, prior to commencing contract, and shall immediately notify Drafting Waikato Ltd of any discrepancies or errors. No claims will be recognised if Drafting Waikato Ltd is not alerted to any discrepancy or error


Proposed New Dwelling for:


Callavate

At: Lot 712, 25 Raranga Road, Lakeside, Te Kauwhata

Section C & D

Version: **ENG** Publish Date 4/08/2025 Wind Zone Snow Loading: N0 High Earthquake Zone Exposure Zone: В 1:50 DW @ A3 25-028 402 scale 1:50

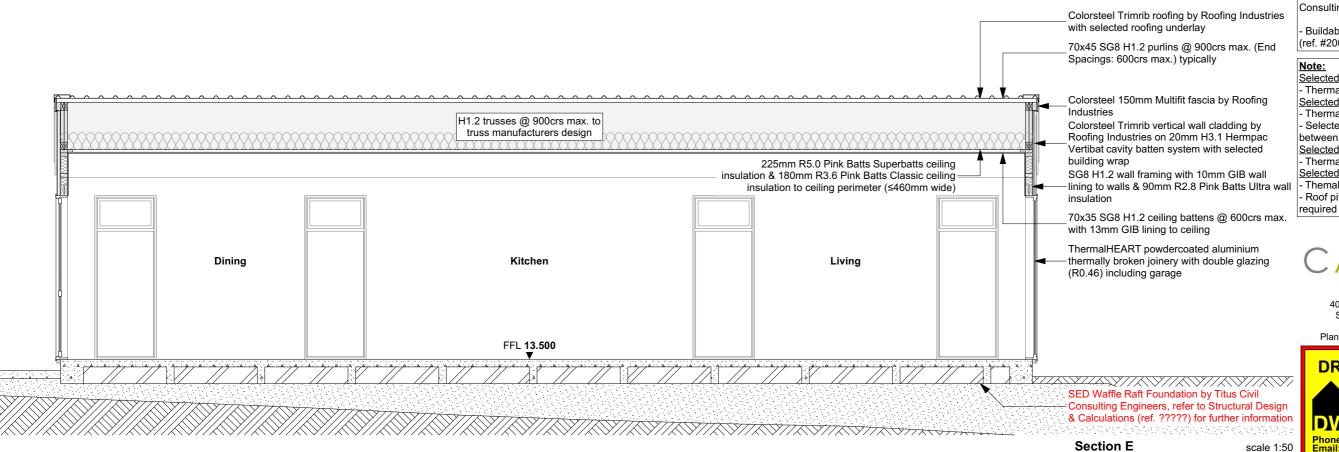

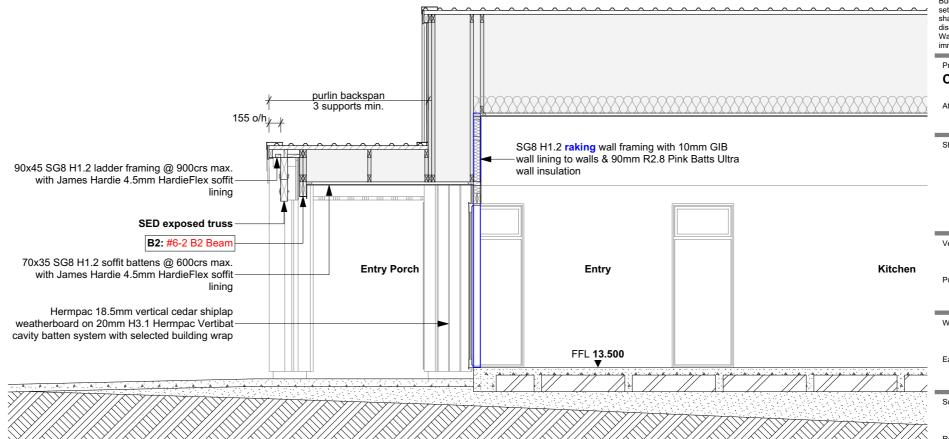

- Engineering Assessment and Design Report by Titus Civil Consulting Engineers (ref. 15339)

Structural Design & Calculations by Titus Civil Consulting Engineers (ref. ?????)

Buildable Truss Layout by Wecks ITM (ref. #200-3 Truss Reference)

Selected DPM:

- Thermakraft Thermathene Black 250um Selected DPC
- Thermakraft Supercourse 500 DPC
- Selected DPC separation layer required between all concrete & timber
- Selected Air Barrier:
- Thermakraft Watergate Plus building wrap Selected Roofing Underlay:
- Themakraft Covertek 401 roofing underlay - Roof pitch ≥10° underlay support is not

403 Waerenga Road, RD1, Te Kauwhata Sheena Young | Phone: 027 497 8860 Email: sheena@callavate.co.nz Plans Drawn By: DRAFTING WAIKATO LTD.

DRAFTING WAIKATO Ltd

New Homes | Additions & Alterations



Jeff Cunningham

027 484 2212 jeff@draftingwaikato.co.nz www.draftingwaikato.co.nz



The Copyright of these plans shall remain with Drafting Waikato Ltd. Drafting Waikato Ltd accepts no responsibility for any work undertaken that is not in strict accordance with these drawings. Do not scale of plans, use factored dimensions only. All construction shall be in strict accordance with the New Zealand construction shall be in strict accordance with the New Zealand Building Code. Contractor shall check and verify all dimensions, setouts, and levels on site, prior to commencing contract, and shall immediately notify Drafting Waikato Ltd of any discrepancies or errors. No claims will be recognised if Drafting Waikato Ltd is not alerted to any discrepancy or error

Proposed New Dwelling for:


Callavate


At: Lot 712, 25 Raranga Road, Lakeside, Te Kauwhata

Section F1

Section E & F1

Version **ENG** Publish Date: 4/08/2025 Wind Zone Snow Loading: High N0 Earthquake Zone Exposure Zone: В 1:50 DW @ A3 25-028 403 scale 1:50

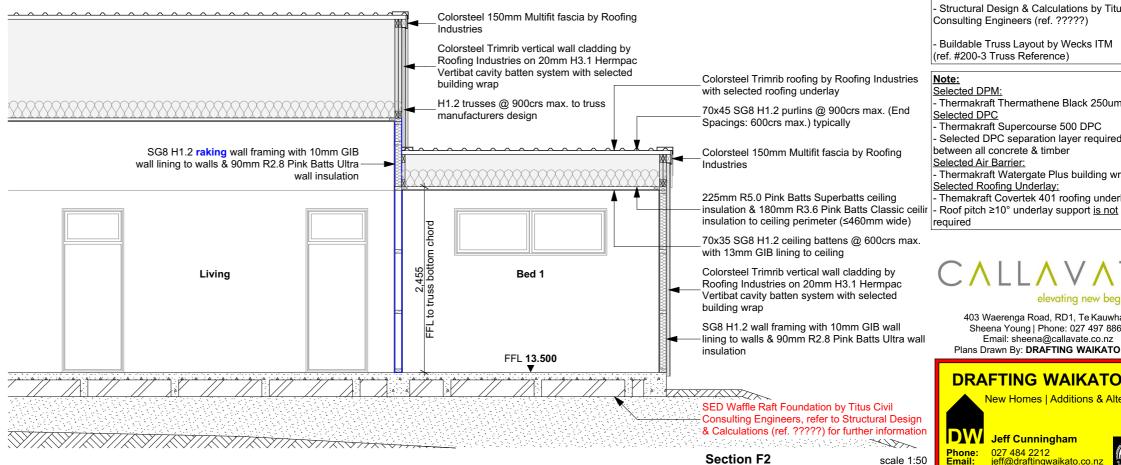

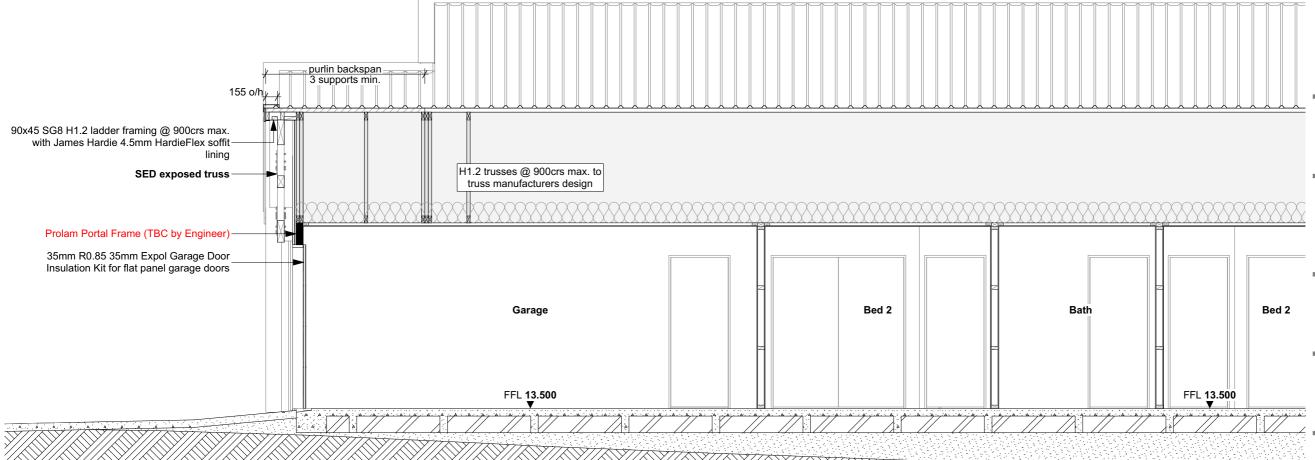

- Engineering Assessment and Design Report by Titus Civil Consulting Engineers (ref. 15339)

Structural Design & Calculations by Titus Civil Consulting Engineers (ref. ?????)

- Buildable Truss Layout by Wecks ITM (ref. #200-3 Truss Reference)

Selected DPM:

- Thermakraft Thermathene Black 250um Selected DPC
- Thermakraft Supercourse 500 DPC
- Selected DPC separation layer required between all concrete & timber

Selected Air Barrier:

- Thermakraft Watergate Plus building wrap Selected Roofing Underlay:
- Themakraft Covertek 401 roofing underlay required

403 Waerenga Road, RD1, Te Kauwhata Sheena Young | Phone: 027 497 8860 Email: sheena@callavate.co.nz Plans Drawn By: DRAFTING WAIKATO LTD.

DRAFTING WAIKATO Ltd

New Homes | Additions & Alterations



Jeff Cunningham

027 484 2212 jeff@draftingwaikato.co.nz



construction shall be in strict accordance with the New Zealand Building Code. Contractor shall check and verify all dimensions, setouts, and levels on site, prior to commencing contract, and shall immediately notify Drafting Waikato Ltd of any discrepancies or errors. No claims will be recognised if Drafting Waikato Ltd is not alerted to any discrepancy or error

Proposed New Dwelling for:

At: Lot 712, 25 Raranga Road, Lakeside, Te Kauwhata

Callavate

Section F2 & G

Version: **ENG** Publish Date: 4/08/2025 Wind Zone Snow Loading: High N0 Earthquake Zone Exposure Zone: В 1:50 DW @ A3 25-028 404