
# **Approved Building Consent Documents**

Please Note: A copy of the stamped approved documents must be available on site for all inspections.

INSPECTION BOOKING TIMEFRAMES Telephone 03 347 2839				
Call received	received Before 3pm After 3pm inspection inspection will be done will be done			
Monday	Wednesday	Thursday		
Tuesday	Thursday	Friday		
Wednesday	Friday	Monday		
Thursday	Monday	Tuesday		
Friday	Tuesday	Wednesday		

# **Planning Approved**

area to be reduced as existing mound to be removed. To allow .225 clearance for FFL

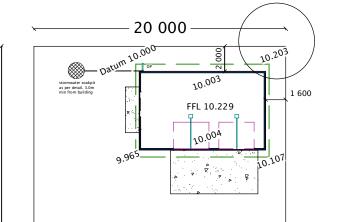

#### SECURITY FENCING.


Security fences to be errected to unprotected boundaries to meet F5 of the building code. Lockable gates to entry.

This applies if the situation is one that the public or children could be at risk on site during construction.

## NOTE,

Site levels to be confirmed before construction commences.

FFL to be a minimum of 0.225mm above FGL at highest point of site at foundation.

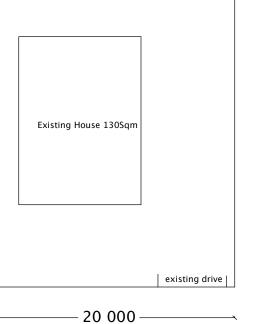

Site Plan. Scale 1-300

## **DT Design**

Lee Street

Mobile 022 101 8879 email dtdesignnz@icloud.com

All measurements, distances from boundaries and other relevant details to be confirmed on site and with respective authorities before building commences. E&OE





Proposed Residence For Rickerby Residence 14 Lee Street Southbridge

Site Details

Address	14 Lee Street
Town-City	Southbridge
Area	Selwyn
Lot	2
DP	25923
Land Area	1055m²
Plan Footprint	60m²
Coverage	0.05%
Wind Zone	High
Wind Region	A
Earthquake Zone	2
Snow Zone	N4
	1


Date: 26/4/2018 Area: Page:

Plan#

Drawn By: D Sowerby

1-300

Scale:

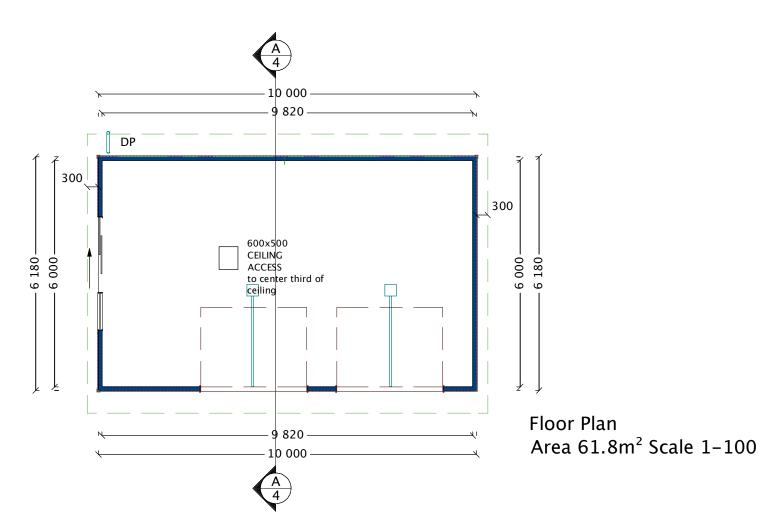


Note.

Window lintel heights to be confirmed to window manufacturer.


Refer to truss design layout for confirmation Revels to be H3.1 treated

All bracing ply to be fixed with Hot dipped galvanized fixings.

WALL BRACING KEY NO. TYPE LENGTH

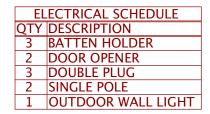

	DOOR SCHEDULE				
NUM	BER	QTY	WIDTH	HEIGHT	DESCRIPTION
D01		2	2800	2100	GARAGE-SLAB
D02		1	3000	2330	MULLED UNIT

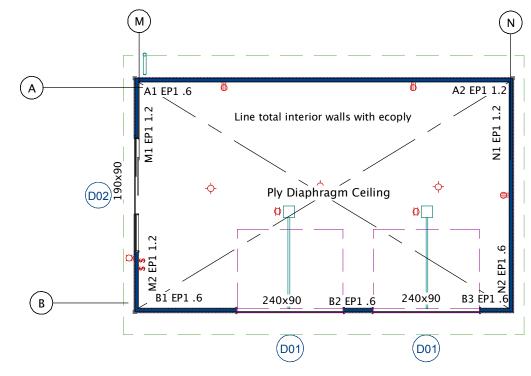

Bracing Layout, Electrical, Window, Door & Lintel Sizes

#### **DT Design**

Mobile 022 101 8879 email dtdesignnz@icloud.com

All measurements, distances from boundaries and other relevant details to be confirmed on site and with respective authorities before building commences. E&OE







Proposed Residence For Rickerby Residence 14 Lee Street Southbridge

Date: 26/4/2018	Area:
Scale: 1-100	Plan #
Drawn By: D Sowerby	/


raye

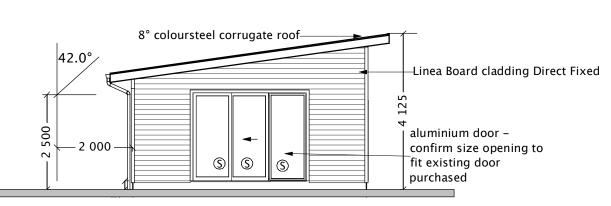


East Elevation

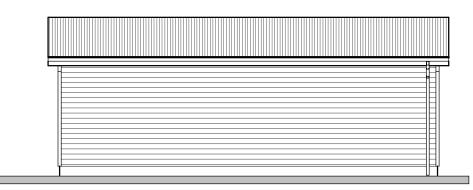

South Elevation

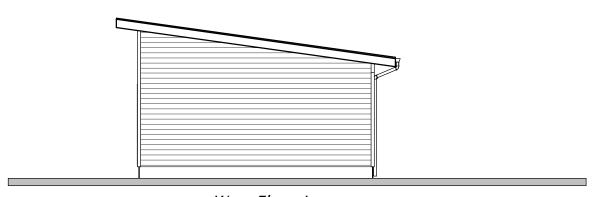

West Elevation

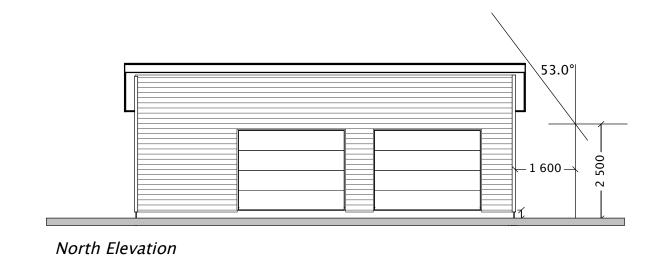

#### DT Design

Mobile 022 101 8879 email dtdesignnz@icloud.com

All measurements, distances from boundaries and other relevant details to be confirmed on site and with respective authorities before building commences. E&OE






Proposed Residence For Rickerby Residence 14 Lee Street Southbridge

Date:	26/4/2018	Area:	
Scale:	1-100	Plan #	
Drawn E	By: D Sowerby	/	

Page:

Ĵ

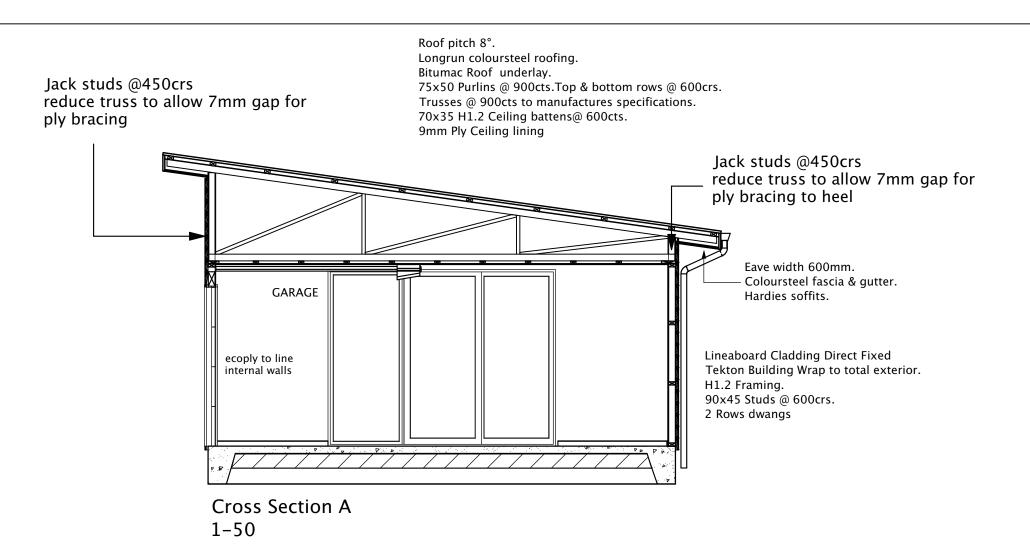

### FRAMING SCHEDULE All framing to be graded SG8

Area over foundations	61m <sup>2</sup>
Roof & pitch	Longrun Coloursteel Corrugate 8° Pitch
Eave width	600mm
Stud height	2450mm
Exterior cladding.	Scyon Lineaboard Weatherboard Direct fixed
Framing Timbers.	
Exterior walls	90x45 H1.2 Radiata (Studs @ 600crs)
Ceiling Plates	140x35 H1.2 Radiata
Ceiling battens @ 600cts	70x35 H1.2
Roof Framing.	H1.2 Radiata,
Revels	H3.1 Radiata Pine
Wall Wrap	Tekton Building Wrap
Roof Underlay	Bitumac 750

#### DT Design

Mobile 022 101 8879 email dtdesignnz@icloud.com

All measurements, distances from boundaries and other relevant details to be confirmed on site and with respective authorities before building commences. E&OE



BANILDING PARACIPITATION OF THE PARACIPITATI


Proposed Residence For Rickerby Residence 14 Lee Street Southbridge

Date: 26/4/2018 Area:

Scale: 1-50 Plan #


Drawn By: D Sowerby

Page:

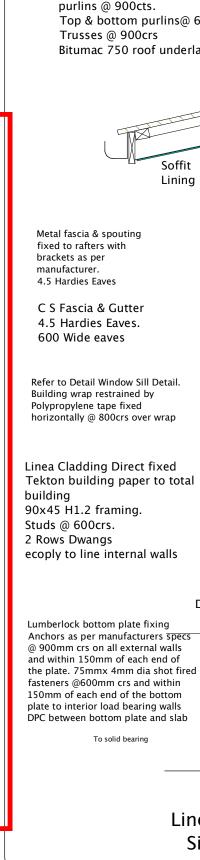


- 29/05/2018


Approved Building Consent Document - BC180811 - Pg 6 of 12

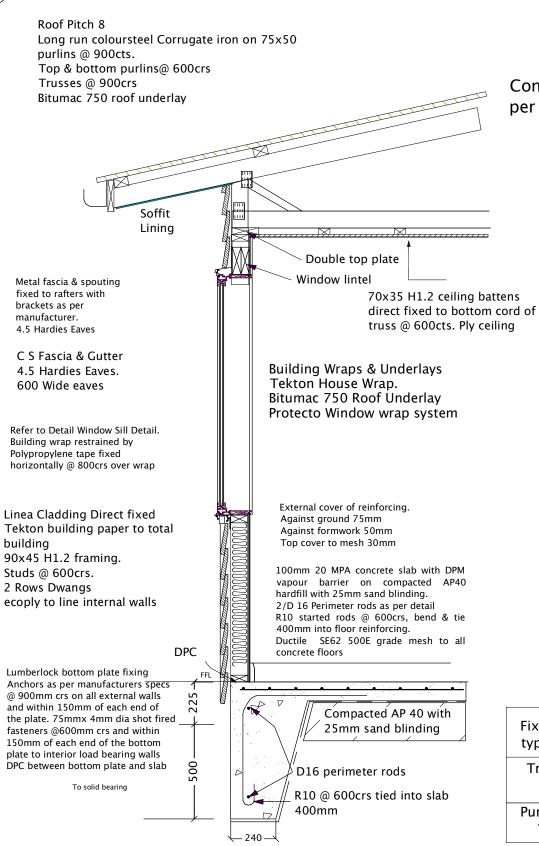

Linea Cross Section Detail. Single pour foundation

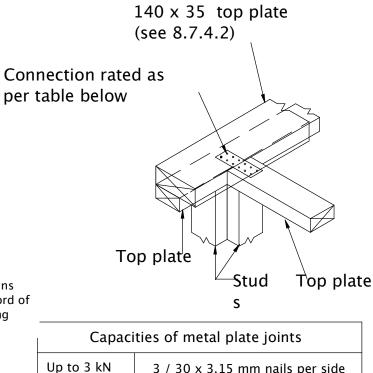


3 / 30 x 3.15 mm nails per side Up to 6 kN 6 / 30 x 3.15 mm nails per side

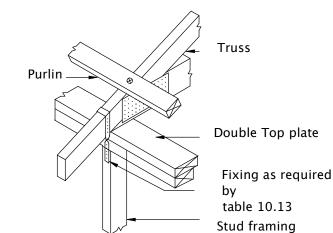


# Truss - Purlin Fixing


Fixing type	Fixing to resist uplift.	Alternative fixing capacity
Truss E	2/90 x 3.15 skewed nails + 2 wire dogs	(kN) 4.7
Purlins T	1/10g Self drilling screw	(kN) 2.4

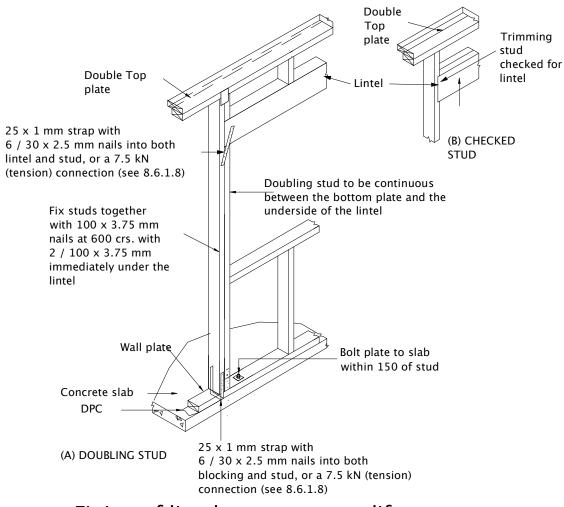

## Fixing of lintels to prevent uplift.

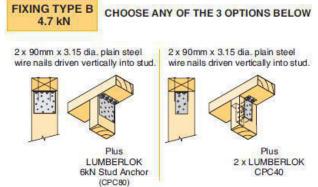

Recommended for internal wall options to avoid lining issues 2 x 90mm x 3.15 dia. plain steel

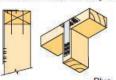

#### **DT Design**

Mobile 022 101 8879 email dtdesignnz@icloud.com

All measurements, distances from boundaries and other relevant details to be confirmed on site and with respective authorities before building commences. E&OE






Proposed Residence For Rickerby Residence 14 Lee Street Southbridge

Date: 26/4/2018 Area: Scale: 1-20 Plan# Drawn By: D Sowerby

Page:

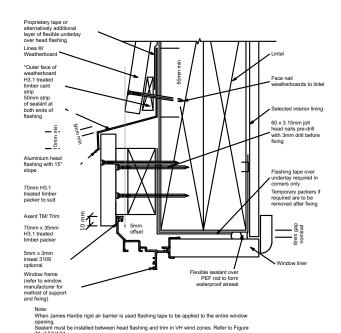

Flexible underlay continuous around corner / James Hardier (gid air barrier Linea & Weatherboard Face nail weatherboards to inner study only adhesive sealant to edge of Axent TM/ Trim


Note:

Note:

Note:

Scriber (10mm wide min) cut to fit Linea & Weatherboard for the continuous over floor joists.

Scale 1.2

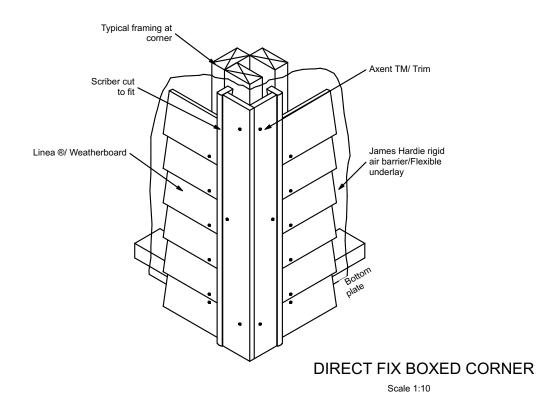

DIRECT FIX WINDOW AND DOOR HEAD WITH FACINGS

Bottom plate

D.P.C.

Concrete slab / footing


Concrete slab / footing

DIRECT FIX CONCRETE SLAB AND SOFFIT

Scale 1:2

James Hardie rigid air barrier/Flexible underlay
Linea & Hardie rigid air barrier legid air barrier le

DIRECT FIX WINDOW AND DOOR JAMB WITH FACINGS

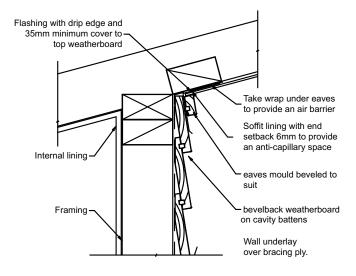

Bevelback weatherboard - cavity batten - reversed raked soffit

#### **DT Design**

Mobile 022 101 8879 email dtdesignnz@icloud.com

All measurements, distances from boundaries and other relevant details to be confirmed on site and with respective authorities before building commences. E&OE




Proposed Residence For

Rickerby Residence 14 Lee Street Southbridge Date: 26/4/2018 Area:


Scale: 1-20 Plan #


Drawn By: D Sowerby

Page:

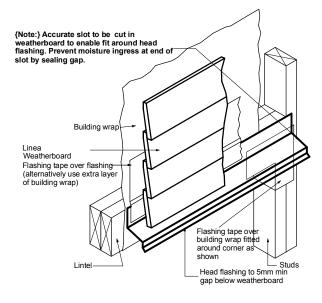


DIRECT FIX HEAD FLASHING TERMINATION

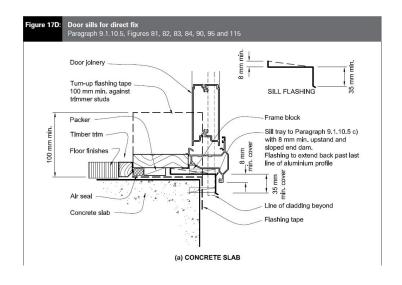

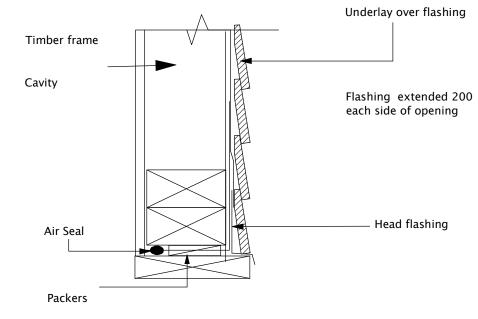

GARAGE DOOR HEAD DETAIL

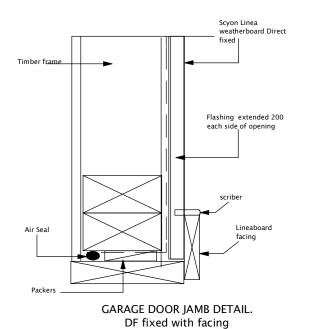

#### DT Design

Mobile 022 101 8879 email dtdesignnz@icloud.com

All measurements, distances from boundaries and other relevant details to be confirmed on site and with respective authorities before building commences. E&OE







Proposed Residence For Rickerby Residence 14 Lee Street Southbridge


Date:	26/4/2018	Area:	
Scale:	1-10	Plan#	
Drawn	By: D Sowerby	/	

Page:

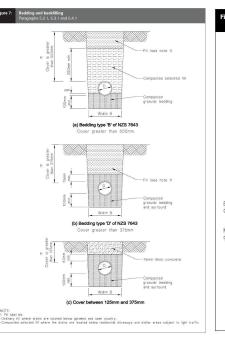

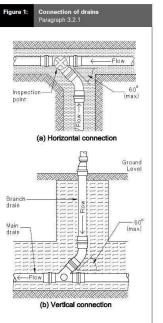

Roof Pitch 8°, Roof area  $83m^2$  /max catchment area per down pipe  $85m^2 = 1$  down pipes required.

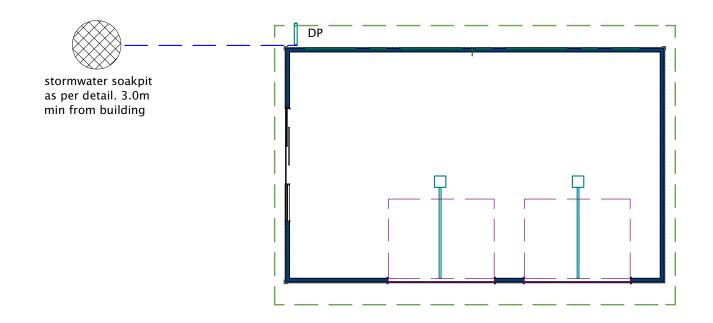

## Drainage Legend stormwater (100mmØ1-60 <del>-</del>220V power cable DP downpipe inspection point $\bigcirc$ IP Notes: Confirm stormwater connections on site before construction commences. 100mm Ø PVC stormwater pipes with gradient of 1-60 min laid in accordance with G13. Connect all services to appropriate connections. Downpipes 80mm PVC

Drainage Layout. Scale 1-100

#### **DT Design**

Mobile 022 101 8879 email dtdesignnz@icloud.com

All measurements, distances from boundaries and other relevant details to be confirmed on site and with respective authorities before building commences. E&OE







Proposed Residence For Rickerby Residence 14 Lee Street Southbridge

Date:	26/4/2018	Area:
Scale:	1-10	Plan #
Drawn I	By: D Sowert	Dy

i age

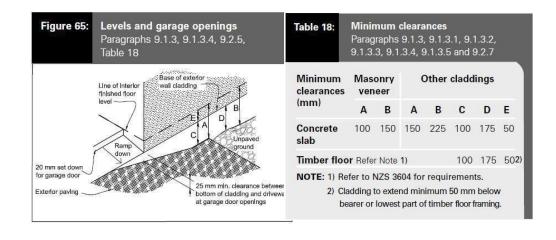

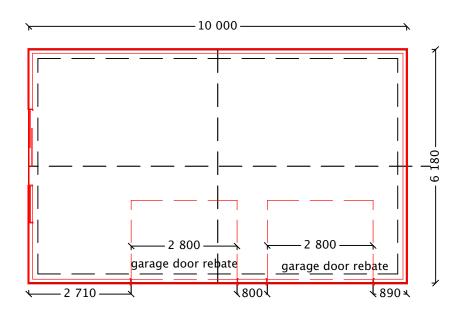

Slab Area 61m<sup>2</sup>
FFL = CGL + 225mm
Floor 20MPA concrete.
Foundation 20MPa concrete
100 mm Concrete Slab.
Foundation Reinforcing Grade E300.
Slab Mesh Grade SE62 500E Ductile
Polythene DPM on AP40 compacted with
25mm sand blinding.
Slab cuts as shown.

Exterior Slab Finish.
Slabs set down 150mm from main floor.
Fall of slabs to outer edge 1-60.
Slabs to have minimum of brushed finish for anti-slip

#### ANTI-SLIP:

On all access routes (both external & internal). Provide anti-slip surfaces complying with NZBC D1/AS1/Table 2 (except surfaces inside entry doors of housing may be considered as dry area's)

Slab Cuts —— ——

Slab Placement Dimensions Scale 1-100

**DT Design** 

Mobile 022 101 8879 email dtdesignnz@icloud.com

All measurements, distances from boundaries and other relevant details to be confirmed on site and with respective authorities before building commences. E&OE






Proposed Residence For Rickerby Residence 14 Lee Street Southbridge

Date:	26/4/2018	Area:
Scale:	1-10	Plan #
Drawn	By: D Sowerby	/


Page:


single tensioned crossed LUMBERLOK strip brace over top cord. fixed each end with 5/30x3.15 nails and at cord crossing with 1/30 3.15 nail

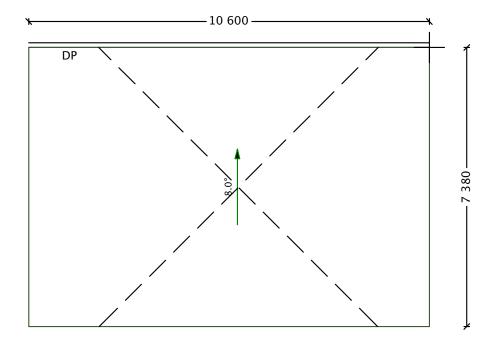

Roof details.
Pitch 8°
Longrun Corrugate
Coloursteel.
Fascia Coloursteel.
Spouting Coloursteel.
Downpipes 80mmØ.
Snow straps optional but recommended

Roof Layout Plan. Scale 1-100

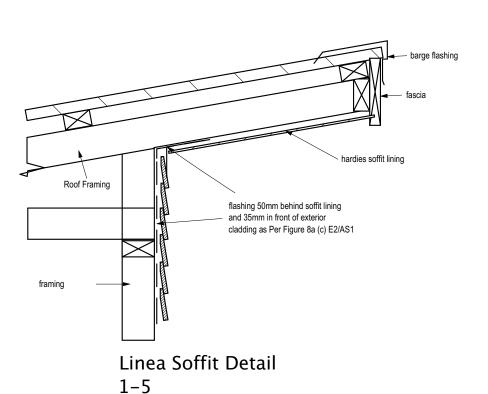

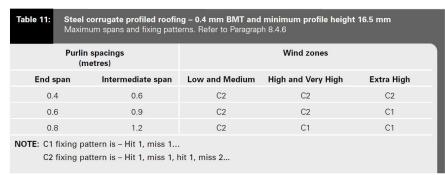


#### NOTE:

Top and bottom row of purlins spaced @ 600crs. Balance @ 900crs

X = 200mm

Y = 2 crests, finish in next trough.

Z = 50mm

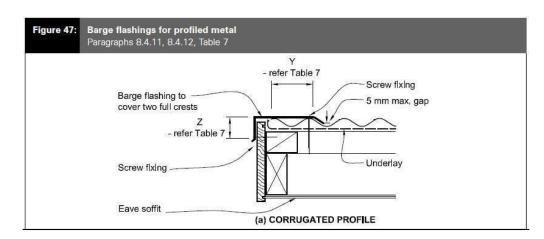

# **Roof Flashing Details**

#### DT Design

Mobile 022 101 8879 email dtdesignnz@icloud.com

All measurements, distances from boundaries and other relevant details to be confirmed on site and with respective authorities before building commences. E&OE





Proposed Residence For Rickerby Residence 14 Lee Street Southbridge Date: 26/4/2018 Area:

Scale: 1-100 Plan #

Drawn By: D Sowerby

age.

#### 10.2.1.15 Gable verges

#### 10 2 1 15 1

Gable verges shall be framed by either:

- (a) Purlins extending as cantilevers beyond their end supports as shown in figure 10.16 for a distance not exceeding that given by 10.2.1.15,2; or
- (b) Outriggers complying with 10.2.1.15.3 and as shown in figure 10.16.


#### 10.2.1.15.2

Purlins with a back span over at least 3 rafters may extend as cantilevers beyond their end supports for a distance not exceeding:

- (a) Laid on their flat:
  - (i) Light and heavy roofs at no more than 900 mm spacing
  - (ii) 70 mm x 45 mm purlins: 300 mm
  - (iii) 90 mm x 45 mm purlins: 450 mm
- Laid on their edge, light and heavy roofs, in accordance with table 10.8(a).

Table 10.9 - Outriggers - SG 8 (see 10.2.1.15.3)

Outrigger size and orientation	Maximum outrigger spacing for a maximum cantilever of: (mm)		Boundary / Fly rafter
(mmi	600	750	(mm)
70 x 45	900	600	70 x 45 (on edge)
90 x 45	1200	900	90 x 45 (on edge)
45 x 90	600	400	90 x 45 (on edge)

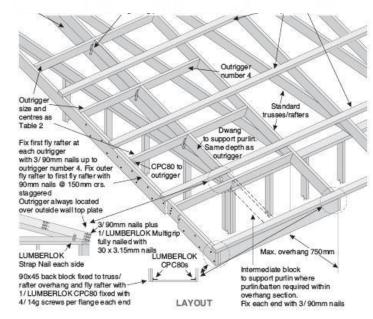

Gable Verge Details

#### **DT Design**

Mobile 022 101 8879 email dtdesignnz@icloud.com

All measurements, distances from boundaries and other relevant details to be confirmed on site and with respective authorities before building commences. E&OE





Proposed Residence For Rickerby Residence 14 Lee Street Southbridge

Date: 26/4/2018 Area:

Scale: NTS Plan #

Drawn By: D Sowerby

Page: