
BC21/128675 NPDC Approved for Building Consent, 13/07/2021 F5 - Site Safe Notes: Safety Fencing to be erected Note: Land Covenant contained to keep children and in document 6737819.4 unauthorised persons out of the construction Pater 40 Height Datum: NZVD2016 6.1126 593391 Height Origin: IT II DP 20439 RL: 60.61m Contour Interval: 0.25m Existing Fence Area E DP 457540 62.9 Distance to Road Boundary 16.25 Deck and Canopy Covenant Line Dwelling Stakes (green) NPDC SITE COPY yus This Building Consent is approved un BEDROOM 1 Building Act and is limited to new work only as This Plan to be used for Resource Consent Purposes Only. Areas and Dimensions are subject to Land Transfer Survey shown on these plans and related 45.5 Proposed location Approved: Paul Wallace Date: 13/07/2021 25,000L water tank Carparking 04 Site datum/site topo/BDY marking 03 House moved 2.2m north along cov bdy TB 19/05/21 To Weld Road Site Datum: Edge of Seal 274 Weld Road Top of Dumpy Peg RL: 45.99m Taranaki Proposed New Dwelling Lot 2 DP 457540 TDATE: 10/06/21 Boundary Line Stakes JRVEY BY: TB IRVEY DATE: 05/06/21 Final 1:200 @ A3 21049 04 77 Site Plan

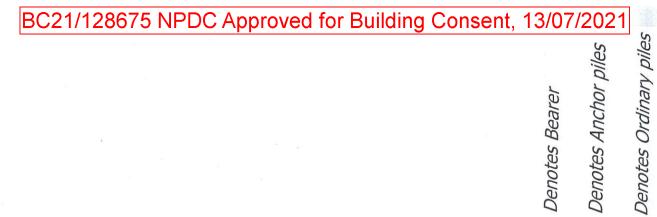

Denotes Bearer || || ||

Denotes Brace Piles


Pile plan prepared for C & J Silk

274 Weld Road Lower, Kaitake


Scale 1:100

NOTE: Bearer or double joist within 200mm of internal load bearing wall See Fig 6.1 NZS3064:2011

Non loading bearing wall containing bracing shall have solid blocking within 150mm of wall rig 7.5 NZS3604:2010

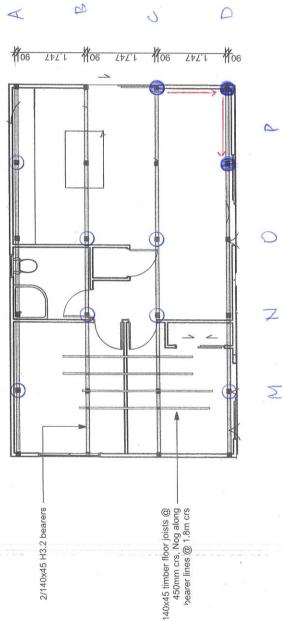

 \sum

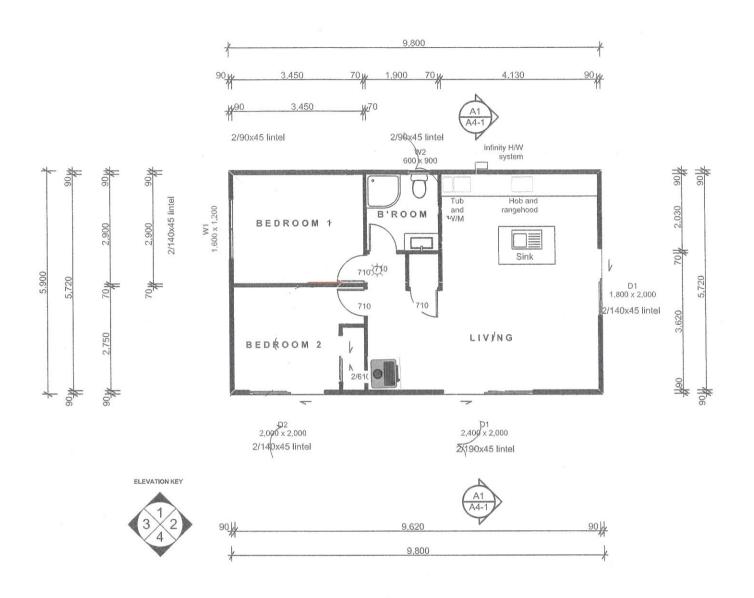

FLOOR PLAN Scale 1:100

BUILDING ENVELOR	E RISK MATR	IX
All Eleva	tions	
Risk Factor	Risk Severity	Risk Score
Wind zone (per NZS 3604)	Very high risk	2
Number of storeys	Low risk	0
Roof/wall intersection design	Low	0
Eaves width	Medium risk	1
Envelope complexity	Low risk	0
Deck design	Low	0
Total Risk Score:		3



BUILDING COMPONENT	Product used	Minimum insulation required	Insulation Achieved
Roof	R3.2 Batts	R2.9	R3.1
Walls	Board, & R2.4 batts (studs @ 600 crs)	R1.9	R1.9
Floor	Timber floor with R1.6 Batts	R1.3	R1.6
Glazing	Double Glazing	R0.26	R0.26

Total Glazing Area Allowed = 30% of Total wall area = 29.7 Sqm

KEY:

= New Timber framed wall

Whb = Wash hand basin

WC = Toilet

r = Show

=Battery operated Smoke Alarm

NOTE:

- Trusses as per plan attached

- Lintels to be fixed as per detail on Sheet A6-2

- Use 2/90x45 MS8 timber top plates fix as per MIITEK fixing schedule "B" Type

Line all wet areas with Gib Aqualine,

-10mm walls

-13mm ceilings

Bathroom shower to be one piece Acylic shower unit.

Kitchen / Laundry / WC and bathroom to be selected vinyl or tile flooring

- All downlights to be NZECP54 Classification CA

Mechanically vent showers & Dryer directly to the outside with a proprietary ventilation ducting system and inline fan run through roof framing space out through wall or soffit

NOTE:

Decks, Verandah, foundations not part of consent. to be completed prior to code of compliance

GENERAL NOTES:

- All new construction where not specifically designed shall comply with the NZ Building Code
- Handbook and shall conform to NZS 3604:2011
- Builder to check all dimensions prior to construction, manufacture or fixing in of any part
- and shall allow to adjust for fitting tolerances.
- 3. Dimensional errors shall not be the responsibility of the designer or the design firm or his agents
- 4. All exposed metal fasteners and plates shall be Stainless steel
- All timber in near contact to concrete, steel or cement based products shall be seperated with a malthoid strip DPC of sufficient width to prevent contact between the two.
- 6. Bottom plate to be fixed as per table on sheet A8-2.
- 8. All timber to be SG8 Grade
- 9. NO notching of studs allowed



NEW PLYMOUTH

40 Ocean View Parade | New Plymouth t: + 64 6 757 5842 FREECALL: 0800 MANORGROUP www.manorbuild.co.nz | e: sales@manorbuild.co.nz

These drawings are protected by copyright and remain the property of Manor Build. They may not be reproduced or copied without permission of Manor Build. All site dimensions are to be verified and confirmed by the client prior to the commencement of works.

#Notes

-1	-	C	H	е	r	١
- 1						

project: SILK Res

design by: Manor Build

scale: As Noted

date: 21/05/2021


Floor Plan

job no:


sheet no:


MG269

A2-1

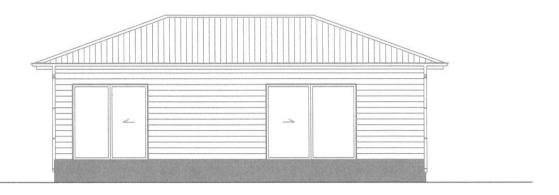


ELEVATION E1 Scale 1:100

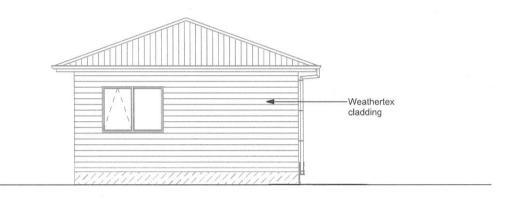

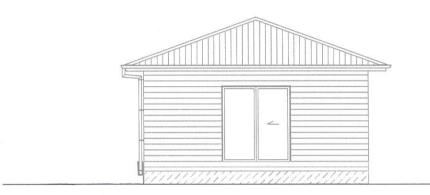

ELEVATION E2 Scale 1:100

ELEVATION E3 Scale 1:100

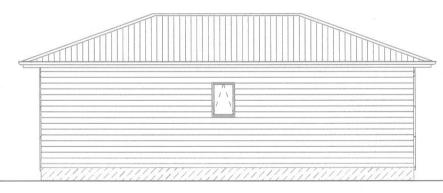

ELEVATION E4 Scale 1:100





NEW PLYMOUTH 40 Ocean View Parade | New Plymouth t: + 64 6 757 5842 FREECALL: 0800 MANORGROUP www.manorbuild.co.nz | e: sales@manorbuild.co.nz

These drawings are protected by copyright and remain the property of Manor Build. They may not be reproduced or copied without permission of Manor Build. All site dimensions are to be verified and confirmed by the client prior to the commencement of works.

#N	0	t

ı	C	ı	i	e	ļ	r
ı						

project: SILK Res

design by: M	anor Bulk	
--------------	-----------	--

scale: As Noted

date: 21/05/2021

Elevations

job no:

sheet no:

MG269

A3-1

Plumbing and drainage prepared for C & J Silk 274 Weld Road Lower, Kaitake

Plumbing and Drainage

GT = Gulley Trap ORG = Overflow relief gulley

IP = Inspection Point

IB = Inspection Bend
IJ = Inspection Junction
DP = Downpipes 80mm


TV = 80mm terminal vent

Foul water to comply With G13/AS1 & G13/AS2

All waste sizes and drains To comply with G13/AS1

Stormwater pipe to be 100mm PVC Fall 1:100

Wastewater pipe from 100mm PVC Fall 1:60

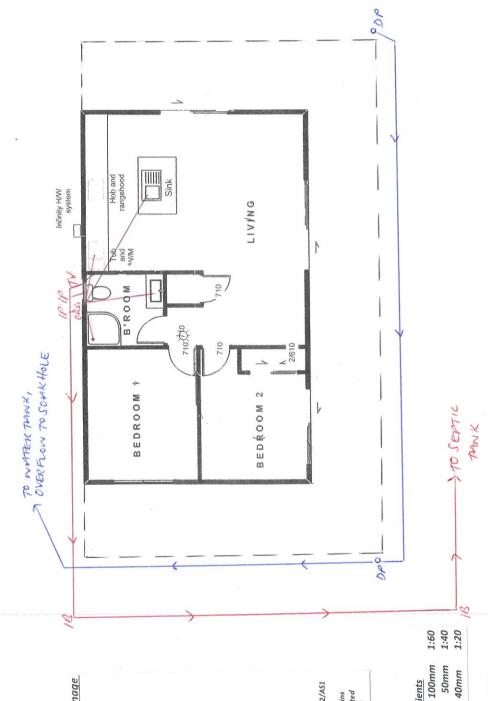

Supply and install 1200mm dia. x 75mm Thick concrete lid set 150mm below Soak hole to be 5m x 750mm dia.

Ground level


40mm


Shower/tub/sink

Waste sizes and gradients

Water Line 25mm $\,
ho \mathcal{E} \,$ Blueline to comply with G12/AS1

All fittings with branch drains Exceeding 3.5m shall be fitted With air admittance valves

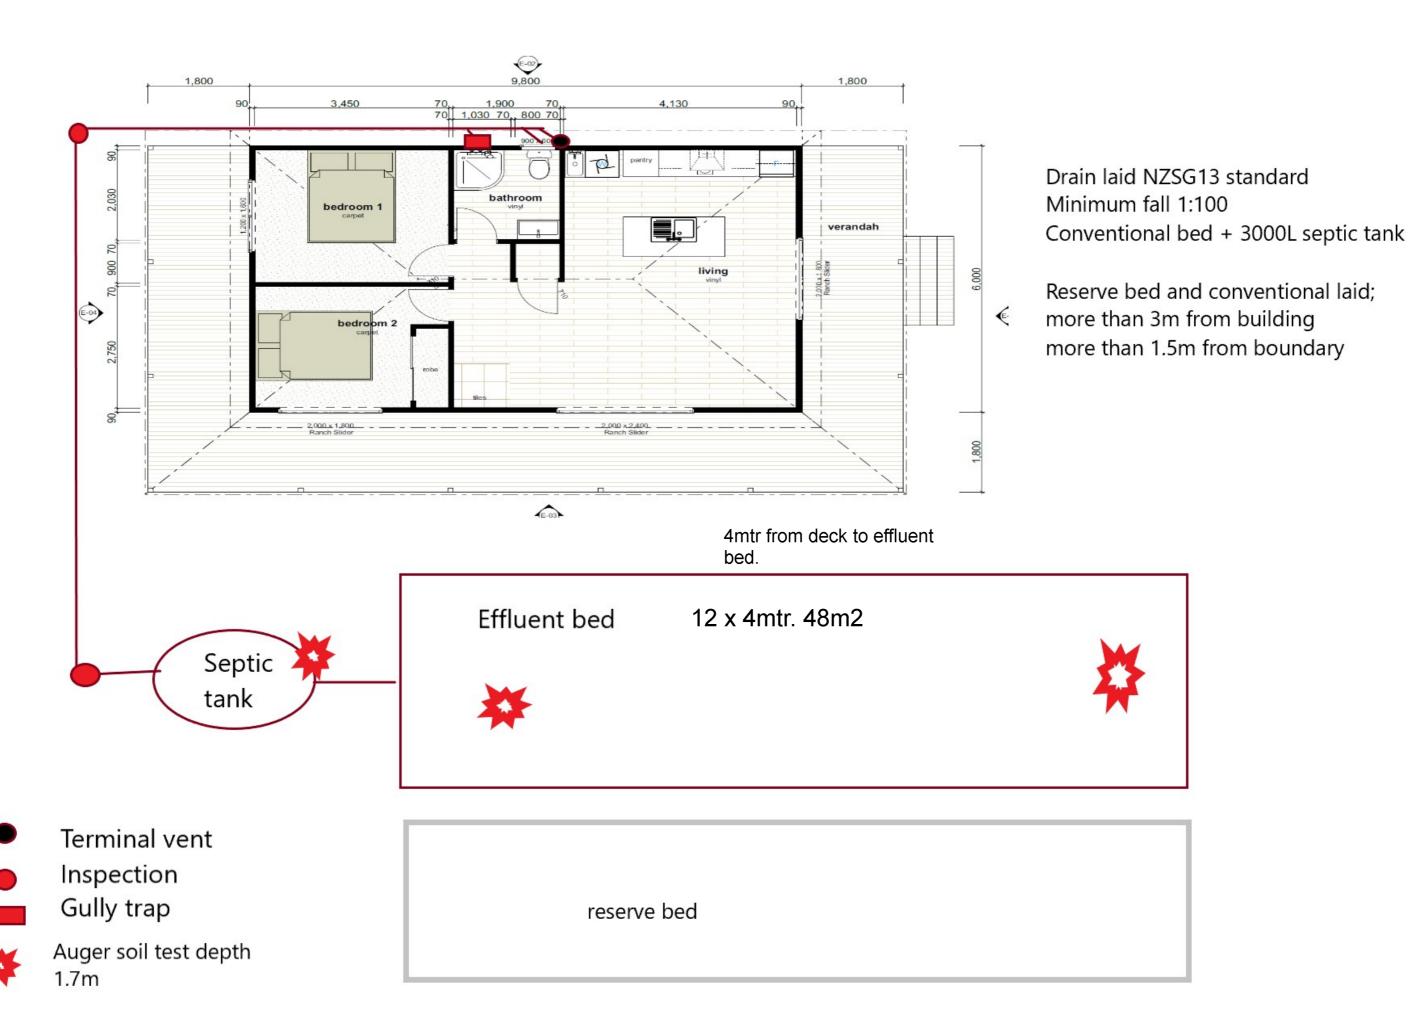

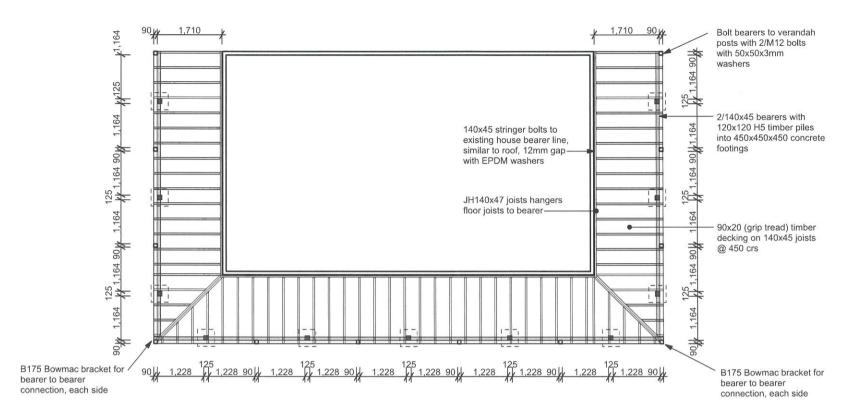


Framing timbers (1, 2, 3)			
external wall framing masonry <mark>veneer</mark> cladding	H1.2	external wall framing E2/AS1 20 mm cavity cladding	H1.2
balcony wall framing enclosed	H1.2	cavity battens	H3.1
parapet framing	H1.2	interior wall framing	H1.2
roof framing – low slope/skillion	H1.2	roof sarking plywood membrane roof	НЗ ССА
roof framing – roof space	H1.2	roof sarking timber	H1.2
enclosed subfloor framing	H1.2	framing and other members within enclosed cantilevered decks	H3.2

NOTE: Use stainless steel for all bolt and exterior fixings


FLOOR FRAMING PLAN Scale 1:150

Timber to be used for	Required treatment	Timber to be used for	Required treatment
External timber use			
house piles	H5	poles and crib walling	H5
enclosed subfloor framing	H1.2	exposed subfloor framing	H3.2
veranda posts supported clear of ground	H3.2	veranda posts in ground	H5
deck jack studs supported clear of ground	H3.2	deck piles in ground	H5
deck joists/bearers	H3.2	wall framing weather exposed	H3.2
decking	H3.2	roof framing weather exposed	H3.2
cladding or exterior trims unpainted, clear finished or stained	H3.2	shingles/shakes	H3.2
cladding or exterior trims painted	H3.1	exterior plywood unpainted or used as bracing	НЗ ССА
fence rails and palings	H3.2	exterior plywood painted	H3 LOSP
fence posts/landscape timbers exposed to weather and in ground contact	H4	balcony barrier exposed	H3.2

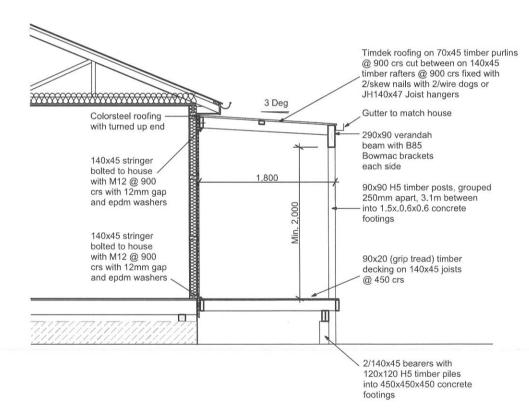





SECTION "A" Scale 1:50

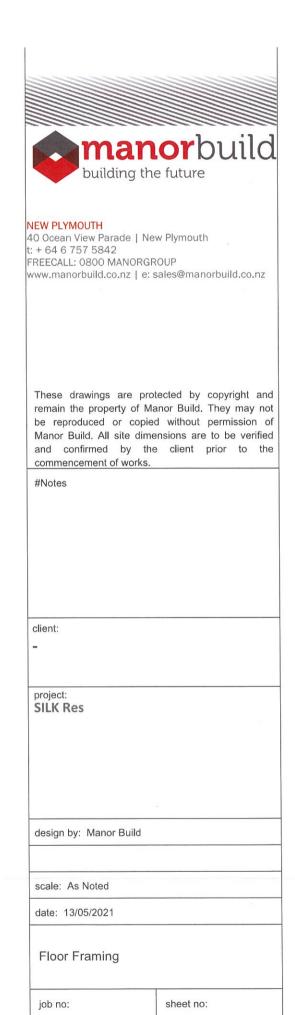


MG269


A2-1

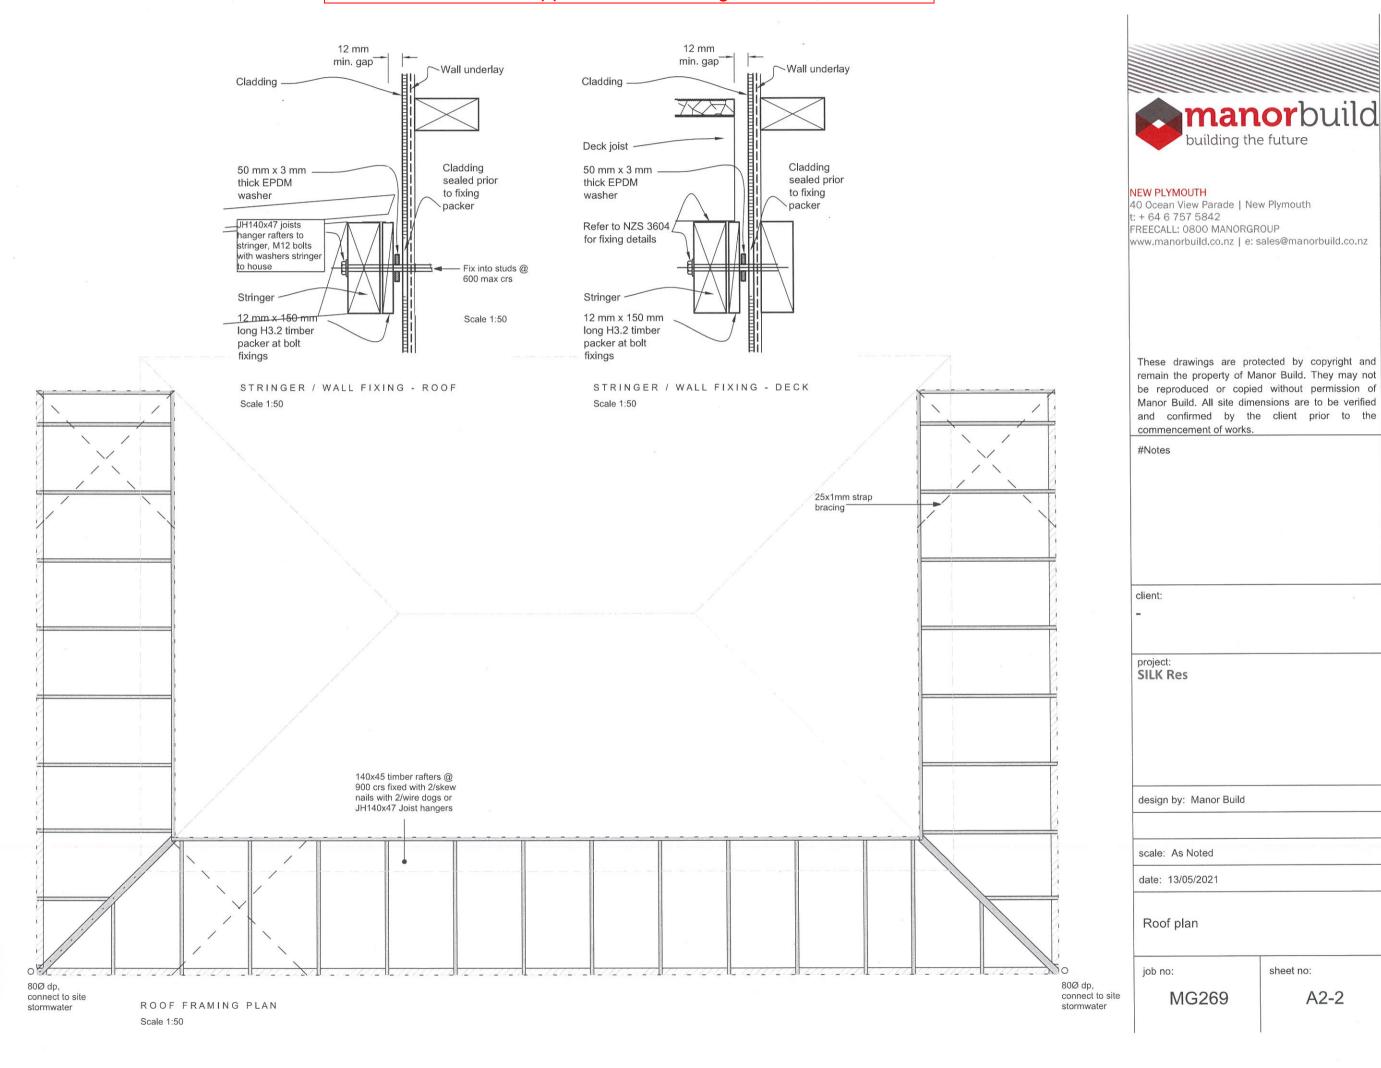

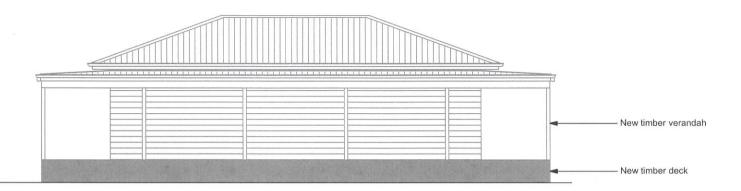


ELEVATION E1 Scale 1:100

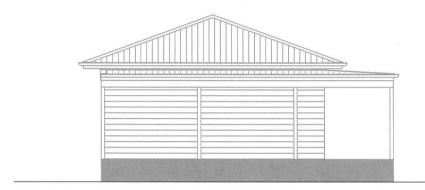

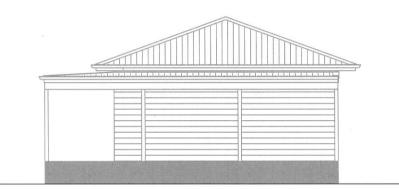

ELEVATION E2 Scale 1:100 ELEVATION E3 Scale 1:100

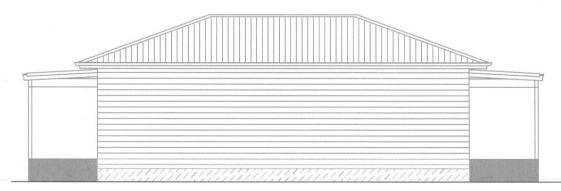

ELEVATION E4 Scale 1:100





NEW PLYMOUTH

40 Ocean View Parade | New Plymouth t: + 64 6 757 5842 FREECALL: 0800 MANORGROUP www.manorbuild.co.nz | e: sales@manorbuild.co.nz

These drawings are protected by copyright and remain the property of Manor Build. They may not be reproduced or copied without permission of Manor Build. All site dimensions are to be verified and confirmed by the client prior to the commencement of works.

#	N	-	4	_	_
++	N	U	U	u	2

	C	ł	ì	е
- 11				

project: SILK Res

design by: Manor Build

scale: As Noted

date: 13/05/2021

Elevations

job no:

sheet no:

MG269

A3-1