
BUILDING CONSENT LAYOUT

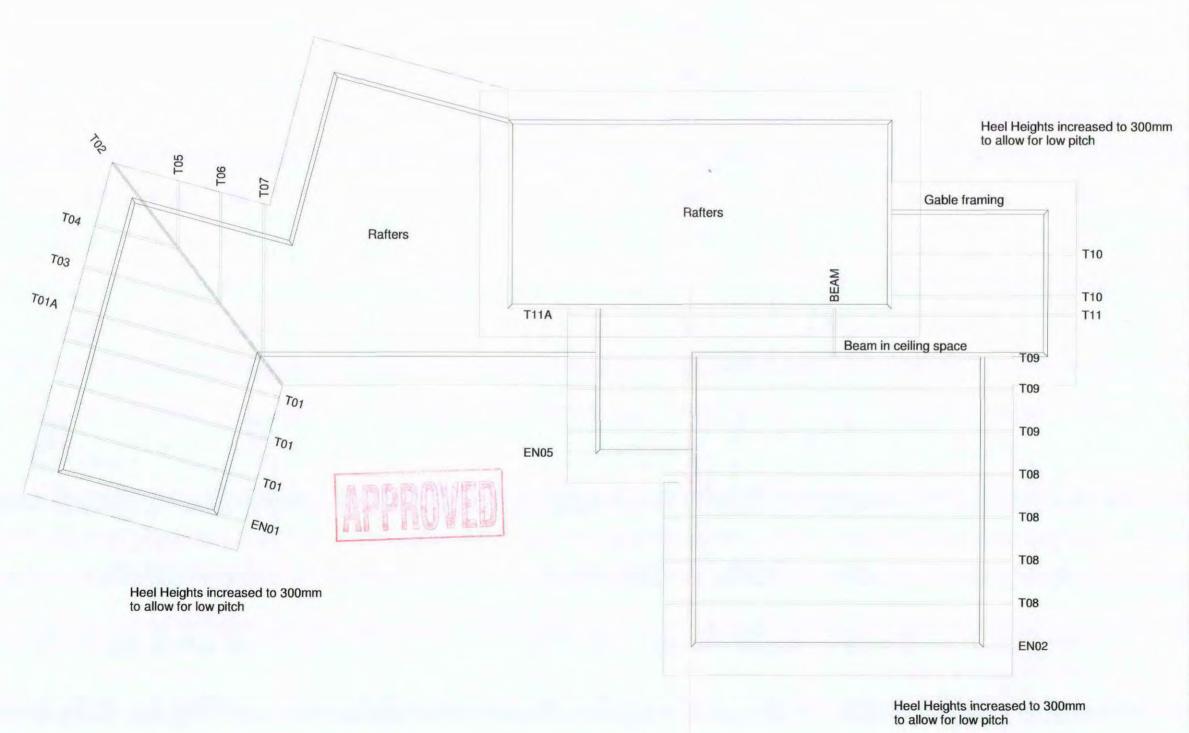

CARTERS

MANUFACTURING

26 Corbett Road New Plymouth. Ph. (06) 755 9190

JOB No **NP2164**

Client: Signature Homes

Job Name: Patterson & Sakamoto

Address: 475 Manawapou Road

Hawea

Pitch: 5°

Roof Material: Coloursteel
Soffit Overhang: 600 mm
Wind Area: High
Snow Load: 0 kPa

Trusses And Rafters At 900 Centres Unless Stated Otherwise.

This layout is to be read in conjunction with the Architectural plans.

DRAWN BY April Fletcher.

DATE 28/07/09

PAGE 1 of 2

BUILDING CONSENT INFORMATION

These layouts and associated design statements are provided as a means of showing compliance with NZBC and may be used for Building Consent Application purposes only. This is a Buildable layout which may have some dimensional changes completed at the time of truss manufacture.

As to be Built roof truss layouts, truss fixing details, point load notification, and a Producer Statement for the design of the roof trusses will be provided to the Local Authority at the time of manufacture.

All walls shown on this layout are considered to be load bearing.

These layouts and associated design statements are valid only if the job is manufactured by CARTERS.


TRUSS FIXINGS

Truss to Top Plate - 2 wire dogs Truss to Truss - Joist Hanger or alternatively as specified by CARTERS on the Final Layout



See Page 2 for Dimensions and Point Load notification

BUILDING CONSENT LAYOUT

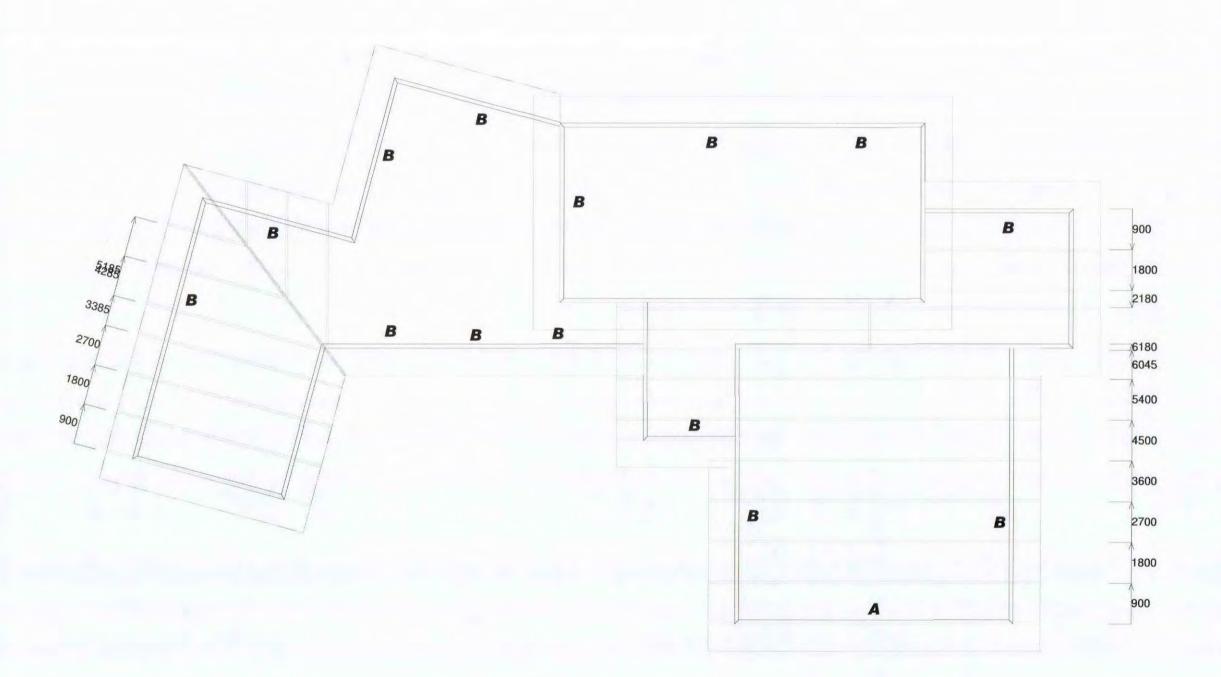

MANUFACTURING

26 Corbett Road New Plymouth Ph. (06) 755 9190

JOB No NP002164

Client: Signature Homes Job Name: Patterson & Sakamoto Address: 475 Manawapou Road

Hawea

Pitch: 5°

Roof Material: Coloursteel Soffit Overhang: 600 mm Wind Area: High Snow Load: 0 kPa

Trusses And Rafters At 900 Centres Unless Stated Otherwise.

This layout is to be read in conjunction with the Architectural plans.

DRAWN BY April Fletcher.

DATE 28/07/09

PAGE 2 of 2

These lintels have been sized using the GANGLAM 05/2005 and FLITCH BEAM 01/2001 selection manuals as provided by MiTek NZ Ltd.

HYSPAN and HY90 lintels have been sized using designIT v2.14NZ software or selection manuals, HYSPAN Edition 2 and HY90 Edition 1, as provided by CHH futurebuild.

Unless otherwise stated all lintels are to be selected as per NZS3604 1999.

All walls shown on this layout are considered to be load bearing.

	-
300 Hy90	
150 Hy90	

See Page 1 for Labelled Truss Layout



Name: Ross Patterson & Tsunako Sakamoto

Lot: 1, Dp399802

Address: 475 Manawapou Road

Hawea

A1	Cover Sheet	A12-A14	EFIS Cladding Detail
A2	General Layout	A15-A19	James Hardie Linea Weatherboard Detail
A3	Elevations	A20	Brick Cladding Detail
A4	3D Perspective Views	A21	Foundation Step Detail
A5	Drainage Layout		Cladding Junction Detail
A6	Foundation Layout		Soffit Flashing Detail
A7	Bracing Layout	A22	Stack Bond Brick Layout
A8	Site Layout		Chase Cut Detail
A9	Window & Ext. Door Schedule	A23	Floor Surface Layout
A10	Window & Ext. Door Shcedule	A24	Detail Sheet #1
A11	Typical Section	A25	Detail Sheet #2

BC090487 Revised 090811

Job Title:

Patterson & Sakamoto

Drawing Title:

Title

Site Address:

475 Manawapou Road Hawea

Job	
Drawn	Warren Clarke
Checked	
Scale	
Date	21 June 2009
Page	
Sheet Rev No.	

These drawings have been prepared on the understanding that the Building Contractor has a sound knowledge of the NZ Building Code and NZS 3604 -1999. The main Contractor, Sub Contractor or Authorised Agent of the owner or Builder shall ensure that all works comply with these Codes in addition to any requirements of the Territorial Authority. Any work undertaken outside these requirements without the prior written approval of the Designer, Engineer and/or the Territorial Authority hereby indemnifies the Designer or his Agent against any claim, or claims, in respect of the said work.

Notes:

 All Works to Comply with NZS3604-1999 and the NZ Building Code and Best Trade Practices.
 Building Code and Best Trade Practices.
 All Drawings to be Read Inconjunction with Engineers Drawings/Reports

c. The Contractor shall Supply and Fix all Necessary Flashing and Sealands to Provide a Completely Weather Tight Building.

d. Refer to All Written Notifications - Do Not Scale off Drawings

e. Check All Diam. and Verify All Levels on Site Prior Proceeding with Works or Ordering of Materials and Commencing Construction.

f. IF IN DOUBT - ASK


Signature Homes New Plymouth Ltd
201 Devon St East
New Plymouth

New Plymouth Ph: 06 769 9026 Fax: 06 769 9026

Copyright to these plans are entirely or partly owned by Signature Homes Ltd.

These plans are copyright of Signature Homes



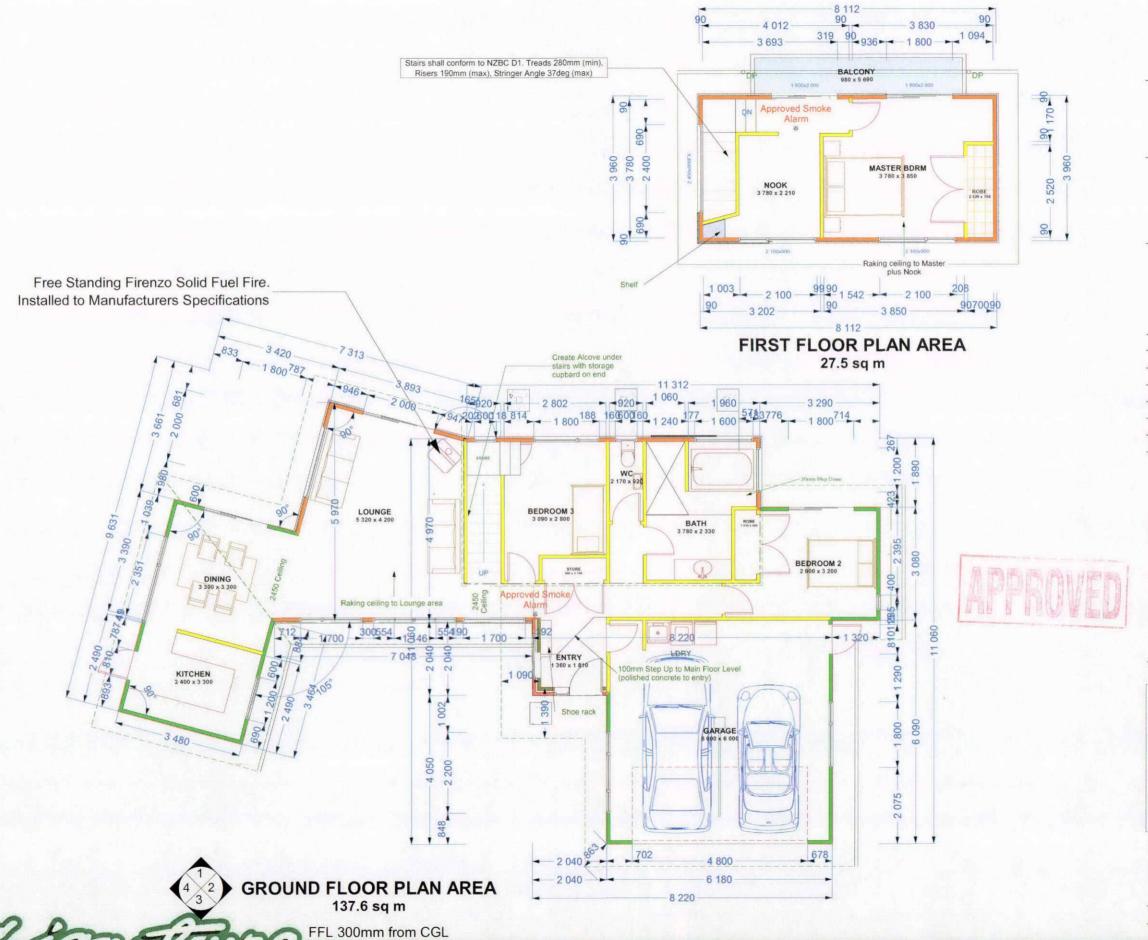

Job Title:

Patterson & Sakamoto

Drawing Title:

Floor Plan

Site Address:

475 Manawapou Road Hawea

Job	
Drawn	Warren Clarke
Checked	
Scale	1:100
Date	21 June 2009
Page	A2
Sheet Rev No.	


These drawings have been prepared on the understanding that the Building Contractor has a sound knowledge of the NZ Building Code and NZS 3604 -1999. The main Contractor, Sub Contractor or Authorised Agent of the owner or Builder shall ensure that all works comply with these Codes in addition to any requirements of the Territorial Authority. Any work undertaken outside these requirements without the prior written approval of the Designer, Engineer and/or the Territorial Authority hereby indemnifies the Designer or his Agent against any claim, or claims, in respect of the said work.

Notes:

a. All Works to Comply with NZS3604-1999 and the NZ Building Code and Best Trade Practices.

- b. All Drawings to be Read Inconjunction with Engineers Drawings/Reports
- c. The Contractor shall Supply and Fix all Necessary Flashing and Sealands to Provide a Completely Weather Tight Building.
- d. Refer to All Written Notifications Do Not Scale off Drawings
- e. Check All Diam. and Verify All Levels on Site Prior Proceeding with Works or Ordering of Materials and Commencing Construction. f. IF IN DOUBT - ASK

Signature Homes New Plymouth Ltd 201 Devon St East New Plymouth Ph: 06 769 9026 Fax: 06 769 9026 Copyright to these plans are entirely or partly owned by Signature Homes Ltd.

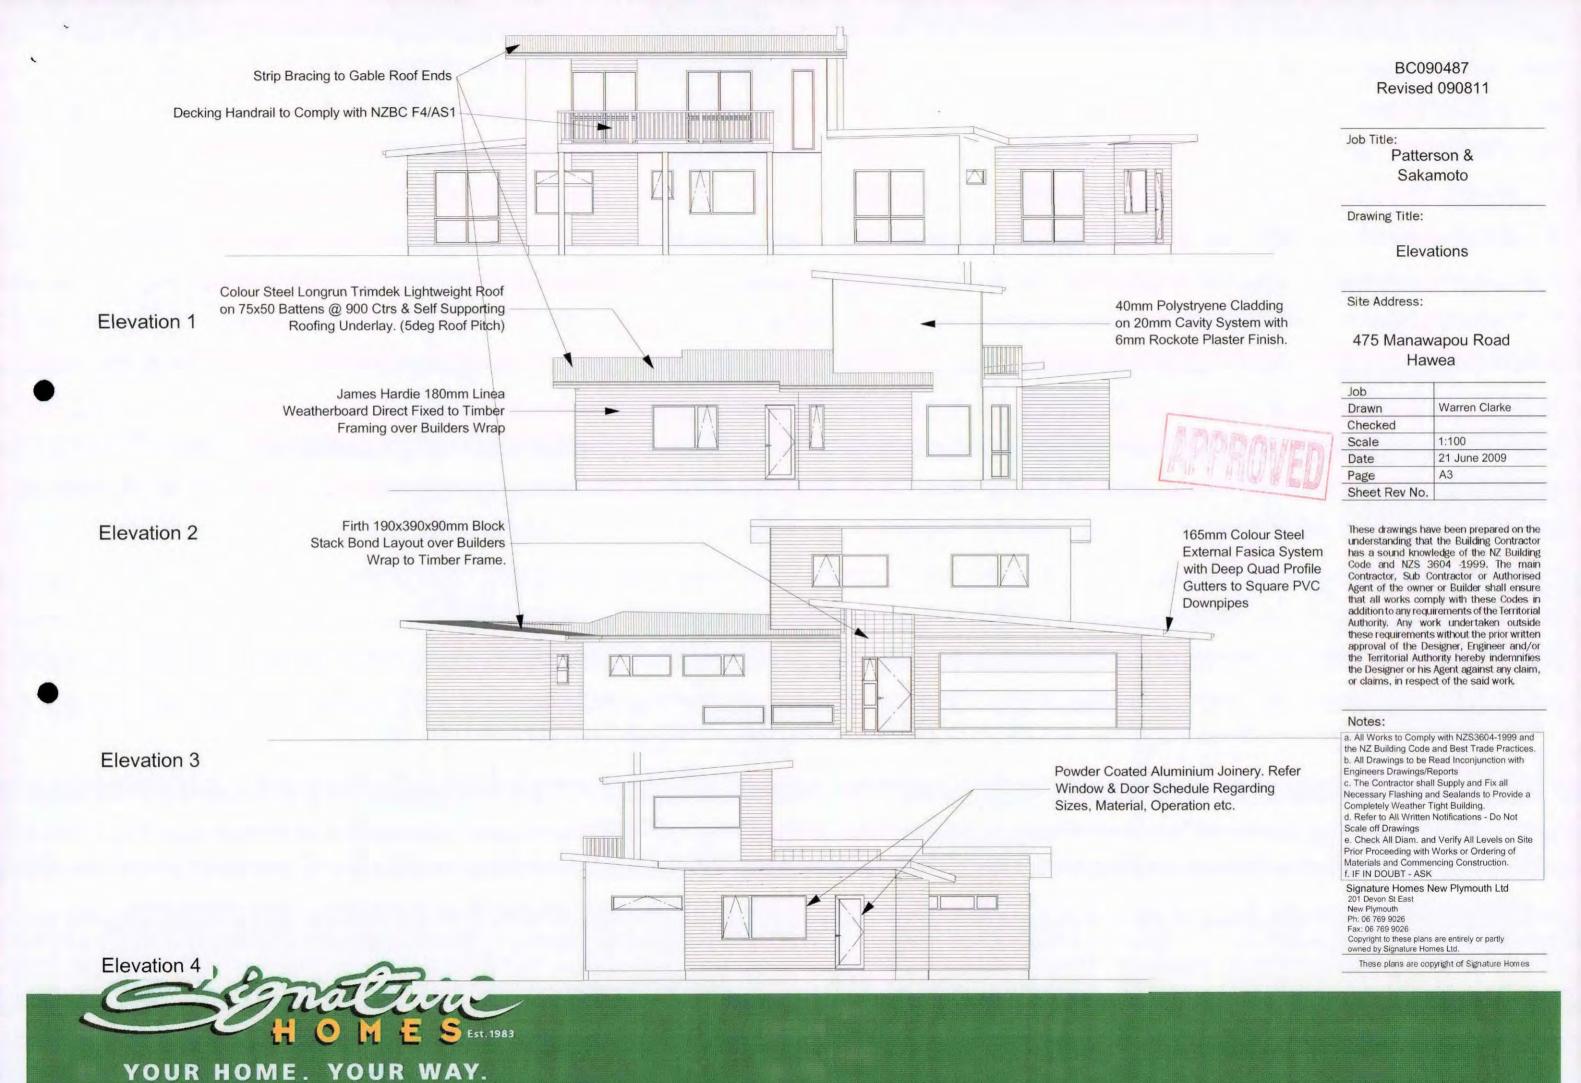



Job Title:

Patterson & Sakamoto

Drawing Title:

Perspectives

Site Address:

475 Manawapou Road Hawea

Job	
Drawn	Warren Clarke
Checked	
Scale	Not to Scale
Date	21 June 2009
Page	A4
Sheet Rev No.	

These drawings have been prepared on the understanding that the Building Contractor has a sound knowledge of the NZ Building Code and NZS 3604 -1999. The main Contractor, Sub Contractor or Authorised Agent of the owner or Builder shall ensure that all works comply with these Codes in addition to any requirements of the Territorial Authority. Any work undertaken outside these requirements without the prior written approval of the Designer, Engineer and/or the Territorial Authority hereby indemnifies the Designer or his Agent against any claim, or claims, in respect of the said work.

Notes:

a. All Works to Comply with NZS3604-1999 and the NZ Building Code and Best Trade Practices. b. All Drawings to be Read Inconjunction with

Engineers Drawings/Reports c. The Contractor shall Supply and Fix all

Necessary Flashing and Sealands to Provide a Completely Weather Tight Building. d. Refer to All Written Notifications - Do Not

Scale off Drawings

e. Check All Diam. and Verify All Levels on Site Prior Proceeding with Works or Ordering of Materials and Commencing Construction. f. IF IN DOUBT - ASK

Signature Homes New Plymouth Ltd

201 Devon St East New Plymouth Ph: 06 769 9026

Fax: 06 769 9026

Copyright to these plans are entirely or partly owned by Signature Homes Ltd.

These plans are copyright of Signature Homes



Job Title:

Patterson & Sakamoto

Drawing Title:

Drainage Layout

Site Address:

475 Manawapou Road Hawea

Job	
Drawn	Warren Clarke
Checked	
Scale	1:100
Date	21 June 2009
Page	A5
Sheet Rev No.	

These drawings have been prepared on the understanding that the Building Contractor has a sound knowledge of the NZ Building Code and NZS 3604 -1999. The main Contractor, Sub Contractor or Authorised Agent of the owner or Builder shall ensure that all works comply with these Codes in addition to any requirements of the Territorial Authority. Any work undertaken outside these requirements without the prior written approval of the Designer, Engineer and/or the Territorial Authority hereby indemnifies the Designer or his Agent against any claim, or claims, in respect of the said work.

Notes:

a. All Works to Comply with NZS3604-1999 and the NZ Building Code and Best Trade Practices. b. All Drawings to be Read Inconjunction with

Engineers Drawings/Reports c. The Contractor shall Supply and Fix all

Necessary Flashing and Sealands to Provide a Completely Weather Tight Building.

d. Refer to All Written Notifications - Do Not Scale off Drawings

e. Check All Diam. and Verify All Levels on Site Prior Proceeding with Works or Ordering of Materials and Commencing Construction.


f. IF IN DOUBT - ASK Signature Homes New Plymouth Ltd

201 Devon St East New Plymouth

Ph: 06 769 9026 Fax: 06 769 9026

Copyright to these plans are entirely or partly owned by Signature Homes Ltd.

These plans are copyright of Signature Homes

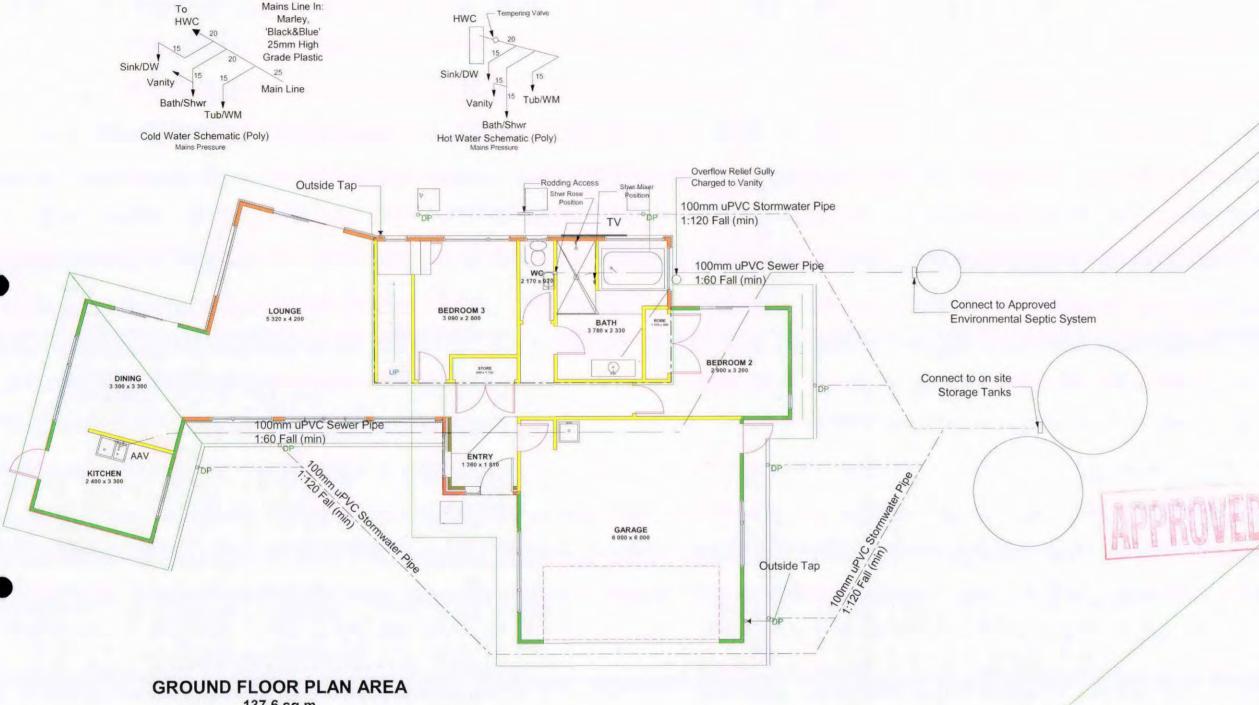

137.6 sq m

All Plumbing Work shall be carried out by Registered Plumbers and such work shall comply in every respect with the requirements of the New Zealand Building Code. All water supply pipework and fittings shall also comply with the New Zealand Building Code: AS/NZS 3500.2.2 & G12/ AS1 Tables 4 & 5 regarding pipe sizing.

Waste Water Sizes:

Washhand Basin 1:40 Fall (min) 40mm 40mm

Kitchen Sink & Dishwasher 1:40 Fall (min) Laundry Tubs & Washing Machine 1:40 Fall (min)

40mm 40mm Bath & Showers 1:40 Fall (min)

WC 1:60 Fall (min) Below Floor Level 1:40 Fall (min) Name: Lot:


Address:

Patterson & Sakamoto

Lot 1, Dp399802

475 Manawapou Road, Hawea

100mm

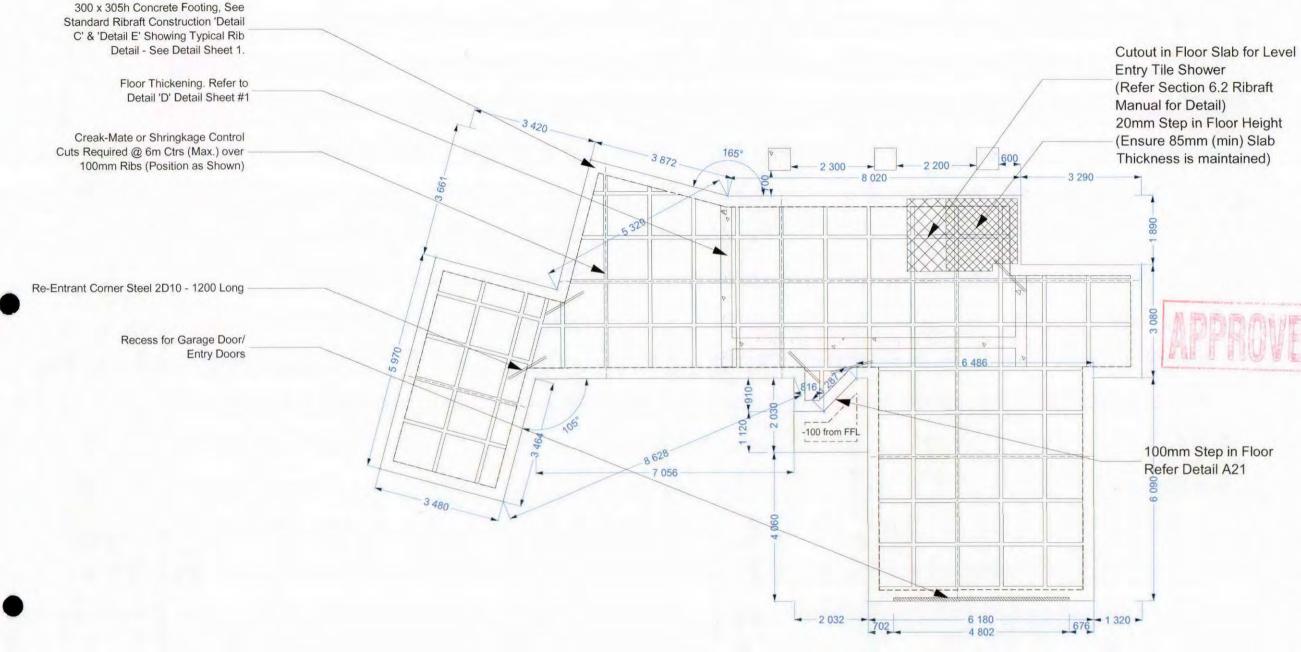

Job Title

Patterson & Sakamoto

Drawing Title:

Foundation Layout

Site Address:

475 Manawapou Road Hawea

Job	A. T. T.
Drawn	Warren Clarke
Checked	
Scale	1:100
Date	21 June 2009
Page	A6
Sheet Rev No.	

These drawings have been prepared on the understanding that the Building Contractor has a sound knowledge of the NZ Building Code and NZS 3604 1999. The main Contractor, Sub Contractor or Authorised Agent of the owner or Builder shall ensure that all works comply with these Codes in addition to any requirements of the Territorial Authority. Any work undertaken outside these requirements without the prior written approval of the Designer, Engineer and/or the Territorial Authority hereby indemnifies the Designer or his Agent against any claim, or claims, in respect of the said work.

Notes:

Concrete Strength:

Refer to:

NZS 3109 & NZS3124

for Ribraft Clarification.

Opus Central Laboratories

Appraisal Certificate No. 1999/22

Shall be Raftmix Pump - a 20MPa slump pump

mix of either 13mm or 19mm Aggregate size, at

28 days Standard Cured, as Specified in

 a. All Works to Comply with NZS3604-1999 and the NZ Building Code and Best Trade Practices. b. All Drawings to be Read Inconjunction with Engineers Drawings/Reports

c. The Contractor shall Supply and Fix all Necessary Flashing and Sealands to Provide a Completely Weather Tight Building.

d. Refer to All Written Notifications - Do Not Scale off Drawings

e. Check All Diam. and Verify All Levels on Site Prior Proceeding with Works or Ordering of Materials and Commencing Construction. f. IF IN DOUBT - ASK

Signature Homes New Plymouth Ltd 201 Devon St East New Plymouth

New Plymouth Ph: 06 769 9026 Fax: 06 769 9026


Copyright to these plans are entirely or partly owned by Signature Homes Ltd.

These plans are copyright of Signature Homes

FFL 300mm from CGL

Measurements Supplied are Only an Indication - Always Refer to Carters Supplied Foundation Layout for Correct Framing Measurements.

HOME S Est. 1983

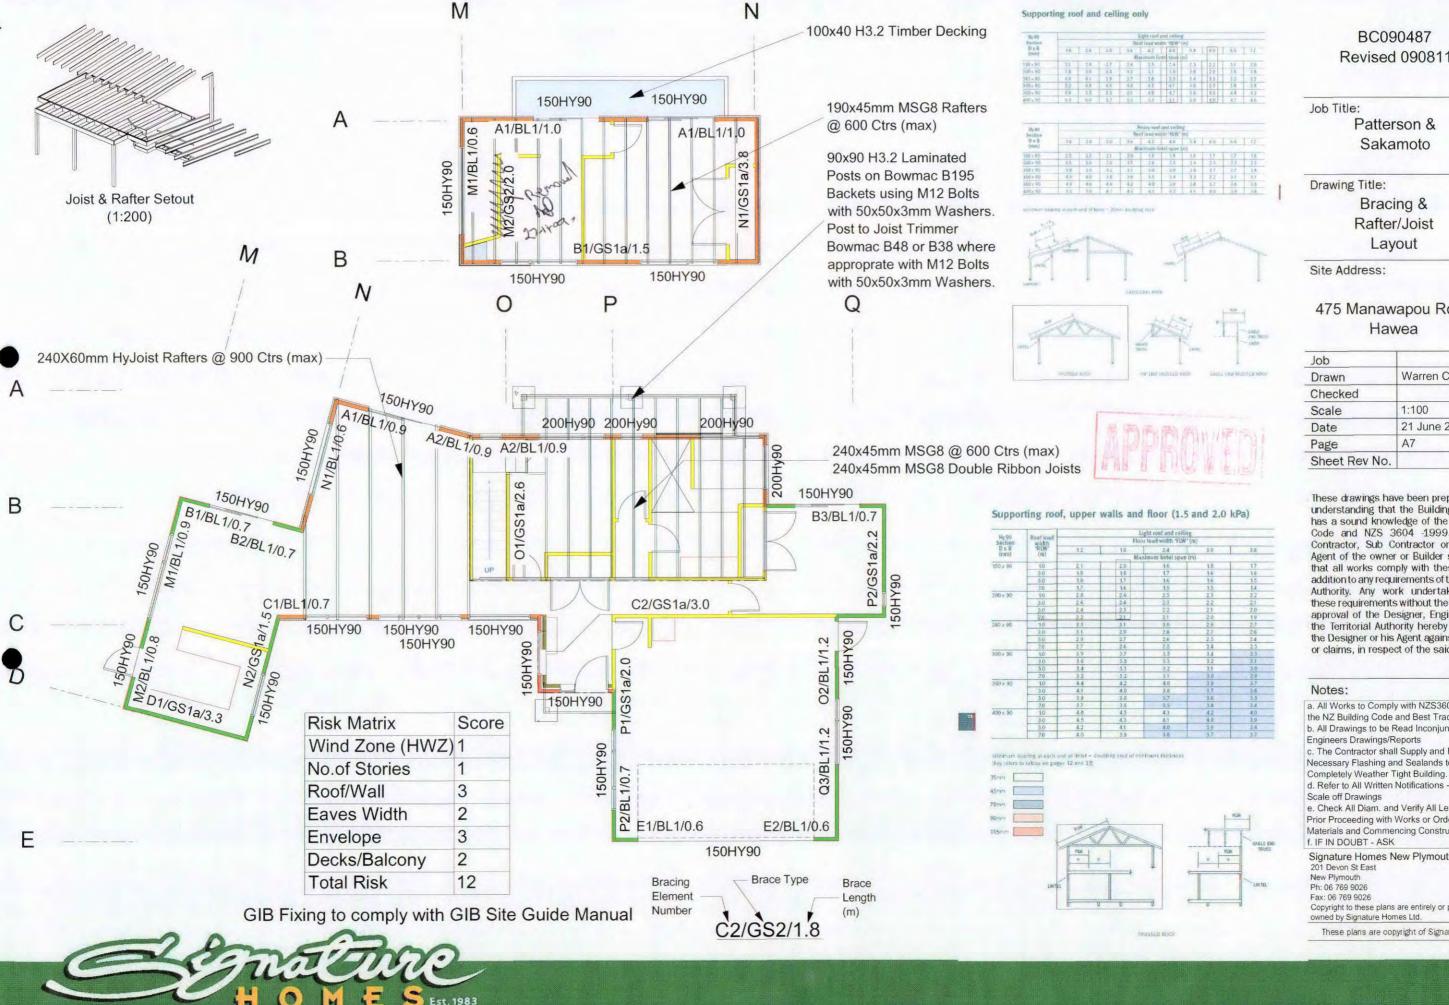

Revised 090811

Patterson & Sakamoto

475 Manawapou Road

Job	
Drawn	Warren Clarke
Checked	
Scale	1:100
Date	21 June 2009
Page	A7
Sheet Rev No.	

These drawings have been prepared on the understanding that the Building Contractor has a sound knowledge of the NZ Building Code and NZS 3604 1999. The main Contractor, Sub Contractor or Authorised Agent of the owner or Builder shall ensure that all works comply with these Codes in addition to any requirements of the Territorial Authority. Any work undertaken outside these requirements without the prior written approval of the Designer, Engineer and/or the Territorial Authority hereby indemnifies the Designer or his Agent against any claim, or claims, in respect of the said work.

a. All Works to Comply with NZS3604-1999 and the NZ Building Code and Best Trade Practices b. All Drawings to be Read Inconjunction with


c. The Contractor shall Supply and Fix all Necessary Flashing and Sealands to Provide a

d. Refer to All Written Notifications - Do Not

e. Check All Diam. and Verify All Levels on Site Prior Proceeding with Works or Ordering of Materials and Commencing Construction.

Signature Homes New Plymouth Ltd

Copyright to these plans are entirely or partly

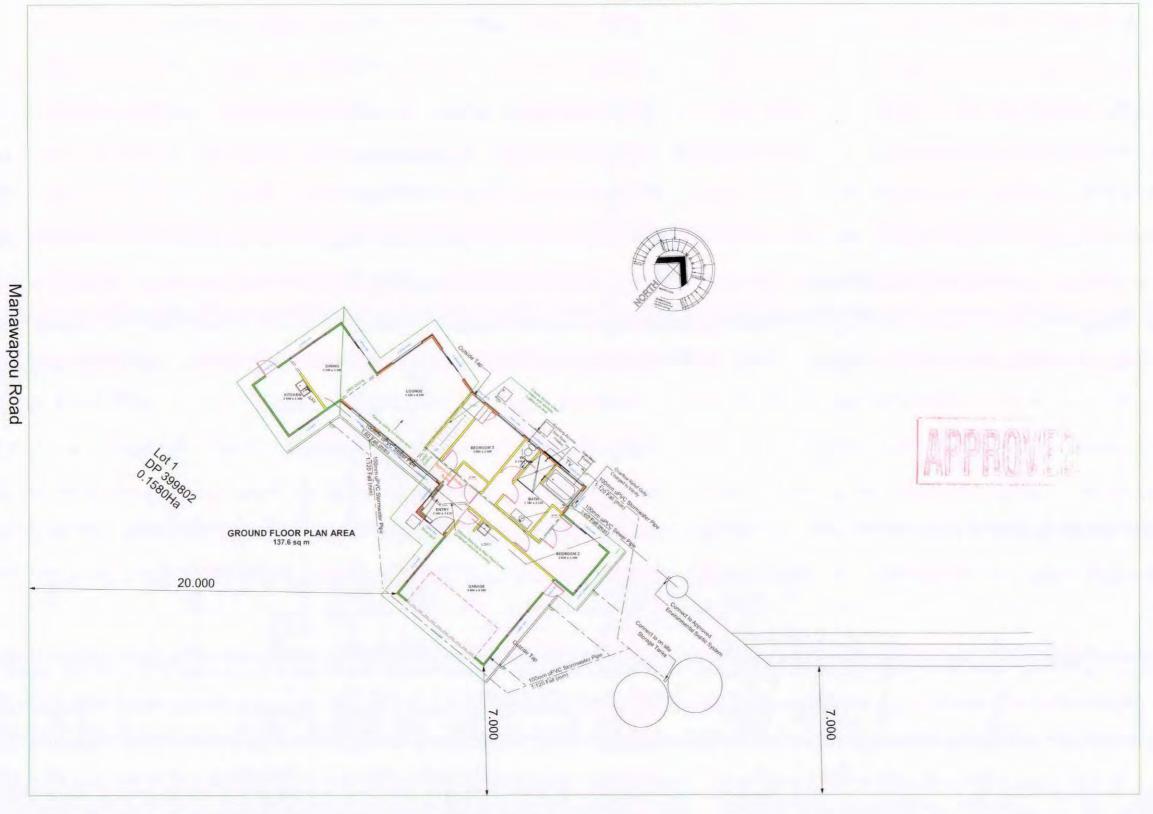

Job Title:

Patterson & Sakamoto

Drawing Title:

Site Layout

Site Address:

475 Manawapou Road Hawea

Job	
Drawn	Warren Clarke
Checked	
Scale	1:200
Date	21 June 2009
Page	
Sheet Rev No.	A8

These drawings have been prepared on the understanding that the Building Contractor has a sound knowledge of the NZ Building Code and NZS 3604 -1999. The main Contractor, Sub Contractor or Authorised Agent of the owner or Builder shall ensure that all works comply with these Codes in addition to any requirements of the Territorial Authority. Any work undertaken outside these requirements without the prior written approval of the Designer, Engineer and/or the Territorial Authority hereby indemnifies the Designer or his Agent against any claim, or claims, in respect of the said work.

Notes:

a. All Works to Comply with NZS3604-1999 and the NZ Building Code and Best Trade Practices.

b. All Drawings to be Read Inconjunction with Engineers Drawings/Reports

c. The Contractor shall Supply and Fix all Necessary Flashing and Sealands to Provide a Completely Weather Tight Building.

d. Refer to All Written Notifications - Do Not Scale off Drawings


e. Check All Diam. and Verify All Levels on Site Prior Proceeding with Works or Ordering of Materials and Commencing Construction. f. IF IN DOUBT - ASK

Signature Homes New Plymouth Ltd 201 Devon St East New Plymouth Ph: 06 769 9026

Fax: 06 769 9026

Copyright to these plans are entirely or partly owned by Signature Homes Ltd.



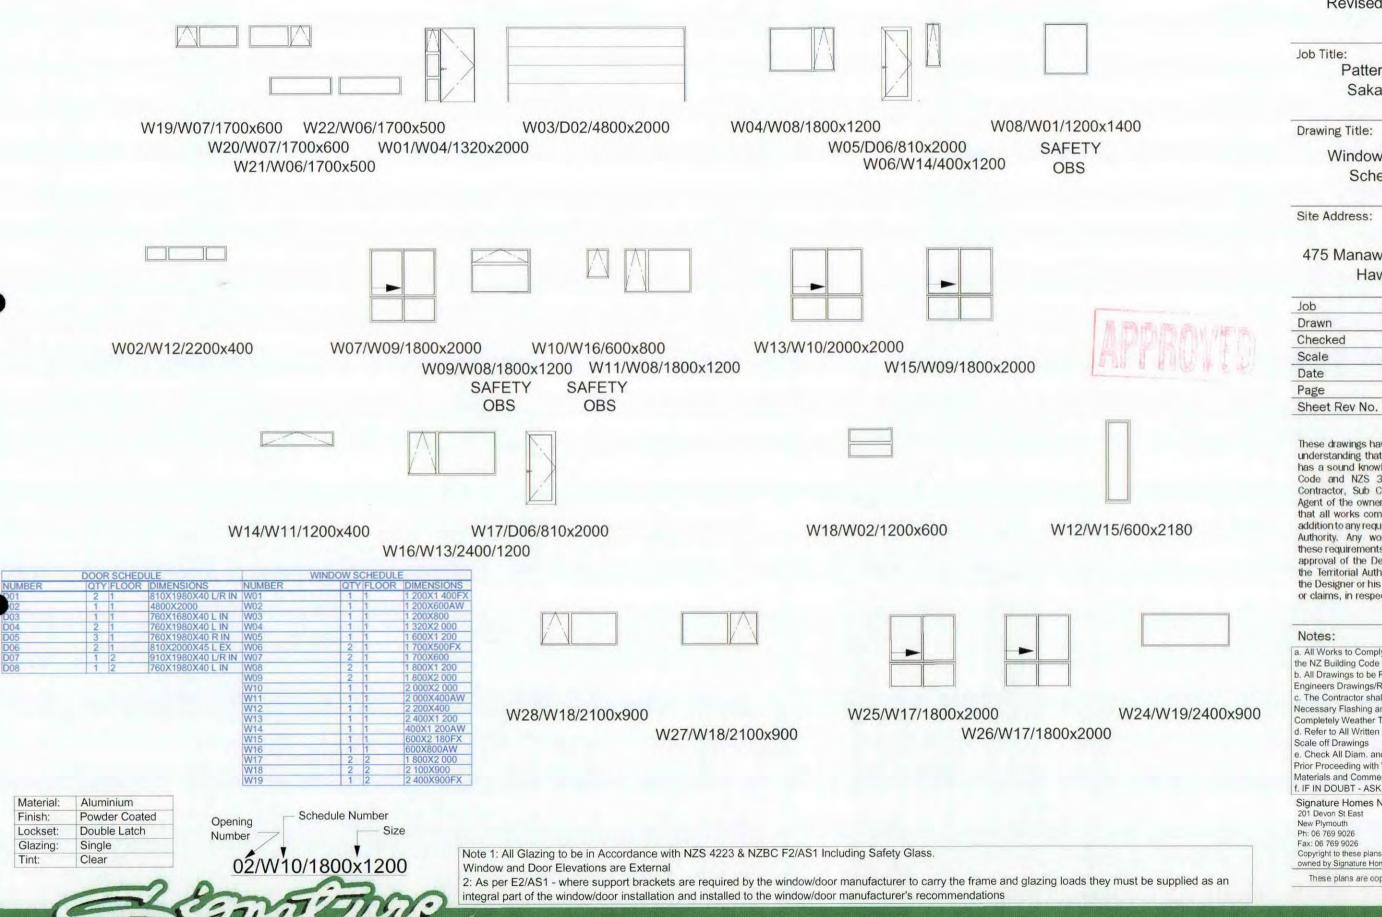

YOUR HOME. YOUR WAY.

BC090487 Revised 090811

Job Title:

Patterson & Sakamoto

Drawing Title:

Window & Door Schedule

Site Address:

475 Manawapou Road Hawea

Job	
Drawn	Warren Clarke
Checked	
Scale	1:100
Date	21 June 2009
Page	
Sheet Rev No.	A9

These drawings have been prepared on the understanding that the Building Contractor has a sound knowledge of the NZ Building Code and NZS 3604 -1999. The main Contractor, Sub Contractor or Authorised Agent of the owner or Builder shall ensure that all works comply with these Codes in addition to any requirements of the Territorial Authority. Any work undertaken outside these requirements without the prior written approval of the Designer, Engineer and/or the Territorial Authority hereby indemnifies the Designer or his Agent against any claim, or claims, in respect of the said work.

Notes:

a. All Works to Comply with NZS3604-1999 and the NZ Building Code and Best Trade Practices. b. All Drawings to be Read Inconjunction with

Engineers Drawings/Reports

c. The Contractor shall Supply and Fix all Necessary Flashing and Sealands to Provide a Completely Weather Tight Building.


d. Refer to All Written Notifications - Do Not Scale off Drawings


e. Check All Diam. and Verify All Levels on Site Prior Proceeding with Works or Ordering of Materials and Commencing Construction.


Signature Homes New Plymouth Ltd 201 Devon St East

New Plymouth Ph: 06 769 9026 Fax: 06 769 9026

Copyright to these plans are entirely or partly owned by Signature Homes Ltd.

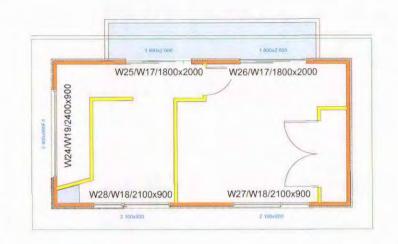

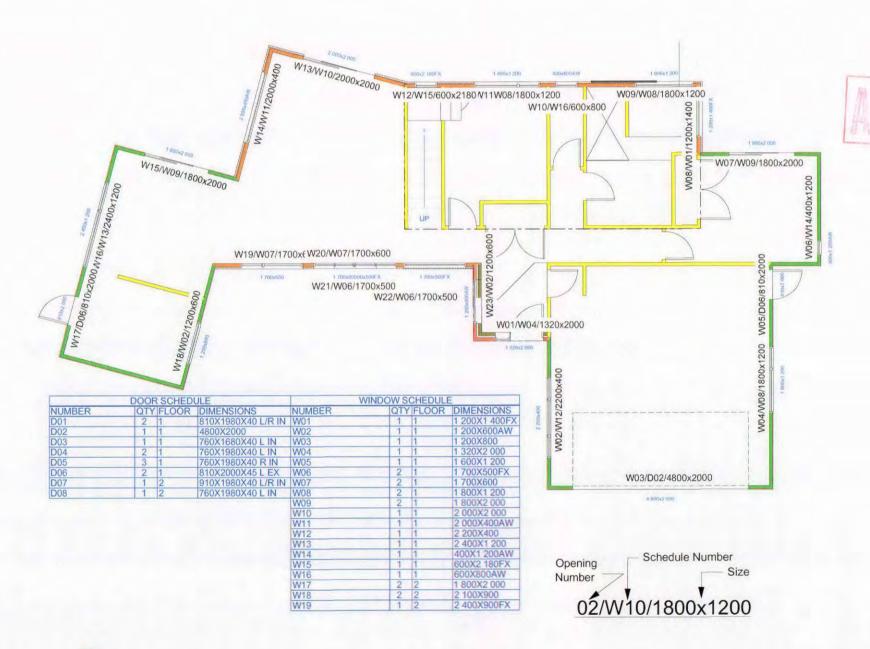

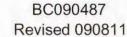

Job Title:

Patterson & Sakamoto

Drawing Title:

Window & Door Schedule

Site Address:

475 Manawapou Road Hawea

Job	
Drawn	Warren Clarke
Checked	
Scale	1:100
Date	21 June 2009
Page	
Sheet Rev No.	

These drawings have been prepared on the understanding that the Building Contractor has a sound knowledge of the NZ Building Code and NZS 3604 -1999. The main Contractor, Sub Contractor or Authorised Agent of the owner or Builder shall ensure that all works comply with these Codes in addition to any requirements of the Territorial Authority. Any work undertaken outside these requirements without the prior written approval of the Designer, Engineer and/or the Territorial Authority hereby indemnifies the Designer or his Agent against any claim, or claims, in respect of the said work.

Notes:

 a. All Works to Comply with NZS3604-1999 and the NZ Building Code and Best Trade Practices.
 b. All Drawings to be Read Inconjunction with

Engineers Drawings/Reports
c. The Contractor shall Supply and Fix all

Necessary Flashing and Sealands to Provide a Completely Weather Tight Building.
d. Refer to All Written Notifications - Do Not

d. Refer to All Written Notifications - Do Scale off Drawings


e. Check All Diam. and Verify All Levels on Site Prior Proceeding with Works or Ordering of Materials and Commencing Construction. f. IF IN DOUBT - ASK

Signature Homes New Plymouth Ltd 201 Devon St East New Plymouth Ph: 06 769 9026 Fax: 06 769 9026 Copyright to these plans are entirely or partly

owned by Signature Homes Ltd.

These plans are copyright of Signature Homes



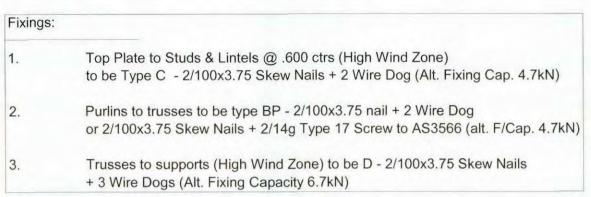

Coloursteel Longrun Trimdek Lightweight Roof on 75x50 Battens @ 900 Ctrs & Heavy Duty Self Supporting Roofing Underlay. (5deg Roof Pitch)

Proprietary Roof Trusses @ 900 Ctrs Max. Truss Manufacture to Supply Truss Layout/ Design Data & Certification.

R3.2 Pink Batt Ceiling Insulation.

R2.2 Pink Batt Wall Insulation.

165mm Colour Steel Facia with Deep Quad Spouting, to PVC Downpipes


James Hardi Linea Weatherboard Direct Fixed to Timber Frame over Builders Wrap or 40mm Polystyrene over 20mm Cavity Batten System to Timber Frame overWatergate II Heavy Duty Builders Wrap, Where indicated on Elevations.

> Chemset M12 Bolts & 50x50x3 Washer @ 900 Ctres (Max) 300 min. from Corner or Change of Direction.

Timber Schedule

External Wall Framing 90x45 (H3.1) Kiln Dried MSG8
Internal Wall Framing 90x45 (Chem Free) Kiln Dried MSG8
Roof Framing & Grusses (H1.2) Kiln Dried MSG8
Roof Battons 70x35 (H1.2) Dried MSG8
Lintels HY90 Except 90x90 (H3.1) Kiln Dried MSG8

All Unpaved Areas to be 225mm Below FFL (min)
All Paved Areas to be 150mm Below FFL (min)

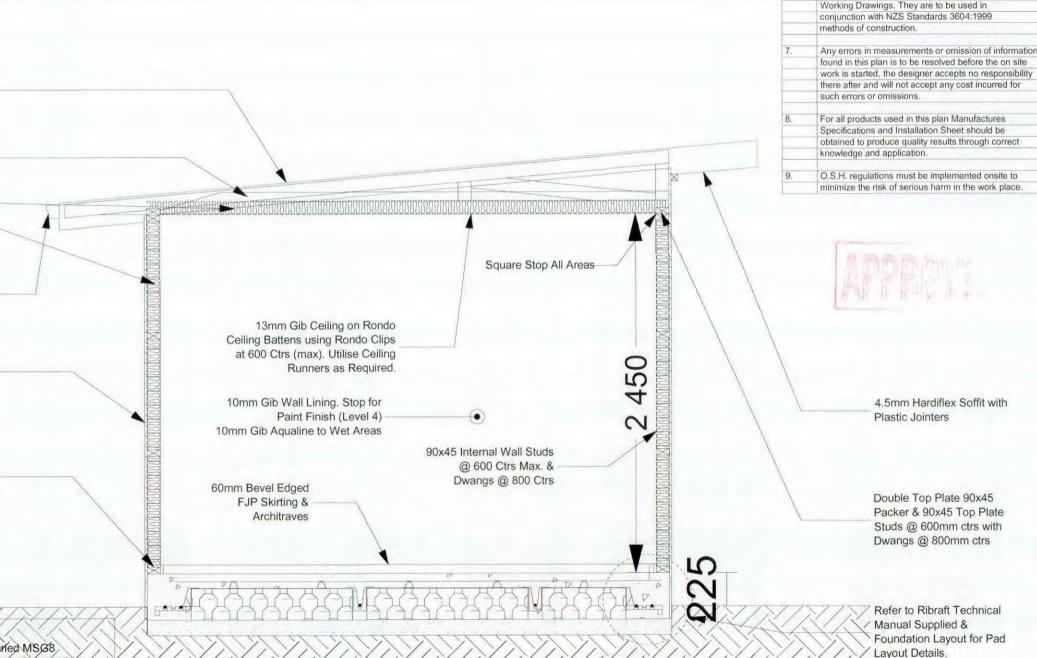

BC090487 Revised 090811

Job Title:

All work shall comply with NZS 3604:1999

"If you do not know ASK"

and standard of workmanship

All work shall comply with B.I.A. NZ Building Code.

Builder to notify council inspector when stages of

Check detail working plans for accurate diamentions

All subcontractors or their management are required

to have their work inspected and checked by the building contractor for the practical completion

This plan is designed with the intent to supply the

required information & details for Building Consent &

Patterson & Sakamoto

Drawing Title:

Typical Cross Section

Site Address:

475 Manawapou Road Hawea

Job	
Drawn	Warren Clarke
Checked	
Scale	1:25
Date	21 June 2009
Page	A11
Sheet Rev No.	

These drawings have been prepared on the understanding that the Building Contractor has a sound knowledge of the NZ Building Code and NZS 3604 -1999. The main Contractor, Sub Contractor or Authorised Agent of the owner or Builder shall ensure that all works comply with these Codes in addition to any requirements of the Territorial Authority. Any work undertaken outside these requirements without the prior written approval of the Designer, Engineer and/or the Territorial Authority hereby indemnifies the Designer or his Agent against any claim, or claims, in respect of the said work.

Notes:

 a. All Works to Comply with NZS3604-1999 and the NZ Building Code and Best Trade Practices.
 b. All Drawings to be Read Inconjunction with Engineers Drawings/Reports

c. The Contractor shall Supply and Fix all Necessary Flashing and Sealands to Provide a Completely Weather Tight Building.


d. Refer to All Written Notifications - Do Not Scale off Drawings

e. Check All Diam. and Verify All Levels on Site Prior Proceeding with Works or Ordering of Materials and Commencing Construction. f. IF IN DOUBT - ASK

Signature Homes New Plymouth Ltd 201 Devon St East New Plymouth Ph: 06 769 9026 Fax: 06 769 9026 Copyright to these plans are entirely or partly

owned by Signature Homes Ltd.



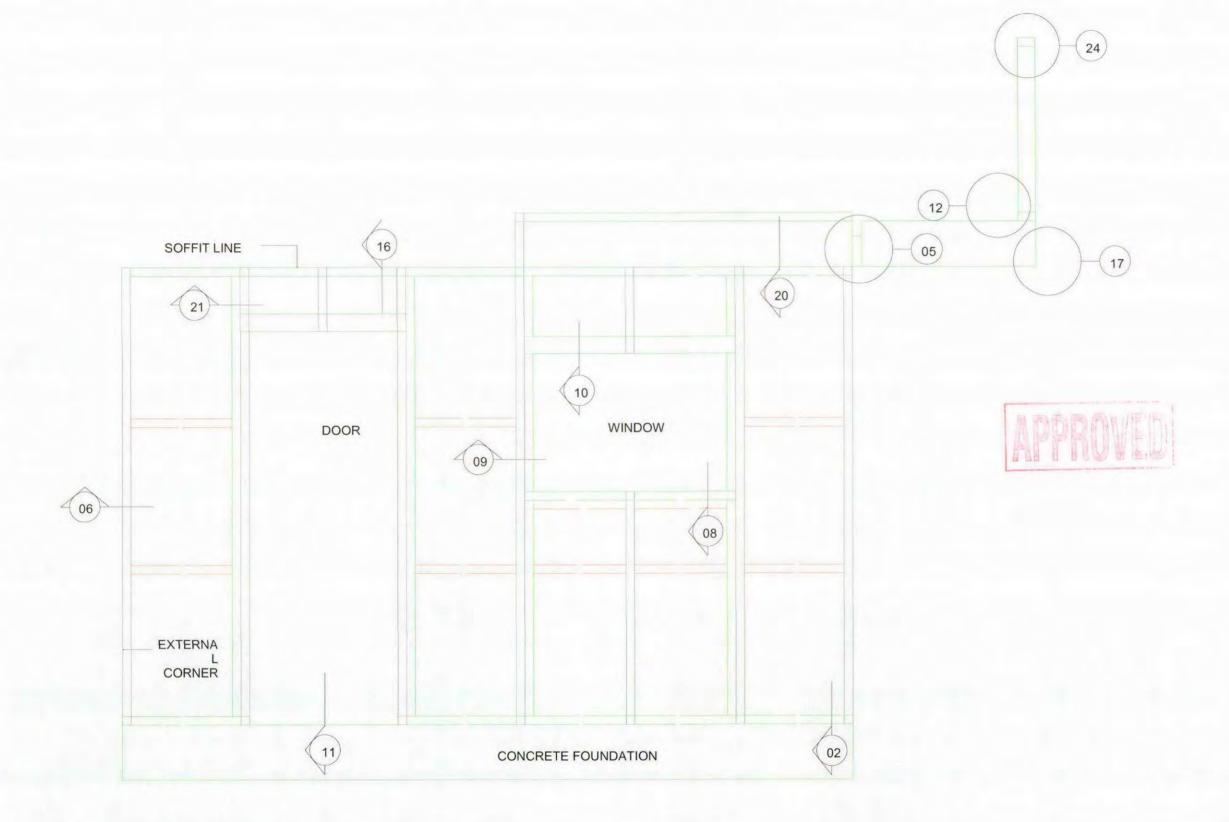

Job Title:

Patterson & Sakamoto

Drawing Title:

Site Address:

475 Manawapou Road Hawea

Job	
Drawn	Warren Clarke
Checked	
Scale	
Date	21 June 2009
Page	A12
Sheet Rev No.	

These drawings have been prepared on the understanding that the Building Contractor has a sound knowledge of the NZ Building Code and NZS 3604 -1999. The main Contractor, Sub Contractor or Authorised Agent of the owner or Builder shall ensure that all works comply with these Codes in addition to any requirements of the Territorial Authority. Any work undertaken outside these requirements without the prior written approval of the Designer, Engineer and/or the Territorial Authority hereby indemnifies the Designer or his Agent against any claim, or claims, in respect of the said work.

Notes:

a. All Works to Comply with NZS3604-1999 and the NZ Building Code and Best Trade Practices.
 b. All Drawings to be Read Inconjunction with

Engineers Drawings/Reports
c. The Contractor shall Supply and Fix all
Necessary Flashing and Sealands to Provide a

Completely Weather Tight Building. d. Refer to All Written Notifications - Do Not

d. Refer to All Written Notific Scale off Drawings

e. Check All Diam. and Verify All Levels on Site Prior Proceeding with Works or Ordering of Materials and Commencing Construction. f. IF IN DOUBT - ASK

Signature Homes New Plymouth Ltd 201 Devon St East New Plymouth Ph: 06 769 9026 Fax: 06 769 9026

Copyright to these plans are entirely or partly owned by Signature Homes Ltd.

These plans are copyright of Signature Homes



Job Title:

Patterson & Sakamoto

Drawing Title:

Site Address:

475 Manawapou Road Hawea

Job	
Drawn	Warren Clarke
Checked	
Scale	
Date	21 June 2009
Page	A13
Sheet Rev No.	

These drawings have been prepared on the understanding that the Building Contractor has a sound knowledge of the NZ Building Code and NZS 3604 -1999. The main Contractor, Sub Contractor or Authorised Agent of the owner or Builder shall ensure that all works comply with these Codes in addition to any requirements of the Territorial Authority. Any work undertaken outside these requirements without the prior written approval of the Designer, Engineer and/or the Territorial Authority hereby indemnifies the Designer or his Agent against any claim, or claims, in respect of the said work.

a. All Works to Comply with NZS3604-1999 and the NZ Building Code and Best Trade Practices. b. All Drawings to be Read Inconjunction with

Engineers Drawings/Reports

c. The Contractor shall Supply and Fix all Necessary Flashing and Sealands to Provide a Completely Weather Tight Building.

d. Refer to All Written Notifications - Do Not Scale off Drawings

e. Check All Diam. and Verify All Levels on Site Prior Proceeding with Works or Ordering of Materials and Commencing Construction.


f. IF IN DOUBT - ASK

Signature Homes New Plymouth Ltd

201 Devon St East New Plymouth Ph: 06 769 9026


Fax: 06 769 9026 Copyright to these plans are entirely or partly owned by Signature Homes Ltd.

These plans are copyright of Signature Homes

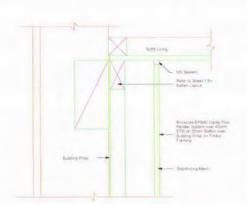



Soffit Detail

Roof Apron Detail

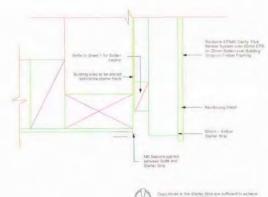

Soffit Detail

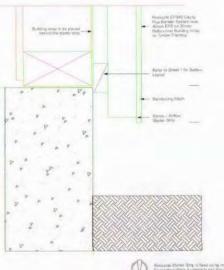


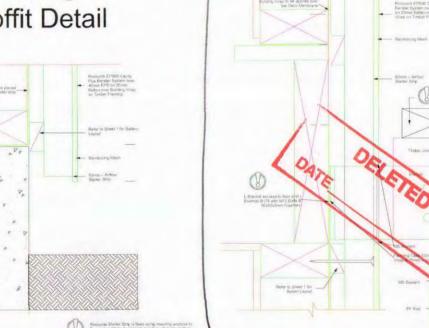

Deck Penetration

Detail

Foundation Detail

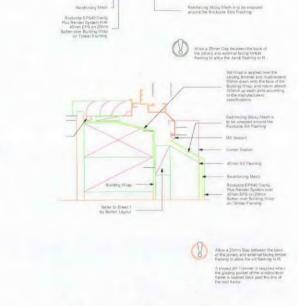


Window Details




Related Sheet 7 for Bate to contract to be sheet for Bate to sheet 7 for Bate 1 for Sheet 7 for Sheet 7 for Bate 1 for Sheet 7 for Bate 1 for Sheet 7 for

Brick to Poly Junction Detail

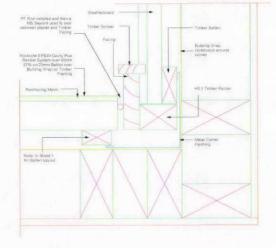


Weatherboard to Poly Junction Detail

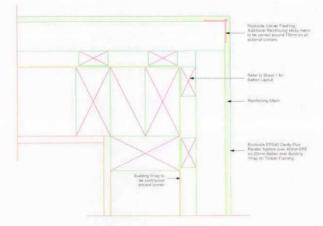


External Corner
Detail




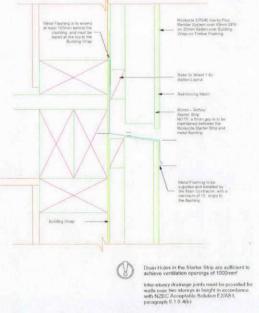

Inter Story
Drainage Joint

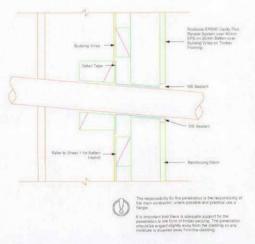

Pipe Penetration Detail

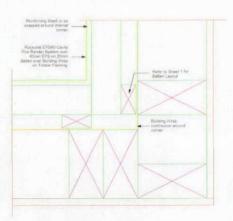

Internal Corner Detail

BC090487 Revised 090811

Job Title:

Patterson & Sakamoto

Drawing Title:

Site Address:

475 Manawapou Road Hawea

Job	
Drawn	Warren Clarke
Checked	
Scale	
Date	21 June 2009
Page	A14
Sheet Rev No.	

These drawings have been prepared on the understanding that the Building Contractor has a sound knowledge of the NZ Building Code and NZS 3604 -1999. The main Contractor, Sub Contractor or Authorised Agent of the owner or Builder shall ensure that all works comply with these Codes in addition to any requirements of the Territorial Authority. Any work undertaken outside these requirements without the prior written approval of the Designer, Engineer and/or the Territorial Authority hereby indemnifies the Designer or his Agent against any claim, or claims, in respect of the said work.

Notes:

 a. All Works to Comply with NZS3604-1999 and the NZ Building Code and Best Trade Practices.
 b. All Drawings to be Read Inconjunction with

Engineers Drawings/Reports

c. The Contractor shall Supply and Fix all Necessary Flashing and Sealands to Provide a Completely Weather Tight Building.

d. Refer to All Written Notifications - Do Not Scale off Drawings

e. Check All Diam. and Verify All Levels on Site Prior Proceeding with Works or Ordering of Materials and Commencing Construction.

Prior Proceeding with Works or Ordering of Materials and Commencing Construction. f. IF IN DOUBT - ASK


Signature Homes New Plymouth Ltd 201 Devon St East

New Plymouth Ph: 06 769 9026

Ph: 06 769 9026 Fax: 06 769 9026

Copyright to these plans are entirely or partly owned by Signature Homes Ltd.



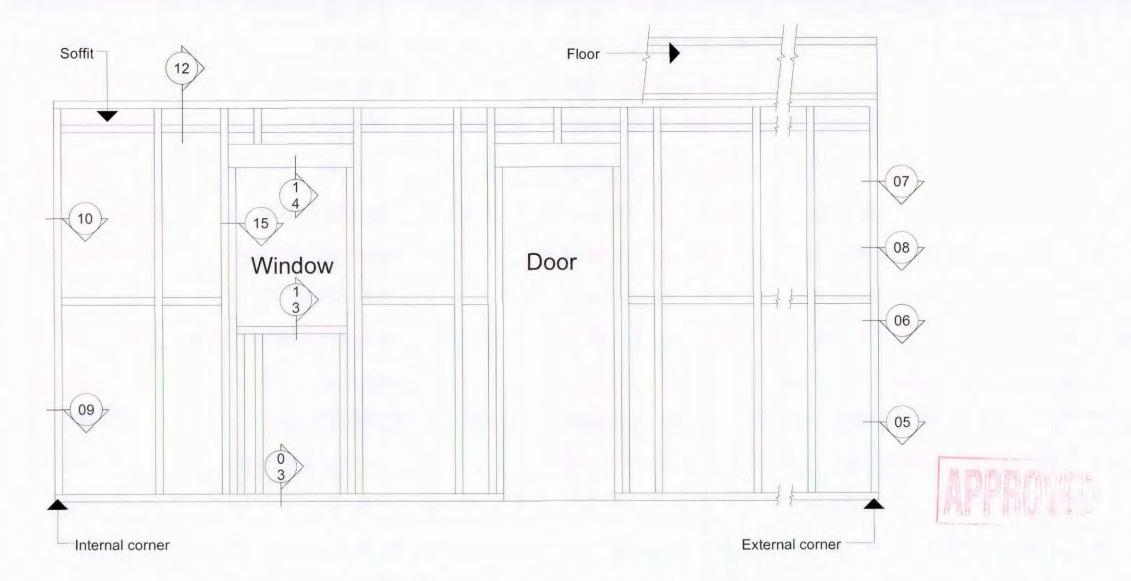

Wall Elevation

Note!

DIRECT FIX FRAMING SETOUT

Section notations refer to dwg numbers.

Scale 1:25

BC090487 Revised 090811

Job Title:

Patterson & Sakamoto

Drawing Title:

Site Address:

475 Manawapou Road Hawea

Job	
Drawn	Warren Clarke
Checked	
Scale	
Date	21 June 2009
Page	A15
Sheet Rev No.	

These drawings have been prepared on the understanding that the Building Contractor has a sound knowledge of the NZ Building Code and NZS 3604 1999. The main Contractor, Sub Contractor or Authorised Agent of the owner or Builder shall ensure that all works comply with these Codes in addition to any requirements of the Territorial Authority. Any work undertaken outside these requirements without the prior written approval of the Designer, Engineer and/or the Territorial Authority hereby indemnifies the Designer or his Agent against any claim, or claims, in respect of the said work.

Notes:

All Works to Comply with NZS3604-1999 and the NZ Building Code and Best Trade Practices.
 B. All Drawings to be Read Inconjunction with

Engineers Drawings/Reports
c. The Contractor shall Supply and Fix all


Necessary Flashing and Sealands to Provide a Completely Weather Tight Building.
d. Refer to All Written Notifications - Do Not


Scale off Drawings
e. Check All Diam. and Verify All Levels on Site

e. Check All Diam. and Verify All Levels on S Prior Proceeding with Works or Ordering of Materials and Commencing Construction. f. IF IN DOUBT - ASK

Signature Homes New Plymouth Ltd 201 Devon St East New Plymouth Ph: 06 769 9026 Fax: 06 769 9026 Copyright to these plans are entirely or partly owned by Signature Homes Ltd.



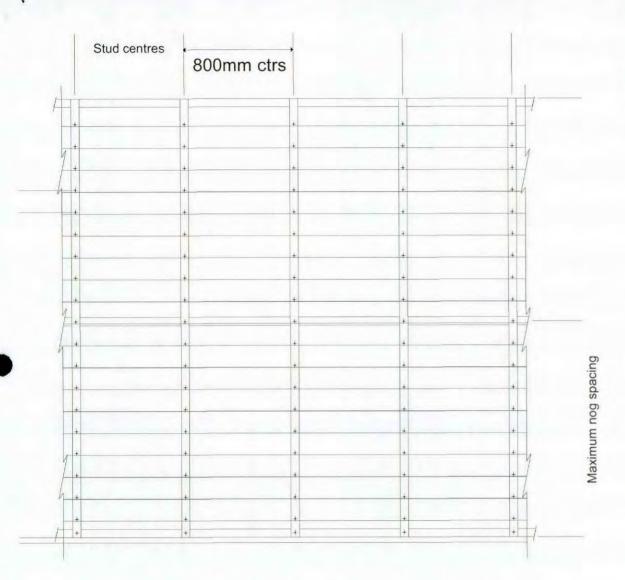

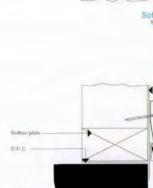


DIRECT FIX CONCRETE SLAB AND SOFFIT

Typical stud LineaTM Weatherboard 100 mm 30mm lap Building Mab


Tongue & groove join in weatherboard to be 100mm minimum from side of stud.

BC090487 Revised 090811

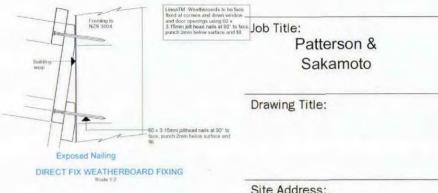

Site Address:

475 Manawapou Road Hawea

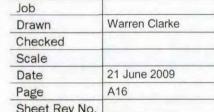

Sheet Rev No. These drawings have been prepared on the understanding that the Building Contractor has a sound knowledge of the NZ Building Code and NZS 3604 -1999. The main Contractor, Sub Contractor or Authorised Agent of the owner or Builder shall ensure

that all works comply with these Codes in addition to any requirements of the Territorial Authority. Any work undertaken outside these requirements without the prior written approval of the Designer, Engineer and/or the Territorial Authority hereby indemnifies the Designer or his Agent against any claim, or claims, in respect of the said work.



DIRECT FIX WEATHERBOARD FIXING

Tongue & Groove Joint

a. All Works to Comply with NZS3604-1999 and the NZ Building Code and Best Trade Practices. b. All Drawings to be Read Inconjunction with Engineers Drawings/Reports

c. The Contractor shall Supply and Fix all Necessary Flashing and Sealands to Provide a Completely Weather Tight Building.

d. Refer to All Written Notifications - Do Not Scale off Drawings


e. Check All Diam. and Verify All Levels on Site Prior Proceeding with Works or Ordering of Materials and Commencing Construction.

f. IF IN DOUBT - ASK Signature Homes New Plymouth Ltd 201 Devon St East New Plymouth Ph: 06 769 9026

Fax: 06 769 9026 Copyright to these plans are entirely or partly owned by Signature Homes Ltd.

These plans are copyright of Signature Homes

DIRECT FIX SHEET FIXING SETOUT

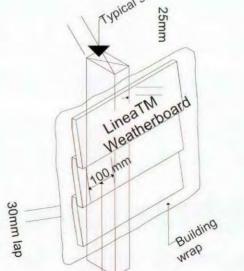


Joints must be staggered by 600mm min.

Jointing Off Stud

Scale 1:10



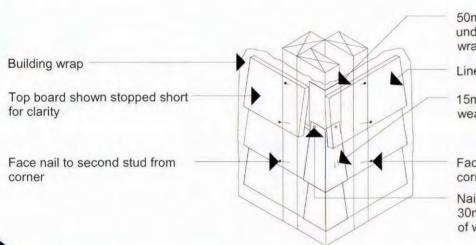


50mm x 50mm uPVC corner underflashing over building wrap

LineaTM Weatherboard

15mm splay cut to end of weatherboard

Face nail to second stud from

Nail soaker into position with 2 -30mm nails before fixing ends of weatherboards

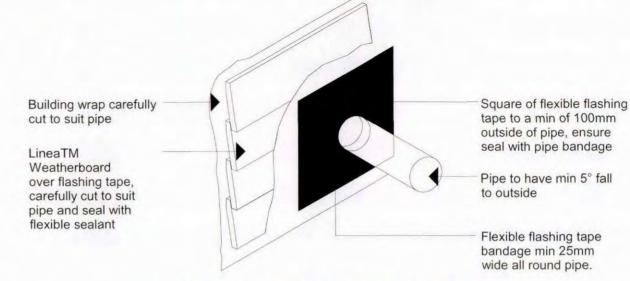

DIRECT FIX PIPE PENETRATION

Scale 1:10

BC090487 Revised 090811

Job Title:

Patterson & Sakamoto

Drawing Title:

Site Address:

475 Manawapou Road Hawea

Job	
Drawn	Warren Clarke
Checked	
Scale	
Date	21 June 2009
Page	A17
Sheet Rev No.	

These drawings have been prepared on the understanding that the Building Contractor has a sound knowledge of the NZ Building Code and NZS 3604 -1999. The main Contractor, Sub Contractor or Authorised Agent of the owner or Builder shall ensure that all works comply with these Codes in addition to any requirements of the Territorial Authority. Any work undertaken outside these requirements without the prior written approval of the Designer, Engineer and/or the Territorial Authority hereby indemnifies the Designer or his Agent against any claim, or claims, in respect of the said work.

Notes:

 a. All Works to Comply with NZS3604-1999 and the NZ Building Code and Best Trade Practices.
 b. All Drawings to be Read Inconjunction with Engineers Drawings/Reports

c. The Contractor shall Supply and Fix all Necessary Flashing and Sealands to Provide a Completely Weather Tight Building. d. Refer to All Written Notifications - Do Not

Scale off Drawings
e. Check All Diam. and Verify All Levels on Site
Prior Proceeding with Works or Ordering of
Materials and Commencing Construction.

f. IF IN DOUBT - ASK
Signature Homes New Plymouth Ltd

201 Devon St East New Plymouth Ph: 06 769 9026 Fax: 06 769 9026 Copyright to these plans are entirely or partly owned by Signature Homes Ltd.


These plans are copyright of Signature Homes

Soaker material Copper Copper or phosphor bronze Aluminium Hot dip galvanised Stainless steel Stainless steel


DIRECT FIX CORNER SOAKER

Scale 1:10


DIRECT FIX EXTERNAL CNR DETAIL

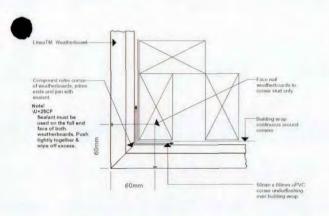

DIRECT FIX MITRE CORNER
Scale 1.2

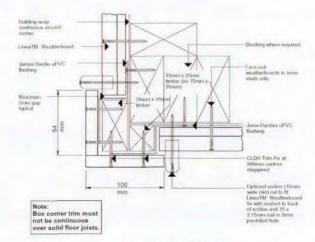


DIRECT FIX BOXED CORNERS
Scale 1:2

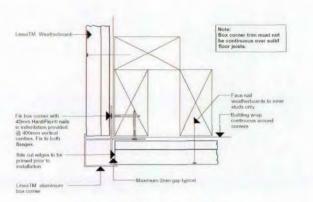


DIRECT FIX ALUMINIUM BOX CORNER
Scale 12




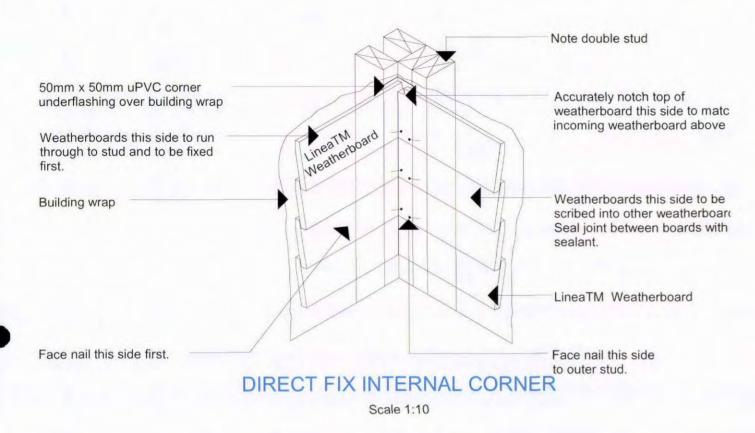

DIRECT FIX INTERNAL CNR DETAIL

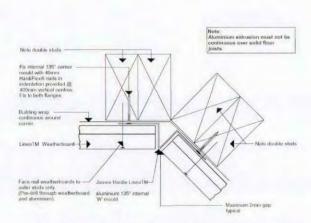


DIRECT FIX INTERNAL 135° ALUMINIUM W MOULD CORNER

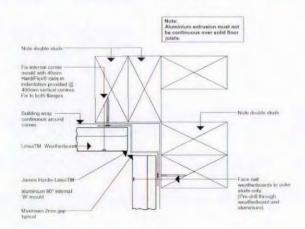

DIRECT FIX INTERNAL 90° ALUMINIUM W MOULD CORNER

DIRECT FIX APRON FLASHING DETAIL

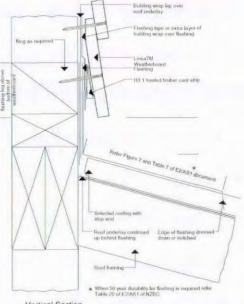

Vertical Section

DIRECT FIX ONE PIECE APRON FLASHING JOINT



BC090487 Revised 090811

Job Title:

Patterson & Sakamoto

Drawing Title:

Site Address:

475 Manawapou Road Hawea

Job	
Drawn	Warren Clarke
Checked	
Scale	
Date	21 June 2009
Page	A18
Sheet Rev No.	

These drawings have been prepared on the understanding that the Building Contractor has a sound knowledge of the NZ Building Code and NZS 3604 -1999. The main Contractor, Sub Contractor or Authorised Agent of the owner or Builder shall ensure that all works comply with these Codes in addition to any requirements of the Territorial Authority. Any work undertaken outside these requirements without the prior written approval of the Designer, Engineer and/or the Territorial Authority hereby indemnifies the Designer or his Agent against any claim, or claims, in respect of the said work.

Notes:

 a. All Works to Comply with NZS3604-1999 and the NZ Building Code and Best Trade Practices. b. All Drawings to be Read Inconjunction with Engineers Drawings/Reports

c. The Contractor shall Supply and Fix all Necessary Flashing and Sealands to Provide a Completely Weather Tight Building.

d. Refer to All Written Notifications - Do Not Scale off Drawings


e. Check All Diam. and Verify All Levels on Site Prior Proceeding with Works or Ordering of Materials and Commencing Construction. f. IF IN DOUBT - ASK

Signature Homes New Plymouth Ltd 201 Devon St East New Plymouth Ph: 06 769 9026 Fax: 06 769 9026 Copyright to these plans are entirely or partly

owned by Signature Homes Ltd.

These plans are copyright of Signature Homes




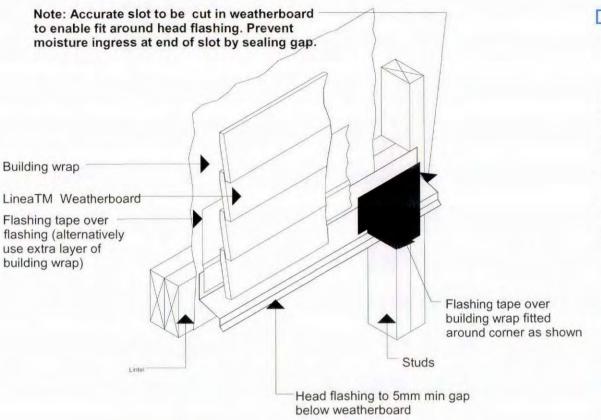

DIRECT FIX HEAD FLASHING TERMINATION


Scale 1:10

DIRECT FIX WINDOW DETAIL (Without Facings)

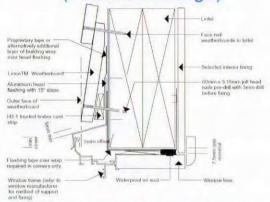


DIRECT FIX WINDOW HEAD WITHOUT FACINGS

DIRECT FIX WINDOW JAMB WITHOUT FACINGS

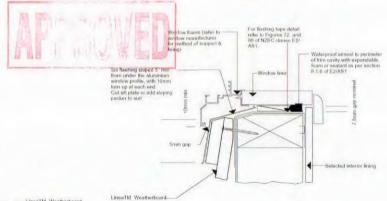


DIRECT FIX WINDOW SILL WITHOUT FACINGS


DIRECT FIX METERBOX DETAIL

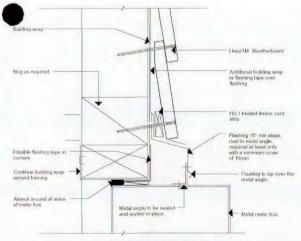

DIRECT FIX METER BOX AT HEAD

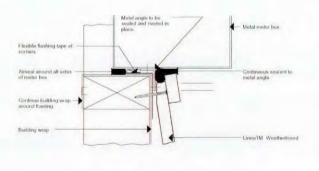

DIRECT FIX METER BOX AT SILL

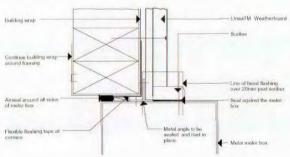

DIRECT FIX METER BOX AT JAMB

YOUR HOME. YOUR WAY.

Job Title: Patterson & Sakamoto

BC090487

Revised 090811

Drawing Title:

Site Address:

475 Manawapou Road Hawea

Job	
Drawn	Warren Clarke
Checked	
Scale	
Date	21 June 2009
Page	A19
Sheet Rev No.	

These drawings have been prepared on the understanding that the Building Contractor has a sound knowledge of the NZ Building Code and NZS 3604 -1999. The main Contractor, Sub Contractor or Authorised Agent of the owner or Builder shall ensure that all works comply with these Codes in addition to any requirements of the Territorial Authority. Any work undertaken outside these requirements without the prior written approval of the Designer, Engineer and/or the Territorial Authority hereby indemnifies the Designer or his Agent against any claim, or claims, in respect of the said work.

Notes:

a. All Works to Comply with NZS3604-1999 and the NZ Building Code and Best Trade Practices.

- b. All Drawings to be Read Inconjunction with Engineers Drawings/Reports
- c. The Contractor shall Supply and Fix all Necessary Flashing and Sealands to Provide a Completely Weather Tight Building.
- d. Refer to All Written Notifications Do Not Scale off Drawings
- e. Check All Diam. and Verify All Levels on Site Prior Proceeding with Works or Ordering of Materials and Commencing Construction.

Signature Homes New Plymouth Ltd 201 Devon St East


New Plymouth Ph: 06 769 9026 Fax: 06 769 9026

f. IF IN DOUBT - ASK


Copyright to these plans are entirely or partly owned by Signature Homes Ltd.

Standard brick veneer

Cavity width 40 - 75mm recommend 70mm

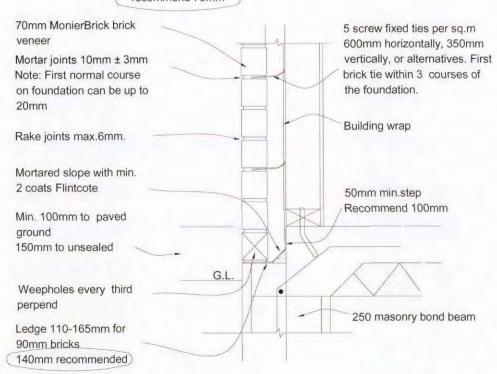

Scale 1:10

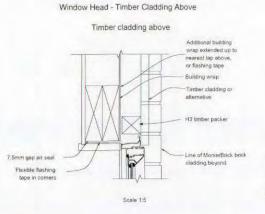


Important:

a. All lintel bars must be propped until mortar is set (7 days).

b. It is important to allow the first 3 courses of the brickwork over an opening to set before laying any more bricks above.

c. Provide brick tes within the bottom two courses.


Window Head - Aluminium

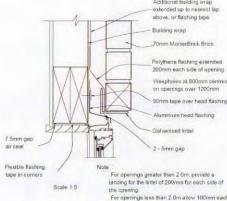


important:
a. All lintel bars must be propped until mortar is set (7 days).
b. It is important to allow the first 3 courses of the brickwork over an opening to set before


laying any more bricks above.
c. Provide brick ties within the bottom two courses.


Meter Box installation Meter Box At Head Meter Box At Sill

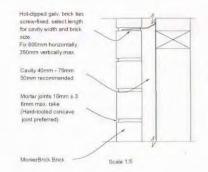


Wall Section - Typical

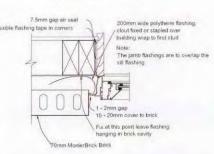

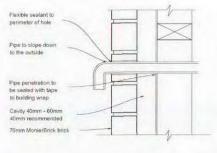

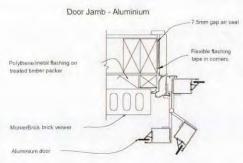

Flat Soffit Detail

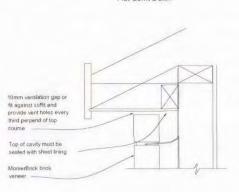



Scale 1:5

- Building wrap

Notes:

a. All Works to Comply with NZS3604-1999 and the NZ Building Code and Best Trade Practices. b. All Drawings to be Read Inconjunction with Engineers Drawings/Reports c. The Contractor shall Supply and Fix all

BC090487 Revised 090811

> Patterson & Sakamoto

475 Manawapou Road

Hawea

Warren Clarke

21 June 2009

A20

These drawings have been prepared on the

understanding that the Building Contractor

has a sound knowledge of the NZ Building Code and NZS 3604 1999. The main

Contractor, Sub Contractor or Authorised

Agent of the owner or Builder shall ensure that all works comply with these Codes in addition to any requirements of the Territorial

Authority. Any work undertaken outside

these requirements without the prior written approval of the Designer, Engineer and/or the Territorial Authority hereby indemnifies

the Designer or his Agent against any claim,

or claims, in respect of the said work.

Job Title:

Drawing Title:

Site Address:

Job

Drawn

Scale

Date

Page

Sheet Rev No.

Checked

Necessary Flashing and Sealands to Provide a Completely Weather Tight Building. d. Refer to All Written Notifications - Do Not


Scale off Drawings e. Check All Diam. and Verify All Levels on Site Prior Proceeding with Works or Ordering of Materials and Commencing Construction.

f. IF IN DOUBT - ASK Signature Homes New Plymouth Ltd 201 Devon St East New Plymouth Ph: 06 769 9026

Fax: 06 769 9026 Copyright to these plans are entirely or partly owned by Signature Homes Ltd.

These plans are copyright of Signature Homes

Stack Bond with Eagle Snake Wire

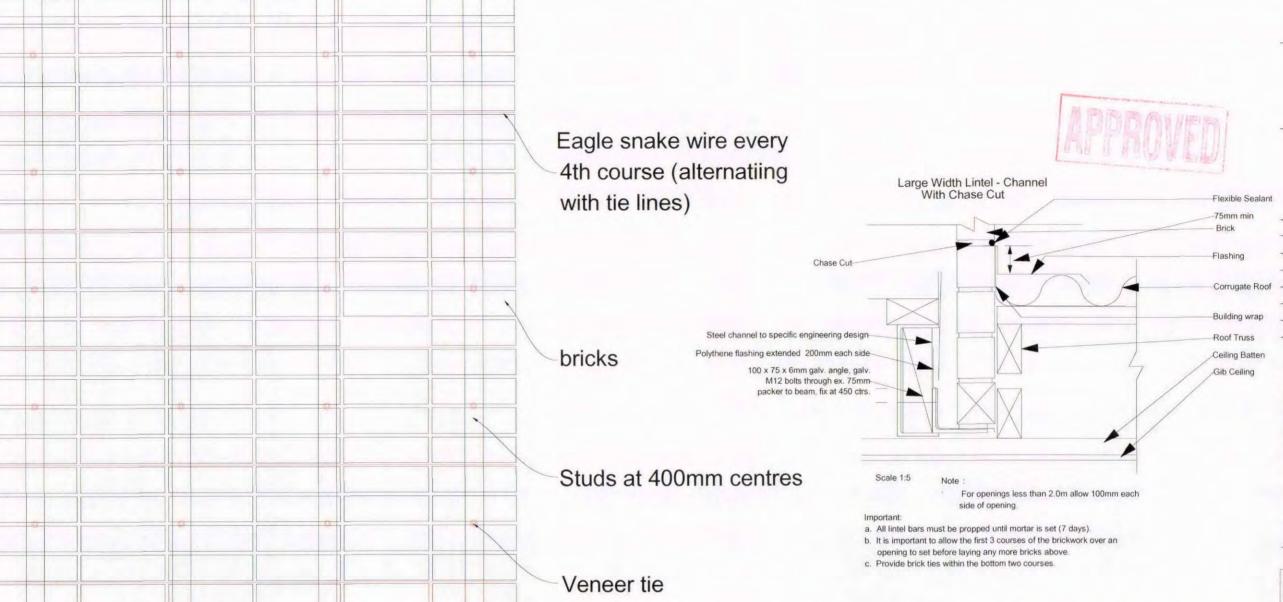

Please refer to Design Note B5 for full details

Engineer to Confirm Stud Centres, Snake Wire Course Numbers and Veneer Tie Numbers

Scale 1:20



BC090487 Revised 090811

Job Title:

Patterson & Sakamoto

Drawing Title:

Site Address:

475 Manawapou Road Hawea

Job	
Drawn	Warren Clarke
Checked	
Scale	L
Date	21 June 2009
Page	
Sheet Rev No.	

These drawings have been prepared on the understanding that the Building Contractor has a sound knowledge of the NZ Building Code and NZS 3604 -1999. The main Contractor, Sub Contractor or Authorised Agent of the owner or Builder shall ensure that all works comply with these Codes in addition to any requirements of the Territorial Authority. Any work undertaken outside these requirements without the prior written approval of the Designer, Engineer and/or the Territorial Authority hereby indemnifies the Designer or his Agent against any claim, or claims, in respect of the said work.

Note

 a. All Works to Comply with NZS3604-1999 and the NZ Building Code and Best Trade Practices.
 b. All Drawings to be Read Inconjunction with Engineers Drawings/Reports

c. The Contractor shall Supply and Fix all Necessary Flashing and Sealands to Provide a Completely Weather Tight Building.

d. Refer to All Written Notifications - Do Not Scale off Drawings


e. Check All Diam. and Verify All Levels on Site Prior Proceeding with Works or Ordering of Materials and Commencing Construction.

f. IF IN DOUBT - ASK


Signature Homes New Plymouth Ltd
201 Devon St East
New Plymouth

New Plymouth Ph: 06 769 9026 Fax: 06 769 9026 Copyright to these plans are entirely or partly owned by Signature Homes Ltd.

These plans are copyright of Signature Homes

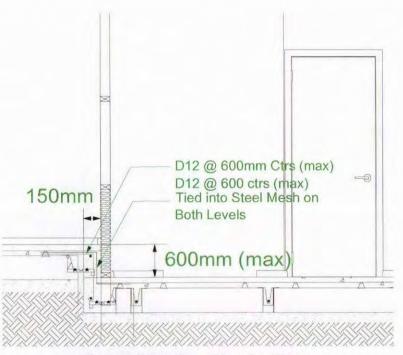


Detail Showing Step in Floor

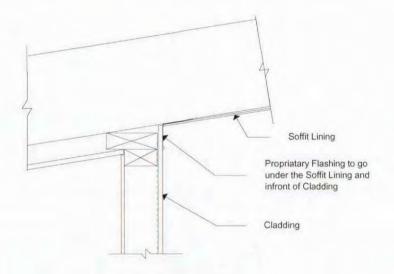


Detail Showing Flashing to Soffit/ Cladding



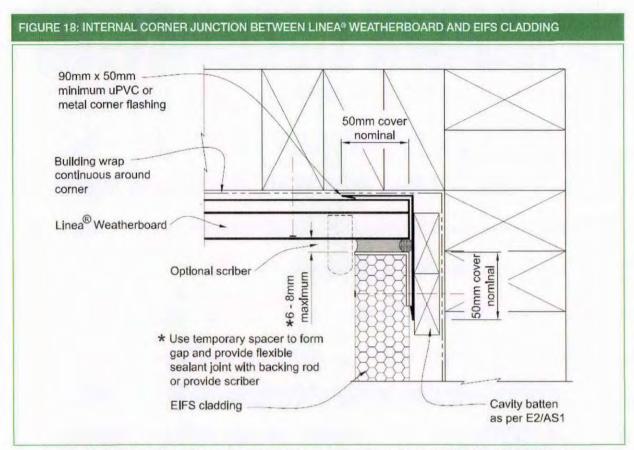

Detail Showing Junction between Weatherboard/EFIS Claddings

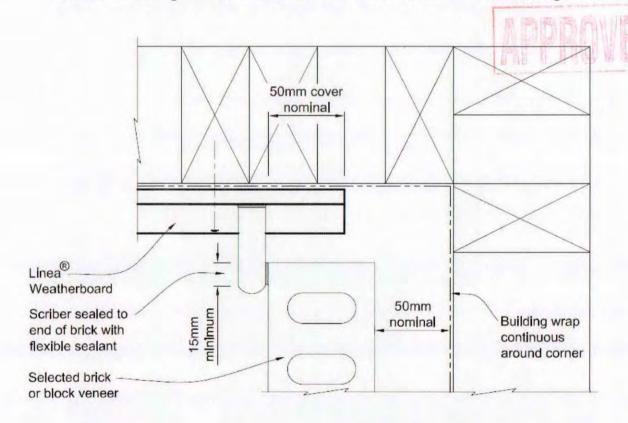

Detail Showing Junction between Weatherboard/Brick Claddings

Job Title:

Patterson & Sakamoto

Drawing Title:

Site Address:

475 Manawapou Road Hawea

Job	
Drawn	Warren Clarke
Checked	
Scale	
Date	21 June 2009
Page	A21
Sheet Rev No.	

These drawings have been prepared on the understanding that the Building Contractor has a sound knowledge of the NZ Building Code and NZS 3604 1999. The main Code and NZS 3604 1999. The main Code and the contractor or Authorised Agent of the owner or Builder shall ensure that all works comply with these Codes in addition to any requirements of the Territorial Authority. Any work undertaken outside these requirements without the prior written approval of the Designer, Engineer and/or the Territorial Authority hereby indemnifies the Designer or his Agent against any claim, or claims, in respect of the said work.

Votes:

a. All Works to Comply with NZS3604-1999 and the NZ Building Code and Best Trade Practices. b. All Drawings to be Read Inconjunction with Engineers Drawings/Reports c. The Contractor shall Supply and Fix all Necessary Flashing and Sealands to Provide a

Completely Weather Tight Building.
d. Refer to All Written Notifications - Do Not Scale off Drawings

e. Check All Diam. and Verify All Levels on Site Prior Proceeding with Works or Ordering of Materials and Commencing Construction.

f. IF IN DOUBT - ASK
Signature Homes New Plymouth Ltd


Signature Homes New Plymouth 201 Devon St East New Plymouth Ph: 06 769 9026 Fax: 06 769 9026

Copyright to these plans are entirely or partly owned by Signature Homes Ltd.

These plans are copyright of Signature Homes

BALCONY 980 x 5 690 MASTER BDRM

Raking ceiling to Master plus Nook

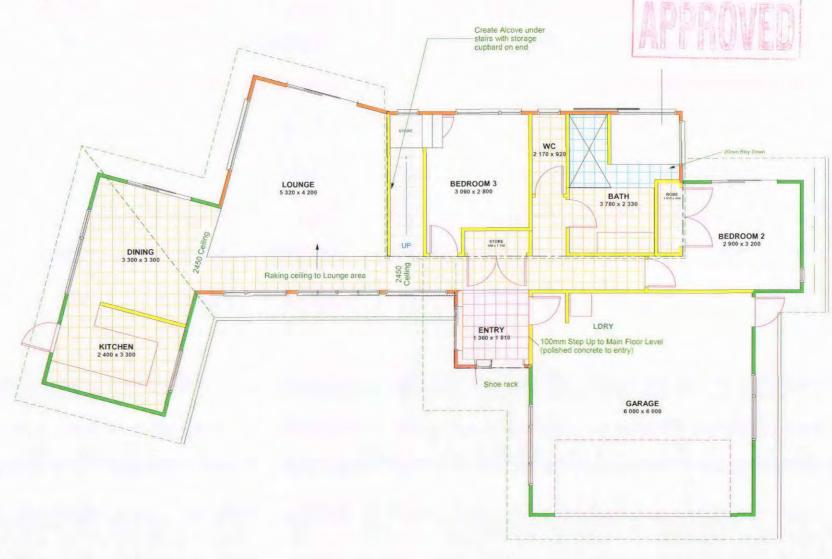

BC090487 Revised 090811

Job Title:

Patterson & Sakamoto

Drawing Title:

Floor Covering Layout

Site Address:

475 Manawapou Road Hawea

Job	
Drawn	Warren Clarke
Checked	
Scale	
Date	21 June 2009
Page	A22
Sheet Rev No.	

These drawings have been prepared on the understanding that the Building Contractor has a sound knowledge of the NZ Building Code and NZS 3604 -1999. The main Contractor, Sub Contractor or Authorised Agent of the owner or Builder shall ensure that all works comply with these Codes in addition to any requirements of the Territorial Authority. Any work undertaken outside these requirements without the prior written approval of the Designer, Engineer and/or the Territorial Authority hereby indemnifies the Designer or his Agent against any claim, or claims, in respect of the said work.

Notes:

a. All Works to Comply with NZS3604-1999 and the NZ Building Code and Best Trade Practices.

- b. All Drawings to be Read Inconjunction with Engineers Drawings/Reports
- c. The Contractor shall Supply and Fix all Necessary Flashing and Sealands to Provide a Completely Weather Tight Building.
- d. Refer to All Written Notifications Do Not Scale off Drawings e. Check All Diam. and Verify All Levels on Site
- Prior Proceeding with Works or Ordering of Materials and Commencing Construction. f. IF IN DOUBT - ASK

Signature Homes New Plymouth Ltd 201 Devon St East

New Plymouth Ph: 06 769 9026

Fax: 06 769 9026

Copyright to these plans are entirely or partly owned by Signature Homes Ltd.

These plans are copyright of Signature Homes



Polished Concrete

Carpet All other Areas

Vinyl Flooring

Tile Flooring



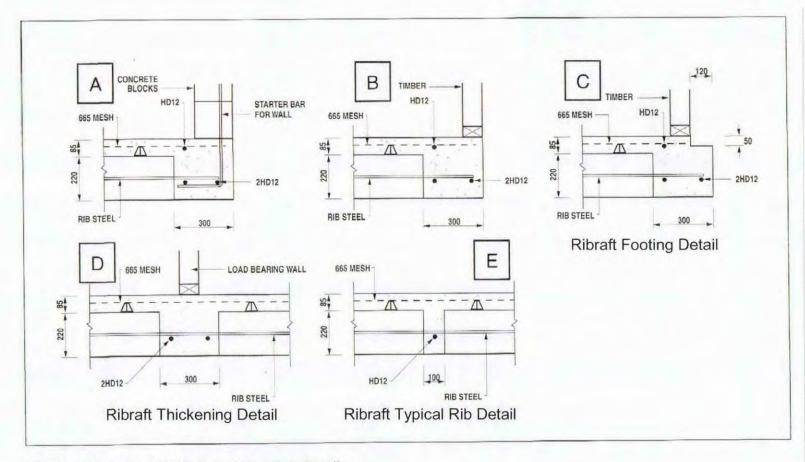


Figure 4 Standard RibRaft Construction Details

Refer to Firth RibRaft Floor Systems
Technical Solutions Booklet for Clarification

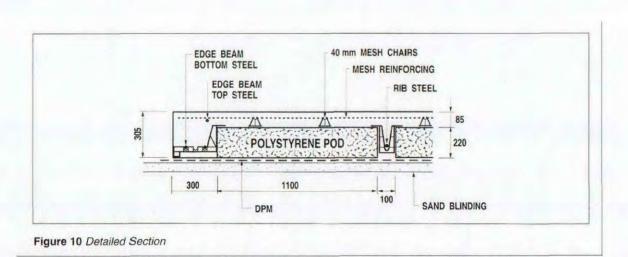

Ribraft Detailed Section

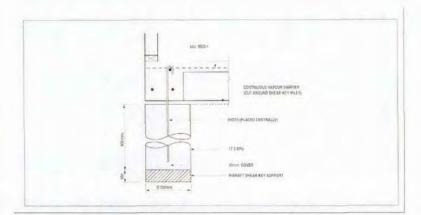

Shear Key Pile Construction Detail



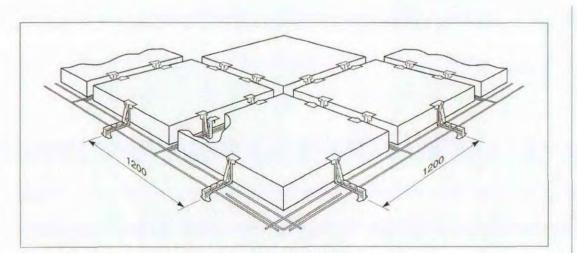


Figure 6 Detailed Layout of Pods and Spacers (mesh and top steel omitted for clarity)

Detail Layout of Pods & Spacers

BC090487 Revised 090811

Job Title:

Patterson & Sakamoto

Drawing Title:
RibRaft
Foundation
Detail

Site Address:

475 Manawapou Road Hawea

Job	
Drawn	Warren Clarke
Checked	
Scale	Not to Scale
Date	21 June 2009
Page	Detail Sheet #1
Sheet Rev No.	

These drawings have been prepared on the understanding that the Building Contractor has a sound knowledge of the NZ Building Code and NZS 3604 -1999. The main Contractor, Sub Contractor or Authorised Agent of the owner or Builder shall ensure that all works comply with these Codes in addition to any requirements of the Territorial Authority. Any work undertaken outside these requirements without the prior written approval of the Designer, Engineer and/or the Territorial Authority hereby indemnifies the Designer or his Agent against any claim, or claims, in respect of the said work.

Notes:

a. All Works to Comply with NZS3604-1999 and the NZ Building Code and Best Trade Practices.

b. All Drawings to be Read Inconjunction with Engineers Drawings/Reports

c. The Contractor shall Supply and Fix all Necessary Flashing and Sealands to Provide a Completely Weather Tight Building.

d. Refer to All Written Notifications - Do Not Scale off Drawings

e. Check All Diam. and Verify All Levels on Site Prior Proceeding with Works or Ordering of Materials and Commencing Construction.

Signature Homes New Plymouth Ltd 201 Devon St East


New Plymouth Ph: 06 769 9026


f. IF IN DOUBT - ASK


Ph: 06 769 9026 Fax: 06 769 9026

Copyright to these plans are entirely or partly owned by Signature Homes Ltd.




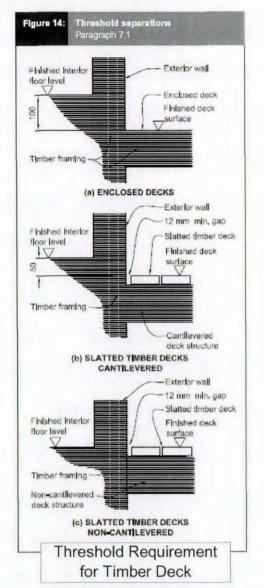


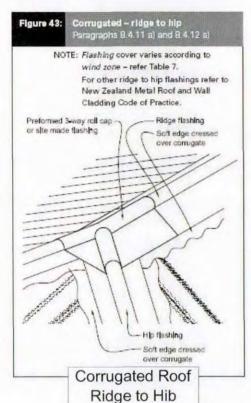

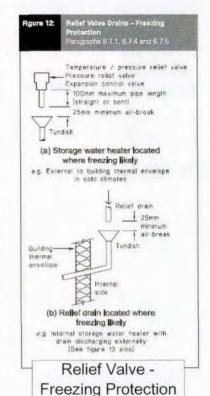


Detail

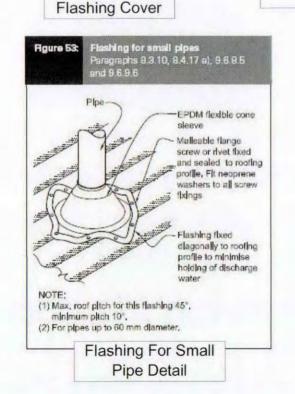

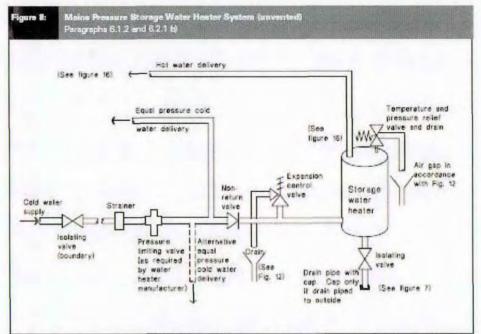

Mains Pressure Detail

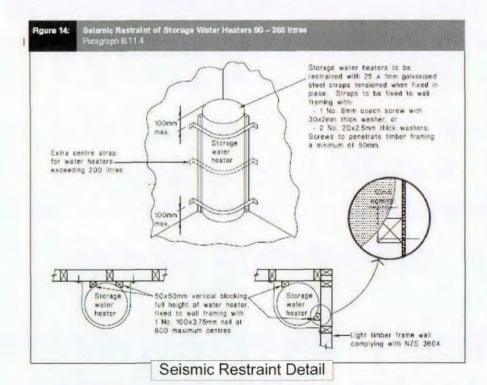



BC090487 Revised 090811

Job Title:

Patterson & Sakamoto

Drawing Title:

Various Details

Site Address:

475 Manawapou Road Hawea

Job	
Drawn	Warren Clarke
Checked	
Scale	Not to Scale
Date	21 June 2009
Page	Detail Sheet #2
Sheet Rev No.	

These drawings have been prepared on the understanding that the Building Contractor has a sound knowledge of the NZ Building Code and NZS 3604 -1999. The main Contractor, Sub Contractor or Authorised Agent of the owner or Builder shall ensure that all works comply with these Codes in addition to any requirements of the Territorial Authority. Any work undertaken outside these requirements without the prior written approval of the Designer, Engineer and/or the Territorial Authority hereby indemnifies the Designer or his Agent against any claim, or claims, in respect of the said work.

Notes:

 a. All Works to Comply with NZS3604-1999 and the NZ Building Code and Best Trade Practices.
 b. All Drawings to be Read Inconjunction with

Engineers Drawings/Reports

c. The Contractor shall Supply and Fix all Necessary Flashing and Sealands to Provide a Completely Weather Tight Building.


d. Refer to All Written Notifications - Do Not Scale off Drawings


e. Check All Diam. and Verify All Levels on Site Prior Proceeding with Works or Ordering of Materials and Commencing Construction. f. IF IN DOUBT - ASK

Signature Homes New Plymouth Ltd 201 Devon St East New Plymouth Ph: 06 769 9026 Fax: 06 769 9026 Copyright to these plans are entirely or partly owned by Signature Homes Ltd.

These plans are copyright of Signature Homes



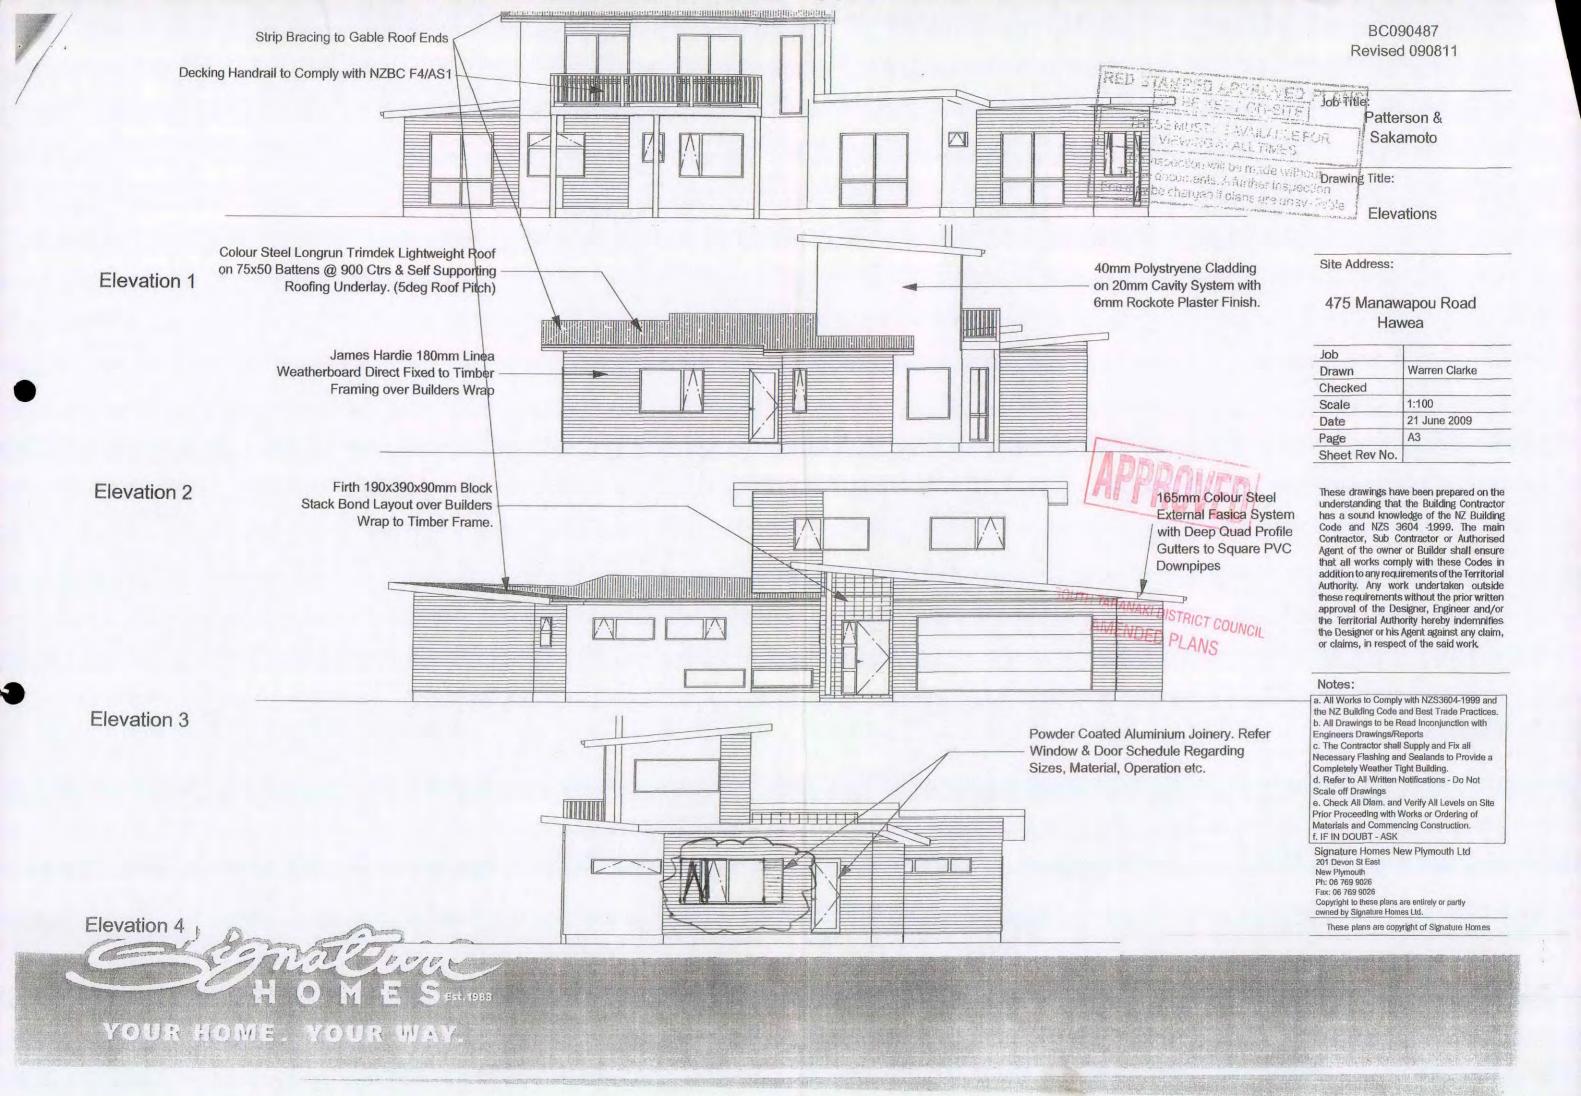

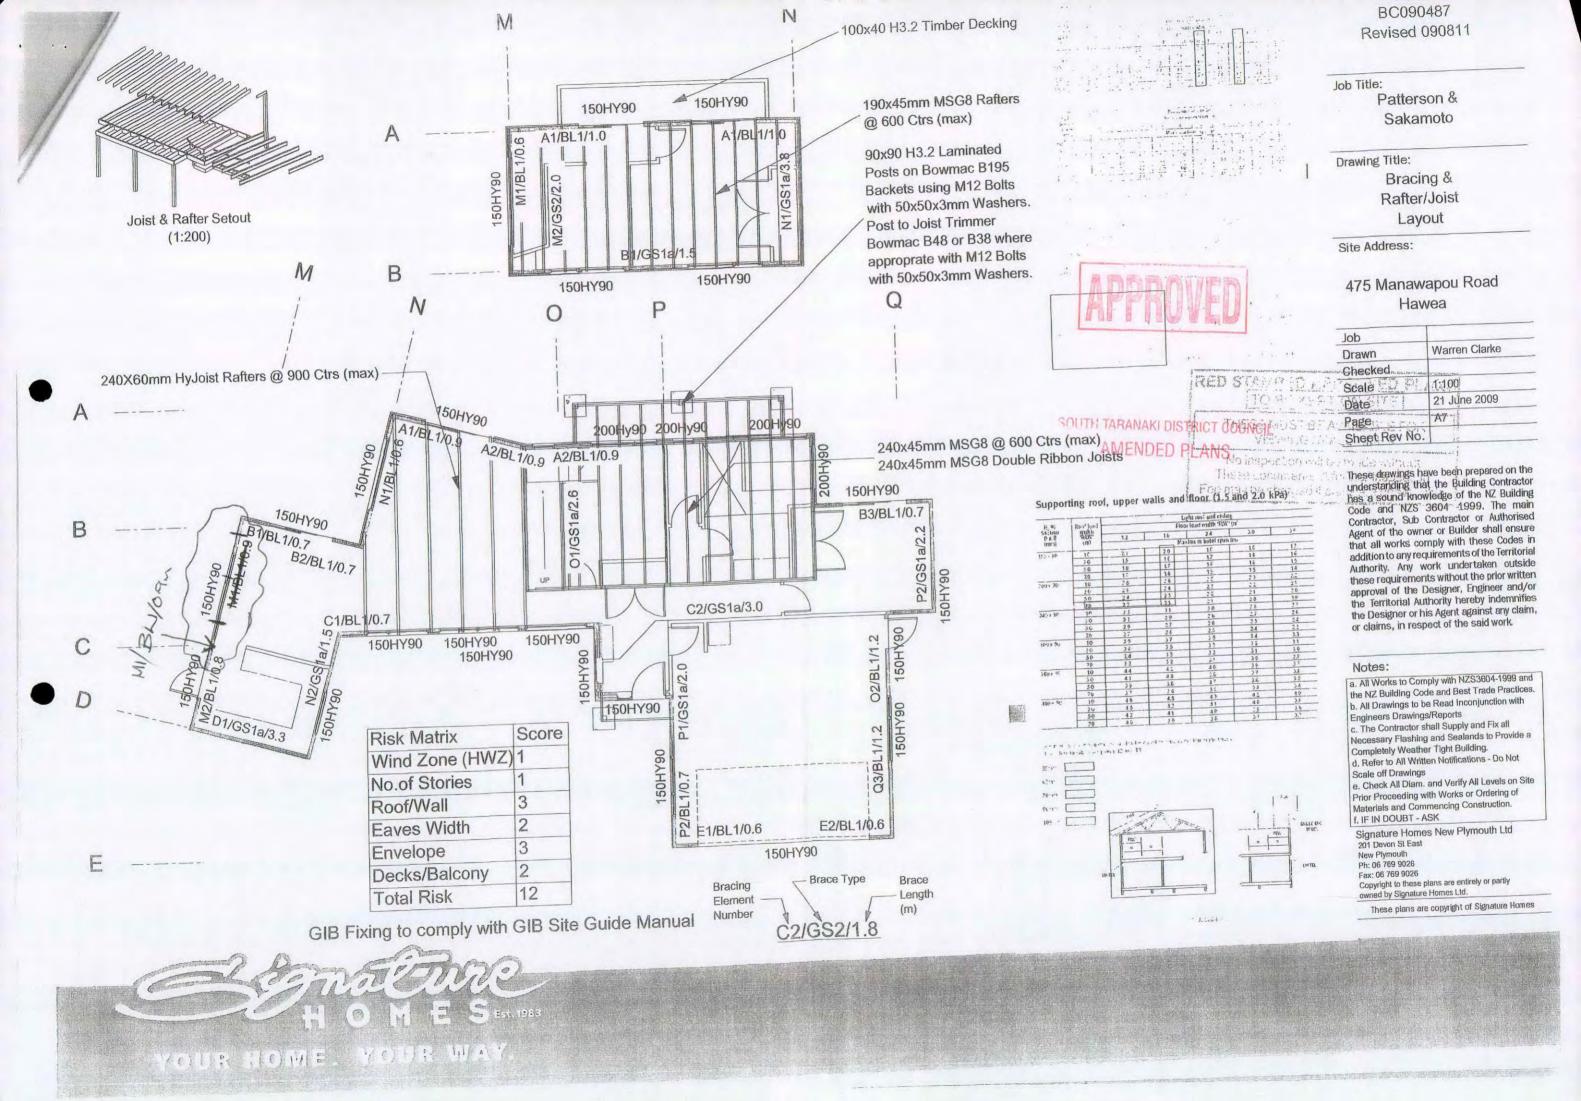

BUILDING CONSENT PROCESSING SHEET

							APPLICATI					.
SITE A	DDRESS: Lot	-1-0	475	Man	nawa	pou	PROPERTY NO	10	02	045	5	T I
BUILDI	R: Signar	here	Ho	nes	REG #	t;	VALUATION NO	123	100	1/13	0/00	
PLUME			11		REG #	± :	VALUE OF WOR	RK \$ 210	0,0	00		
DESCF	RIPTION OF PRO	DPOSED	WORK:				RAPID NO:					
		/	Vec	N	Du	vell	ling			1 1,ve		
DATE	ACTIVITY	OFF	HRS	AMT	DATE			INSP REQ	INSP COM	HRS	AMT	
20/2	Admin	1		tan.		SITE						

29/7	Complete.	M		100-		SITE	9		
29/7	CA	QH	KM	17.50		FOOTING	1/		
5/8	Letter	HP.	.5.	55.00		FLASHINGS PROPRIETARY FLASHINGS			
7/8	atte	AP.	26	120.0		FOUNDATION WALLS CAVITY SYSTEM	/		
13/8	possel	MP.	1.5	165.00	-	CONCRETE FLOOR SLAB SUB SLAB WASTES			
2/10		AP.	.5	55.00	1	CONCRETE BRICKWORK BLOCKWORK			
11	amerdin A	A.P.	.5	55.50	V	PRELINE - INSULATION/ MOISTURE/STRUCTURE	1		
						TIMBER SUBFLOOR	1		
						PRELINE BRACING			
						BRACING PANEL CHECK PRIOR TO DECORATING	1//		
						PRELINE - PLUMBING PIPEWORK	V		
						DRAINAGE	/		
					Lauras	DISABLED FACILITIES			
						FIRES FREESTANDING/ INBUILT	1		
						FIRE CODES	R		
						EXTERIOR COATINGS		PROC	
						COMPLETION BUILDING/ PLUMBING	7		
						AMOUNT PAID	990.00		
						REFUND/PAY			
FEES	(INCLUSIVE C	OF G.S.	T.)		10.0			INVOICE	X
	NISTRATION CO		(100)	\$	100-0		200204		
PIM FEE \$ 27.50 RECEIPT I							297335	LETTER	4
CODE COMPLIANCE CERTIFICATE \$ 100 -				790-	DATE	1918/09	PIM		
\$50000 OFFICE CO.	ESSING COSTS			\$.	467.50	*	>2308-71	3	
	Y CHECK			\$		RECEIPT NO: R		CONSENT	UX.
	CTURAL CHECK OCOPYING			\$		DATE		ccc	
WATE	R CONNECTION			\$		rama.			
SEWE	R CONNECTION	1		\$			ALC: Was	NTF	

QUALITY CONTROL COMPLETED

CONSENTS OFFICER

NOT APPROVED APPROVED

ANDRE OFFICER'S NAME.

(BLG)

(PLNG)

BC 090487 File Contents

Description	Required (Y / N)	Date added	Name
Application Form	Y	29/7	000
Plans and Specifications	Y	29/7	NO
Categorisation and Allocation Form	Υ	29/7	20
Processing Checklist	Y	29/7	CG
File Contents Form (This Form)	Y	29/2	CU
Producer Statements and	n =1	10	
Supporting documentation			
Peer Reviews			
Fire Design documents			
Requests for Further Information	4	5/8	all
Requested Information Received		90	CVV,
Signed Building Consent and		1.7	n
Attachments	Υ	19/9/00	Was .
Amendments	V	2/10/09	Nº -
Inspection Chits (list as appropriate)	,	7,701	
Drawsage	1	Inla	At .
oundation President Stab President	7	logoi	
		11/0	94/
P. Warbus	7	11/-1	de
be was	7	13/10	1
Flumbing Treure	70	9141	XX
Exterior (avity	17	24/11	30
preline -	14	412	- A
Past Sheet Bracing	41	8 2	St.
' Gray	14	28/4	N
Final	4	6/5	A
	-20		
			100
*		1	
		7	
			- 53
Application for CCC	Y	23/4/10	NI.
CCC Checksheet	Y	00 4110	SVI .
	Y	20/10/10	81
Signed CCC	Υ	21116	OVI
Warranties			
Installation certificates			
Energy work certificates			
Notices to fix			
Other (list as appropriate)			

Continue on separate sheet if necessary

NOTES:	
学者 (诗书)	
BUILDING:	
HAZARDOUS SECTION	(Checked against the requirements of Section 31 of the Building Act 1991)
CHECKED AGAINST STD	C REGISTER
CHECKED AGAINST TRO	REGISTER
Compliance schedule	Is compliance schedule required? YES/NO
	If yes application/information to be sent with building consent.

HERITAGE STATUS CHECK



Tax Invoice/Statement: 7768

GST Reg. No: 52-769-477 Invoice Date: 16 October 2009

Signature Homes PO Box 3022 New Plymouth 4341



Address:

Private Bag 902

Hawera

Phone:

06 278 0555

Free Phone: Facsimile:

0800 111 323 06 278 8757

Email:

contact@stdc.govt.nz www.stdc.co.nz

Website:

Application Number:

BC090487

Description:

New Dwelling

Owner:

R L Patterson, T Sakamoto

Location Address:

473B Manawapou Road Hawera 4610

Charge Description	Charge	GST	Amount
Building Consent Processing/Plan Checking	\$48.89	\$6.11	\$55.00
Total	\$48.89	\$6.11	\$55.00

We look forward to receipt of your payment to enable completion of your consent.

Remittance Advice

Please post to:

South Taranaki District Council
Private Bag 902
Hawera 4640
If you wish to pay online details are as follows - 030647-0220100-03
Please quote the Application Number as the reference

Application Number: BC090487 Applicant: Signature Homes

Amount Due: \$55.00

Tax Invoice/Statement: 7731

GST Reg. No: 52-769-477 Invoice Date: 02 October 2009

Signature Homes PO Box 3022 New Plymouth 4341



Address: Private Bag 902 Hawera Phone: 06 278 0555 0800 111 323 Free Phone: 06 278 8757 Facsimile:

contact@stdc.govt.nz Email: Website: www.stdc.co.nz

Application Number:

BC090487 **Description: New Dwelling** Owner:

Location Address:

R L Patterson, T Sakamoto

473B Manawapou Road Hawera 4610

Charge Description	Charge	GST	Amount
Building Consent Processing/Plan Checking	\$48.89	\$6.11	\$55.00
Total	\$48.89	\$6.11	\$55.00

We look forward to receipt of your payment to enable completion of your consent.

Remittance Advice

Please post to: South Taranaki District Council Private Bag 902 Hawera 4640

Application Number: BC090487 Applicant: Signature Homes

Amount Due: \$55.00

Processing Checklist – New Dwelling / Alterations

Page 1 of 8

Applicant Name: R. Patterson	T	salco	noti	BC No: 090487
Site Address: 475 managed	par	id		Date: 4-10-09
				we with the moving of a windows with another Gib type system. This has appose amendment.
Section 112 Alteration to Existence Schedule 1. Exempt Building	Wor	k lans/Spe	ecs	Assessed:
Item to be checked for compliance: with the NZ Building Act 2004, NZBC &	Complies	Checke	d	Details of Processing & Comments: Comments must be made for: 1. Non-complying items 2. Alternative solutions & how compliance with NZBC achieved
Approved Documents Note: N/A = this item is not applicable to this application and has not been assessed	Com	Non -Co	Ž	2. August 2014 and 2011 plante with 14200 acritever
Building consent detail				
Classification of exposure zones determined?		Yes/No		
Site visit conducted?		Yes/No		
s this a sloping site?				
Earth brick/straw bale construction	Yes/No)	
Siting measurements from min. 2				
boundaries shown		Yes/No		
ooundaries shown		Yes/No		
		Yes/No		

(1) Utilise one of the following:

(by 2nd engineer/PS1/2 provided)
Engineer detail correctly shown on plans

Tick (✓) This item complies with the NZ Building Code at the date of processing Cross (*) This item does not comply with the NZ Building Code at the date of processing N/A Means this item is not applicable to this project and has not been assessed.

Compliance: with the NZ Building Act 2004, NZBC & Approved Documents Set (NA) = this item is not papicable to this application and has not been assessed Specified mPa: 2. Alternative solutions & how compliance with NZBO Ribraft floor used Yes/No Specified mPa: Depth: Width: Concrete strength specified Specified mPa: Depth: Width: Footing dimensions Depth: Width: Width: Pad & beam dimensions Details: Depth: Width: Post footings Details: Details: Post footing: size, type, placement on plans Details: Details: Floor heights in relation to finished ground levels Details: Details: Heights & dimensions of foundation walls shown Details: Details: Foundation height in respect of subfloor access, pile heights etc. Details: Details: Reinforcing: size, type, placement on plans Details: Details: Ventilation set out Subfloor access door Trype: Trype: Retaining wall detail (incl. landscape walls) Total plans Trype: Trype: Protection of waterproofing detailed on plans Details: <th colspan="3">Details of Processing & Comments:</th>	Details of Processing & Comments:		
Concrete strength specified Footing dimensions Depth: Width: Details: Post footings Depth: Width: Details: Details: Details: Details: Details: Details: Foundation walls Floor heights in relation to finished ground levels Heights & dimensions of foundation walls shown Foundation height in respect of subfloor access, pile heights etc. Reinforcing: size, type, placement on plans Ventilation set out Subfloor access door Retaining wall detail (incl. landscape walls) Waterproofing of retaining walls on plans Protection of waterproofing detailed on plans Drainage of retaining walls detailed on plans Drainage of retaining walls detailed on plans Pile dimensions shown on plans Set out, spacing & treatment Ordinary piles Size, set out, spacing & treatment Treatment: Treatment:			
Footing dimensions Pad & beam dimensions Post footings Reinforcing: size, type, placement on plans Concrete block foundation detail Foundation walls Floor heights in relation to finished ground levels Heights & dimensions of foundation walls shown Foundation height in respect of subfloor access, pile heights etc. Reinforcing: size, type, placement on plans Ventilation set out Subfloor access door Retaining wall detail (incl. landscape walls) Waterproofing of retaining walls on plans Protection of waterproofing detailed on plans Drainage of retaining walls detailed on plans Ordinary piles: Footing dimensions Pile dimensions shown on plans Size, set out, spacing & treatment Ordinary piles Size, set out, spacing & treatment Treatment: Treatment: Vidith: Width: Vetails: Vetails: Set out, spacing & treatment Treatment: Treatment:			
Footing dimensions Pad & beam dimensions Post footings Post footing walls Post footing walls Post footing walls Post footing			
Pad & beam dimensions Post footings Popth: Width: W			
Post footings Reinforcing: size, type, placement on plans Poundation walls Floor heights in relation to finished ground levels Heights & dimensions of foundation walls shown Foundation height in respect of subfloor access, pile heights etc. Reinforcing: size, type, placement on plans Ventilation set out Subfloor access door Retaining wall detail (incl. landscape walls) Waterproofing of retaining walls on plans Protection of waterproofing detailed on plans Drainage of retaining walls detailed on plans Pile dimensions Pile dimensions shown on plans Size, set out, spacing & treatment Ordinary piles Size, set out, spacing & treatment Treatment: Treatment: Treatment: Treatment: Treatment:			
Reinforcing: size, type, placement on plans Concrete block foundation detail Foundation walls Floor heights in relation to finished ground levels Heights & dimensions of foundation walls shown Foundation height in respect of subfloor access, pile heights etc. Reinforcing: size, type, placement on plans Ventilation set out Subfloor access door Retaining wall detail (incl. landscape walls) Waterproofing of retaining walls on plans Protection of waterproofing detailed on plans Ordinary piles: Footing dimensions Pile dimensions shown on plans Set out, spacing & treatment Ordinary pile connections shown Driven piles Size, set out, spacing & treatment Treatment: Treatment: Treatment: Treatment:			
Foundation walls Floor heights in relation to finished ground levels Heights & dimensions of foundation walls shown Foundation height in respect of subfloor access, pile heights etc. Reinforcing: size, type, placement on plans Ventilation set out Subfloor access door Retaining wall detail (incl. landscape walls) Waterproofing of retaining walls on plans Protection of waterproofing detailed on plans Drainage of retaining walls detailed on plans Ordinary piles: Footing dimensions Pile dimensions shown on plans Set out, spacing & treatment Ordinary pile sonnections shown Driven piles Size, set out, spacing & treatment Treatment: Treatment:			
Floor heights in relation to finished ground levels Heights & dimensions of foundation walls shown Foundation height in respect of subfloor access, pile heights etc. Reinforcing: size, type, placement on plans Ventilation set out Subfloor access door Retaining wall detail (incl. landscape walls) Waterproofing of retaining walls on plans Protection of waterproofing detailed on plans Drainage of retaining walls detailed on plans Ordinary piles: Footing dimensions Pile dimensions shown on plans Dretails: Details: Details: Details: Details: Type: Details: Details: Treatment: Treatment: Treatment:			
levels Heights & dimensions of foundation walls shown Foundation height in respect of subfloor access, pile heights etc. Reinforcing: size, type, placement on plans Ventilation set out Subfloor access door Retaining wall detail (incl. landscape walls) Waterproofing of retaining walls on plans Type: Protection of waterproofing detailed on plans Drainage of retaining walls detailed on plans Ordinary piles: Footing dimensions Pile dimensions shown on plans Set out, spacing & treatment Ordinary piles Size, set out, spacing & treatment Driven piles Size, set out, spacing & treatment Treatment: Dreatils: Details: Details: Details: Treatment: Treatment: Treatment:			
Shown Foundation height in respect of subfloor access, pile heights etc. Reinforcing: size, type, placement on plans Ventilation set out Subfloor access door Retaining wall detail (incl. landscape walls) Waterproofing of retaining walls on plans Protection of waterproofing detailed on plans Drainage of retaining walls detailed on plans Ordinary piles: Footing dimensions Pile dimensions shown on plans Set out, spacing & treatment Ordinary pile connections shown Driven piles Size, set out, spacing & treatment Treatment: Treatment: Treatment: Treatment:			
access, pile heights etc. Reinforcing: size, type, placement on plans Ventilation set out Subfloor access door Retaining wall detail (incl. landscape walls) Waterproofing of retaining walls on plans Protection of waterproofing detailed on plans Drainage of retaining walls detailed on plans Ordinary piles: Footing dimensions Pile dimensions shown on plans Details: Set out, spacing & treatment Ordinary piles Size, set out, spacing & treatment Treatment: Treatment: Treatment: Treatment:			
plans Ventilation set out Subfloor access door Retaining wall detail (incl. landscape walls) Waterproofing of retaining walls on plans Protection of waterproofing detailed on plans Drainage of retaining walls detailed on plans Ordinary piles: Footing dimensions Pile dimensions shown on plans Set out, spacing & treatment Ordinary pile connections shown Driven piles Size, set out, spacing & treatment Treatment: Treatment: Treatment:			
Subfloor access door Retaining wall detail (incl. landscape walls) Waterproofing of retaining walls on plans Protection of waterproofing detailed on plans Drainage of retaining walls detailed on plans Ordinary piles: Footing dimensions Pile dimensions shown on plans Set out, spacing & treatment Ordinary pile connections shown Driven piles Size, set out, spacing & treatment Treatment: Treatment: Treatment:			
Retaining wall detail (incl. landscape walls) Waterproofing of retaining walls on plans Protection of waterproofing detailed on plans Drainage of retaining walls detailed on plans Ordinary piles: Footing dimensions Pile dimensions shown on plans Set out, spacing & treatment Ordinary pile connections shown Driven piles Size, set out, spacing & treatment Treatment: Treatment: Treatment:			
walls) Waterproofing of retaining walls on plans Protection of waterproofing detailed on plans Drainage of retaining walls detailed on plans Ordinary piles: Footing dimensions Pile dimensions shown on plans Set out, spacing & treatment Ordinary pile connections shown Driven piles Size, set out, spacing & treatment Treatment: Treatment: Treatment:			
Protection of waterproofing detailed on plans Drainage of retaining walls detailed on plans Ordinary piles: Footing dimensions Pile dimensions shown on plans Set out, spacing & treatment Ordinary pile connections shown Driven piles Size, set out, spacing & treatment Treatment: Treatment: Treatment:			
plans Drainage of retaining walls detailed on plans Ordinary piles: Footing dimensions Pile dimensions shown on plans Details: Set out, spacing & treatment Ordinary pile connections shown Driven piles Size, set out, spacing & treatment Treatment: Treatment: Treatment:			
plans Ordinary piles: Footing dimensions Pile dimensions shown on plans Set out, spacing & treatment Ordinary pile connections shown Driven piles Size, set out, spacing & treatment Treatment: Treatment: Treatment: Treatment:			
Ordinary piles: Details: Footing dimensions Details: Pile dimensions shown on plans Details: Set out, spacing & treatment Treatment: Ordinary pile connections shown Driven piles Size, set out, spacing & treatment Treatment:			
Footing dimensions Pile dimensions shown on plans Set out, spacing & treatment Ordinary pile connections shown Driven piles Size, set out, spacing & treatment Treatment: Treatment: Treatment:			
Set out, spacing & treatment Ordinary pile connections shown Driven piles Size, set out, spacing & treatment Treatment: Treatment: Treatment:			
Ordinary pile connections shown Driven piles Size, set out, spacing & treatment Treatment:			
Driven piles Size, set out, spacing & treatment Treatment:			
Size, set out, spacing & treatment Treatment:			
Specification for driving of piles Contificate required confirming piles driven			
Certificate required confirming piles driven to approved specification entered on BC conditions?			
Anchor piles:			
Footing dimensions Depth: Width:			
Pile dimensions shown on plans Details:			
Set out, spacing & treatment Treatment:			
Anchor pile connections shown (min. 12Kn)			
Braced piles:			
Footing dimensions Depth: Width:			
Pile dimensions shown on plans Details:			
Set out, spacing & treatment Treatment:			
Braced pile connections shown (min. 12Kn) Column / post footings:			

Item to be checked for	Plans/Specs Checked			Details of Processing & Comments:		
compliance: with the NZ Building Act 2004, NZBC & Approved Documents Note: N/A = this item is not applicable to this application and has not been assessed	Complies	Non -Complying	N/A	Comments must be made for: 1. Non-complying items 2. Alternative solutions & how compliance with NZBC achieved		
Footing dimensions	Manufacture 1			Depth: Width:		
Post dimensions shown on plans				Details:		
Chimney/fireplace foundation detailed on						
plans Slab on Ground						
To the second se						
Concrete strength specified			-	Specified mPa:		
Floor heights shown on plans				Details:		
Design for foundation >600mm Hardfill detail			4	Tune		
Compacted fill		1	+	Type:		
(report required if > 600mm in depth)			1			
Damp proof membrane				Type:		
Slab Thickening				.,,,,,		
Pads						
Reinforcing: size, type, placement on plans				Details:		
Supplementary reinforcing detailed on plans						
Shrinkage control joints detailed on plans						
Free joints (slabs > 24m) detailed on						
plans						
Split floor levels						
Reinforcing: size, type, placement on plans				Details:		
Waterproofing detail (DPM)				Type:		
Masonry foundations & walls						
Concrete strength specified				Specified mPa:		
Masonry detail						
Reinforcing detail				Type & Size		
Engineer detail peer reviewed (by 2 nd engineer/PS1/2 provided)				(Eng. to initial items checked)		
Engineer detail shown on plans						
Timber Treatment						
Timber grade & treatment schedule (for all timber)						
Framing						
Wind zone identified (so fixings can be checked)						
Exposure zones identified (so fixings can be checked)						
Bearer size & spans						
Bearer fixing details to foundation walls shown on plans						
Joist size & spans						
Support of walls parallel to floor joists						
Split floor level framing shown on plans						
Flooring material specified				Type:		
Bottom plate fixing (walls) detailed	-			1,140.		

Item to be checked for	Item to be checked for		ecs ed	Details of Processing & Comments:			
compliance: with the NZ Building Act 2004, NZBC & Approved Documents Note: N/A = this item is not applicable to this application and has not been assessed	Complies	Non -Complying	NIA	Comments must be made for: 1. Non-complying items 2. Alternative solutions & how compliance with NZBC achieved			
Stud height & spacing							
Verandah post, beam & fixing detail shown on plans							
Lintel sizes & specifications shown on							
plans							
Design certificate(s) or calculation table(s) provided							
Cantilever beams, corner window etc.							
Engineer beams & supports peer reviewed (by 2 nd Engr/PS1/2 provided)				(Eng. to initial items checked)			
Engineer details, incl. connections shown on plans							
Ceiling batten size, grade, spacing, span							
Ceiling joists size, spacing, span							
Strongbacks/runners size, spacing, span			-				
		1	-				
Wall & ceiling linings shown on plans							
Framing set out suitable for linings							
Fire rated walls & ceilings shown on plans							
Fire design checked							
Fire wall detail e.g. fixings etc. shown on							
plans	-		-				
Truss manufacturer's design certificate							
Truss manufacturer's set out detail Truss manufacturer's fixing detail			+				
Point loads to lintels identified	-	-	1				
Rafter size, spacing & span		+	-				
Rafter fixing shown on plans			+-				
Underpurlin size shown on plans			1				
Strutting beams size shown on plans							
Struts loading on strutting beam or load bearing walls							
Ridge beam detail and fixings shown on plans							
Purlin/batten size, spacing & span							
Purlin/batten fixing detail specified							
Skillion roof detail			4				
Building paper/wrap specified – walls				Type:			
Building paper/wrap specified – roof				Type:			
Chimney construction detail on plans							
Chimney roof restraint detail							
Roof membrane substrate detail shown on plans							
Roof framing set out suitable for substrate			4				
Roof cladding specified			-	Type:			
Roof cladding suitable for min. roof pitches (length of sheet may effect min. pitch)							
Internal gutter(s) construction detail shown on plans							

Item to be checked for		Plans/Specs Checked		Details of Processing & Comments:
compliance: with the NZ Building Act 2004, NZBC & Approved Documents Note: N/A = this item is not applicable to this application and has not been assessed	Complies	Non -Complying	NIA	Comments must be made for: 1. Non-complying items 2. Alternative solutions & how compliance with NZBC achieved
Internal gutter(s) overflow detail shown on plans				
Balcony drainage & overflow detail shown on plans				
Deck joists size, spacing & span				
Saddle flashings fitted to deck joists Deck stringer spaced off cladding min.				
12mm		-	-	
Fixing of deck barrier detail Pergola/porch framing detail shown on plans				
Pergola/porch fixing detail shown on plans				
Bracing				
Calculations incl. subfloor / lower / upper storeys (circle calculations applicable)				
Fixing details for framing and sheet material provided				
Elements equally distributed throughout building				
Double sided bracing of exterior walls checked				
Interior walls: bracing limitations e.g. bathrooms				
Ceiling diaphragms shown on plans				
Roof bracing shown on plans				
Interior				
Insulation walls, ceiling & subfloor shown on plans				R Rating
Waterproofing detail showers, floors, decks/balconies				
Stair, handrail & barrier details shown on plans				
Stair min. tread max. rise specified				
Fireplace / solid fuel heater shown on plans				
Manufacturers' specifications provided		Yes/N	0	
Flue location shown on elevations				
Smoke alarms specified & shown on plans				
Light & visual awareness (incl. attic windows & skylights) Area of glazing > 30% of wall				
Ventilation (incl. all habitable spaces)				
Safety glazing detail bathrooms, window seats, etc.				
Air noise: design, construction detail shown on plans				
Air noise: producer statement – design received				

Item to be checked for	Plans/Specs Checked			Details of Processing & Comments:	
compliance: with the NZ Building Act 2004, NZBC & Approved Documents Note: N/A = this item is not applicable to this application and has not been assessed	ding Act 2004, NZBC & STORM CONTROL OF THE PROPERTY OF THE PRO	Comments must be made for: 1. Non-complying items 2. Alternative solutions & how compliance with NZBC achieved			
Food preparation & prevention of contamination					
Sink & preparation surfaces					
Food storage					
Wall linings					
Exterior					
E2 risk matrix assessment checked					
Exterior cladding(s) specified					
System specification provided					
Cavity system details (batten size, fixing & treatment)					
Control joints shown on plans (solid plaster)					
Vermin proofing					
Internal & external corner details					
Junction details of dissimilar materials					
Bottom edge clearances to ground levels &/or decks					
Brick veneer cavity, fixing & waterproofing detail					
Double studs or blocking to openings for brick veneer ties					
Brick veneer > 4m high					
Brick veneer lintel bars					
Brick veneer shelf angles					
Brick veneer panel widths					
Plaster supports					
Flashings					
Windows & doors, meter boxes, gas boxes, etc.					
Apron flashing detail		The second			
Chimney & flue flashing detail					
Stop end apron flashing detail					
Sill threshold flashing detail					
Soffitt/wall junction flashing detail					
Penetrations @ fixing points, pergolas, decks					
Penetrations of electrical cables					
Parapets - caps, walls, intersections, etc.					
Intersections, roof walls, dissimilar claddings					
Stairs & Barriers					
Exterior stair construction detail shown on plans					

Item to be checked for		ans/Spe Checker		Details of Processing & Comments:			
compliance: with the NZ Building Act 2004, NZBC & Approved Documents Note: N/A = this item is not applicable to this application and has not been assessed	Complies	Non -Complying	NIA	Comments must be made for: 1. Non-complying items 2. Alternative solutions & how compliance with NZBC achieved			
Exterior balcony, stair & landing barrier detail shown on plans							
Stair min. tread max. rise specified							
Slip resistant surface (main entry decks & stairs)				Туре:			
Plumbing				Plumbing Processing Officer:			
Schematic layout provided – waste/drains		Yes/No					
Discharge length of pipes			1				
Discharge pipes venting							
Soil stack layout provided		Yes/No					
Soil stack layout (incl. relationship to floor joists)		1 33/140					
Soil stack venting							
Water supply							
Type of material				Type:			
Backflow prevention				туре.			
Tempered hot water			-				
Provision of laundering facilities							
Water main pressure for sprinklers			+				
Drainage							
Stormwater layout shown on plans							
Gutter & outfall sizes in relation to roof size							
Site stormwater/surface water collection & disposal detail (Erosion of sloping sites)							
Water tank overflow detail on plans (Erosion of sloping sites)							
Sewer layout Gulley traps/ overflow relief gullies (ORGs)				AS/NZS3500 AS/G13 Other			
Sewer venting							
Effluent disposal							
Septic tank & effluent disposal design				Tank Size:			
Effluent disposal site plan				TYPE: Line Field Other			
Proximity to water course(s) & buildings							
Stormwater cut off drain above effluent bed shown on plans (Sloping sites)							
Site Servicing							
Is site serviced?		Yes/No	_				
Application suspended for further		Suspe	nded	Date: Lifted Date:			
information?	Suspended			Date: Lifted Date:			

South Taranaki District Council Private Bag 902, Hawera Telephone: 06 278 0555 or 0800 111 323 Facsimile: 06 278 8757



and N/A if not

Producer Statement Assessment

Features/Items to be checked		
Register checked	Author qualifications	
If not registered – Application actioned	Insurance type shown	
Original	Insurance cover provided	
Category shown	Any limitations and/or assumptions shown	
Project specific	Statement signed	
Location identified	Other verifications considered are listed	
Owner identified	Does it reference BC documents?	
Building work described	Supporting information provided	
Standards or codes specified	Has a peer review been conducted?	
Basis of issue stated	Should a peer review be undertaken?	
Author name	Any conflict of interest?	
Author address	Any special inspection requirements	
Engineer required on site when the following Checking Officer:		
Signed:		
Date:		

Categorisation of Building Consent Applications and Allocation for Processing Address . โป. 7. นาร์ เทลาลมสุดง รณ์ BC . จิลอนรัก

	CATEGORY			CATEGORY	1	RY			
	1.1			2.1			3.1		
(1.2)				2.2			3.2		
				Initial triggers	3				
	Cat 1.1	Cat 1.2		Cat 2.1	Cat 2.2		Cat 3.1	Cat 3.2	
Risk (E2)	< 7	£13		< 21	< 21		> 20	> 20	
Structure Attribute	Outbuildings Ancillary Buildings Sheds	Simple storey oup to two dwelling by side NZS 36 4229, a plumbin PS if applica	design vo gs side only 604 and assoc	Multi storey residential up to 3 storeys Ret. walls Specific design Pool in ground	Residential complex design >3 storeys		> 3 storeys High Weathertight risk residential High level residential care Complex plumbing	Publicly owned buildings Multi storey Waste wate plants Bridges	
Use	Not intended for human habitation	Reside Dairy s	ntial	Multiple Residential Specific design Dairy Sheds	Residenti Shop fit of or uncomplic commerce less than 3 less than people, no open to people of the p	uts cated ial FHC 10 ot	Care facility either residential or assembly Commercial SED engineer design	Restrained care Assisted care Unlimited	
Crowd activity		Decks up to 3.0 metres Plumbing works		SR	SA, WL		CS,,CO, WM	CL, SC, SD, WH Open ended	
Other	No plumbing work Heating Units			3.0 metres Plumbing		Decks over 3.0 metres Alternative solutions	3.0 metres assessme accessibil		Compliance schedule required Alternative solutions may require Peer review
	e solution	e as app	Alt sol	uti n m		C	if for the state of		
	or drainage						specific fire design		
Mech vent				ch report			pecific eng design		
iviech vent	liatiOH		Compi	iance schedule		Othe	er spec design		
Building C	ategory Verified	YES/N	0		ANO		cating Officer's Na	me)	
BC Allocat	ed To:	UDRTS				2-10	-07		
			icer's Na	ame)			Date		

Reviewed for accuracy of category

PIM NOTES

CONTACT ADDRESS BUILDER:	PERSON: Graham OF WORK: 475 A Rd, Signature He ION OF WORK:	Davison Conawapou Hw Lot 1	VALUATION NO	:			
DATE	ACTIV	'ITY	OFFICER	HOURS	RATE	AMOUNT	
3/8/00	Planna		0	t	180-	250	
		CODAMATION	AAFAAODANIDI	IM PROC	TOTAL PAID BALANCE		
	PROPERTY INF						
Planning		The second liverage and the se	laced in Tray		Date Comp	leted	
Water and	Sewer	21/1/		3/8/00	1		
Vehicle Cro	ossing						
Compliance Check with District Plan rules PIM Note Compliance Check with Resource Consent number RM granted I							
X	Designations/Protected Trees/Historic sites etc.						
1		all boundaries	the distances fro				
	Complies: Ves No. 4		7	Date 5/2	1/09		
Officers' No	ames						
	ANDRE			C	rec		

SERVICES	
WATER MAIN	APPLICATION FORM SENT
SIZEmm LOCATION	
CONNECTION REQUIRED YES/NO	FEE PAYABLE \$ mm
SEWER MAIN	APPLICATION FORM SENT
SIZEmm LOCATION	
CONNECTION REQUIRED YES/NO	FEE PAYABLE \$ SIZE mm
STORMWATER	APPLICATION FORM SENT
MAIN SIZEmm LOCATIO	ON
CONNECTION REQUIRED YES/NO	FEE PAYABLE \$ mm
DISCONNECTION AND RECONNECT	TION FEES (DEMOLITION & REMOVALS)
WATER	SEWER
SIGNATURE	DATE

OTHER (e.g. HEALTH/STRUCTURAL etc)

LICENCES REQUIRED (Health/Dangerous Goods etc)

SIGNATURE

DATE

Tax Invoice/Statement: 7528

GST Reg. No: 52-769-477 Invoice Date: 13 August 2009



Signature Homes PO Box 3022 New Plymouth 4341



Address:

Private Bag 902

Phone:

Hawera 06 278 0555 0800 111 323

Free Phone: Facsimile:

06 278 8757

Email: Website: contact@stdc.govt.nz www.stdc.co.nz

ebsite: ww

Application Number:

BC090487

Description:

New Dwelling

Owner:

R L Patterson, T Sakamoto

Location Address:

473B Manawapou Road Hawera 4610

Charge Description	Charge	GST	Amount
Building Consent Administration Fee	\$88.89	\$11.11	\$100.00
Dept Building & Housing Levy	\$356.70	\$44.59	\$401.29
Dept Building & Housing STDC commission	\$11.03	\$1.38	\$12.41
BRANZ Levy	\$203.70	\$0.00	\$203.70
BRANZ STDC Commission	\$6.30	\$0.00	\$6.30
Code of Compliance Certificate Fee	\$88.89	\$11.11	\$100.00
Rural/Residential Inspection Fee	\$880.00	\$110.00	\$990.00
Building Consent Processing/Plan Checking	\$415.56	\$51.94	\$467.50
Planning Assessment	\$24.44	\$3.06	\$27.50
Total	\$2,075.51	\$233.19	\$2,308.70

We look forward to receipt of your payment to enable completion of your consent.

Remittance Advice

Please post to:

South Taranaki District Council Private Bag 902 Hawera 4640 Application Number: BC090487 Applicant: Signature Homes Amount Due: \$2,308.70

Processing Checklist – New Dwelling / Alterations

Page 1 of 8

Applicant Name: R. Potter	moto- BC No: 090487			
Site Address: Lot 1 Lins	Date: 4-8-09			
Notes:		A c	Λ	
Section 112 Alteration to Exi	etina	Ruild	linge	Assessed:
Schedule 1. Exempt Building			iiigs	Assessed:
Item to be checked for	P	lans/Sp Checke		Details of Processing & Comments:
compliance: with the NZ Building Act 2004, NZBC & Approved Documents Note: N/A = this item is not applicable to this application and has not been assessed	Complies	Non -Complying	N/A	Comments must be made for: 1. Non-complying items 2. Alternative solutions & how compliance with NZBC achieved
Building consent detail				
Classification of exposure zones		Yes/No	0	7. 7
determined? Site visit conducted?		Yes/No	1	Zone I
Many of the property of the second se			9	
s this a sloping site? Earth brick/straw bale construction		Yes/N	à	
Siting measurements from min. 2		'Yes/N		as per pag AAA
Sloping site accurately shown on plans			1	1 1
Foundations	77	13.01.19		
Engineer detail peer reviewed (by 2 nd engineer/PS1/2 provided)			1	(Eng. to initial items checked)
Engineer detail correctly shown on plans				Shoul Properties

(1) Utilise one of the following:

Tick (✓) This item complies with the NZ Building Code at the date of processing Cross (*) This item does not comply with the NZ Building Code at the date of processing N/A Means this item is not applicable to this project and has not been assessed.

Item to be checked for		ns/Spe hecke		Details of Processing & Comments:		
compliance: with the NZ Building Act 2004, NZBC & Approved Documents Note: N/A = this item is not applicable to this application and has not been assessed	Complies	Non -Complying	NA	Comments must be made for: 1. Non-complying items 2. Alternative solutions & how compliance with NZBC achi		
Ribraft floor used	1 *	es/No	0			
Concrete strength specified	11			Specified mPa: 40		
Footing dimensions	1			Depth: 305 mm Width: 300mm		
Pad & beam dimensions	./			Details:		
Post footings	/		1	Depth: Width:		
Reinforcing: size, type, placement on plans	/			Details: Did Layer as pur Sinh shoult details		
Concrete block foundation detail			1	0		
Foundation walls			以 编章			
Floor heights in relation to finished ground levels			1	Details:		
Heights & dimensions of foundation walls shown			1	Details:		
Foundation height in respect of subfloor access, pile heights etc.			1	Details:		
Reinforcing: size, type, placement on plans			1	Details:		
Ventilation set out						
Subfloor access door			1,			
Retaining wall detail (incl. landscape walls)			J			
Waterproofing of retaining walls on plans			/	Type:		
Protection of waterproofing detailed on plans			1			
Drainage of retaining walls detailed on plans			1			
Ordinary piles:						
Footing dimensions			1/	Details:		
Pile dimensions shown on plans		-	1/	Details:		
Set out, spacing & treatment			11	Treatment:		
Ordinary pile connections shown	THE REAL PROPERTY.		1			
Driven piles		13.2		Totalesant		
Size, set out, spacing & treatment			1	Treatment:		
Specification for driving of piles Certificate required confirming piles driven to approved specification entered on BC conditions?			1			
Anchor piles:						
Footing dimensions			1,	Depth: Width:		
Pile dimensions shown on plans			1,	Details:		
Set out, spacing & treatment			1	Treatment:		
Anchor pile connections shown (min. 12Kn)			/			
Braced piles:				420.00		
Footing dimensions			1/	Depth: Width:		
Pile dimensions shown on plans			11	Details:		
Set out, spacing & treatment Braced pile connections shown (min.			1	/ Treatment:		
12Kn) Column / post footings:		4	Ti h			

Item to be checked for		ns/Sp Checke		Details of Processing & Comments: Comments must be made for: 1. Non-complying items 2. Alternative solutions & how compliance with NZBC achieved			
compliance: with the NZ Building Act 2004, NZBC & Approved Documents Note: N/A = this item is not applicable to this application and has not been assessed	Complies	Non -Complying	N/A				
Footing dimensions			J,	Depth: Width:			
Post dimensions shown on plans Chimney/fireplace foundation detailed on plans			1	Details:			
Slab on Ground	E SAN						
Concrete strength specified	Grand falca	s For a step in	7	Specified mPa:			
Floor heights shown on plans			1	Details:			
Design for foundation >600mm							
Hardfill detail			1	Type:			
Compacted fill	-		1	1)50.			
(report required if > 600mm in depth)			1				
Damp proof membrane			1	Type:			
Slab Thickening			1	7,75			
Pads			1				
Reinforcing: size, type, placement on			1	Details:			
plans			1	Botano.			
Supplementary reinforcing detailed on plans			1				
Shrinkage control joints detailed on plans		-	1				
Free joints (slabs > 24m) detailed on		+	1				
plans			1				
Split floor levels	Line Side	小姐姐	Taxan s				
Reinforcing: size, type, placement on	7	No. of Contract of	CONTRACTOR OF STREET	Details:			
plans	1						
Waterproofing detail (DPM)	1			Type: 0.25 mers- Dom as per Risant spen			
Masonry foundations & walls				The same of the sa			
	SALES OF STREET	SA STE	1	Charified mDay			
Concrete strength specified	-	-	1	Specified mPa:			
Masonry detail	-	-	/	Time 0 Cine			
Reinforcing detail			1	Type & Size			
Engineer detail peer reviewed (by 2 nd engineer/PS1/2 provided)			1	(Eng. to initial items checked)			
Engineer detail shown on plans			1				
Timber Treatment		15 A . 10 . 10 . 10 . 1					
Timber grade & treatment schedule (for all timber)	1			as per green Titled Timber			
Framing	A 2157						
Wind zone identified (so fixings can be checked)	1			Hid as and Motor on my An			
Exposure zones identified (so fixings can be checked)	1			Sea corre			
Bearer size & spans	THE	1	1	Les spring			
	-	-	1				
Bearer fixing details to foundation walls shown on plans	1	4	/				
Joist size & spans	1						
Support of walls parallel to floor joists	1						
Split floor level framing shown on plans	1			detail py A21			
Flooring material specified	1,			Type: concate			
Bottom plate fixing (walls) detailed				MIZ Boit Hadre as per detail Ail			

Item to be checked for		ns/Spe hecke		Details of Processing & Comments:				
with the NZ Building Act 2004, NZBC & Approved Documents Note: N/A = this item is not applicable to this application and has not been assessed	Complies	Non -Complying	N/A	Comments must be made for: 1. Non-complying items 2. Alternative solutions & how compliance with NZBC achieved				
Stud height & spacing	1			as per detail po AII				
Verandah post, beam & fixing detail shown on plans	1		1					
Lintel sizes & specifications shown on	/			A-12				
plans	V			as per Brow dan 19 A7				
Design certificate(s) or calculation table(s) provided	1			design title syphil on pr A7				
Cantilever beams, corner window etc.			1	11 10				
Engineer beams & supports peer				(Eng. to initial items checked)				
reviewed (by 2 nd Engr/PS1/2 provided)	-		V	approved Engrice eales explicit				
Engineer details, incl. connections shown on plans	1			Detail as pur px A20				
Ceiling batten size, grade, spacing, span	1		1	Fred Roslo & GOO'S				
Ceiling joists size, spacing, span			1	Diret his to underside of Truck flow is it				
Strongbacks/runners size, spacing, span			1					
Wall & ceiling linings shown on plans	1			As per detail of An				
Framing set out suitable for linings	1		1	113 100 5001				
Fire rated walls & ceilings shown on plans			1/					
Fire design checked			11					
Fire wall detail e.g. fixings etc. shown on			11					
plans	1		4					
Truss manufacturer's design certificate				As per Trass schelibs spoul				
Truss manufacturer's set out detail	1							
Truss manufacturer's fixing detail	1							
Point loads to lintels identified	1		++					
Rafter size, spacing & span	-	-	13/					
Rafter fixing shown on plans	-	-	+4					
Underpurlin size shown on plans	-	-	11					
Strutting beams size shown on plans Struts loading on strutting beam or load			1					
bearing walls			J					
Ridge beam detail and fixings shown on			1					
plans Purlin/batten size, spacing & span	1			As per potes on pg A3				
Purlin/batten fixing detail specified	1			La L				
Skillion roof detail	1							
Building paper/wrap specified – walls		1		Type: Please indeste the type and inchest wife				
Building paper/wrap specified - roof		/		Type: to be used for Roll walk				
Chimney construction detail on plans			1					
Chimney roof restraint detail			J					
Roof membrane substrate detail shown on plans			1					
Roof framing set out suitable for substrate			1					
Roof cladding specified	1			Type: Trindede @ 5° OK				
Roof cladding suitable for min. roof pitches (length of sheet may effect min. pitch)	1							
Internal gutter(s) construction detail shown on plans			1					

Item to be checked for		ans/Spe Checke		Details of Processing & Comments:				
compliance: with the NZ Building Act 2004, NZBC & Approved Documents Note: N/A = this item is not applicable to this application and has not been assessed	Complies	Non -Complying	N/A	Comments must be made for: 1. Non-complying items 2. Alternative solutions & how compliance with NZBC achieved				
Internal gutter(s) overflow detail shown on plans			1					
Balcony drainage & overflow detail shown on plans	1		1	over dest.				
Deck joists size, spacing & span	1							
Saddle flashings fitted to deck joists	1			Octail ou A13				
Deck stringer spaced off cladding min. 12mm		1		Engres detils Sor upper decle Bedluts as per				
Fixing of deck barrier detail		1		Note on Octob Box AD				
Pergola/porch framing detail shown on plans		1						
Pergola/porch fixing detail shown on plans								
Bracing								
Calculations incl. subfloor / lower / upper storeys (circle calculations applicable)	1	1						
Fixing details for framing and sheet material provided	4	1		Sinda				
Elements equally distributed throughout building				4,3				
Double sided bracing of exterior walls checked								
Interior walls: bracing limitations e.g. bathrooms								
Ceiling diaphragms shown on plans								
Roof bracing shown on plans								
Interior								
Insulation walls, ceiling & subfloor shown on plans	COLUMN TO SERVICE			R Rating				
Waterproofing detail showers, floors, decks/balconies								
Stair, handrail & barrier details shown on plans								
Stair min. tread max. rise specified								
Fireplace / solid fuel heater shown on plans								
Manufacturers' specifications provided		Yes/N	0					
Flue location shown on elevations								
Smoke alarms specified & shown on plans								
Light & visual awareness (incl. attic windows & skylights)								
Area of glazing > 30% of wall								
Ventilation (incl. all habitable spaces)								
Safety glazing detail bathrooms, window seats, etc.								
Air noise: design, construction detail shown on plans								
Air noise: producer statement – design received								

Item to be checked for		ns/Spe hecke		Details of Processing & Comments:				
compliance: with the NZ Building Act 2004, NZBC & Approved Documents Note: N/A = this item is not applicable to this application and has not been assessed	Complies	Non -Complying	NA	Comments must be made for: 1. Non-complying items 2. Alternative solutions & how compliance with NZBC achie				
Food preparation & prevention of contamination								
Sink & preparation surfaces	1							
Food storage	1							
Wall linings	1							
Exterior		1.						
E2 risk matrix assessment checked	1							
Exterior cladding(s) specified	/							
System specification provided	1	/						
Cavity system details (batten size, fixing & treatment)	1							
Control joints shown on plans (solid plaster)	1,							
Vermin proofing	11							
Internal & external corner details	1							
Junction details of dissimilar materials	1,							
Bottom edge clearances to ground levels &/or decks	1							
Brick veneer cavity, fixing & waterproofing detail	1							
Double studs or blocking to openings for brick veneer ties	/							
Brick veneer > 4m high	/							
Brick veneer lintel bars	1							
Brick veneer shelf angles	1							
Brick veneer panel widths	1/							
Plaster supports	V							
Flashings								
Windows & doors, meter boxes, gas boxes, etc.	1		1					
Apron flashing detail	1							
Chimney & flue flashing detail	/							
Stop end apron flashing detail	/	1						
Sill threshold flashing detail		1						
Soffitt/wall junction flashing detail	/							
Penetrations @ fixing points, pergolas, decks	/							
Penetrations of electrical cables	/							
Parapets - caps, walls, intersections, etc.	/							
Intersections, roof walls, dissimilar claddings	1							
Stairs & Barriers								
Exterior stair construction detail shown on plans			/					

Item to be checked for compliance: with the NZ Building Act 2004, NZBC & Approved Documents Note: N/A = this item is not applicable to this application and has not been assessed		ns/Spe Checke		Details of Processing & Comments: Comments must be made for: 1. Non-complying items 2. Alternative solutions & how compliance with NZBC achieved				
		Non -Complying	N/A					
Exterior balcony, stair & landing barrier detail shown on plans	1							
Stair min. tread max. rise specified								
Slip resistant surface (main entry decks & stairs)				Type:				
Plumbing				Plumbing Processing Officer:				
Schematic layout provided - waste/drains		Yes/No						
Discharge length of pipes	1							
Discharge pipes venting	1							
Soil stack layout provided	1	Yes/No						
Soil stack layout	1	103/140						
(incl. relationship to floor joists)	1/							
Soil stack venting			San					
Water supply	15.12							
Type of material			1	Type:				
Backflow prevention	~	-	1					
Tempered hot water Provision of laundering facilities	7		1					
Water main pressure for sprinklers	,		1					
Drainage	CHARLE STATE							
Stormwater layout shown on plans								
Gutter & outfall sizes in relation to roof size	1		1					
Site stormwater/surface water collection & disposal detail (Erosion of sloping sites)								
Water tank overflow detail on plans (Erosion of sloping sites)			J					
Sewer layout	-			AS/NZS3500 AS/G13 Oth				
Gulley traps/ overflow relief gullies (ORGs)	1							
Sewer venting)							
Effluent disposal								
Septic tank & effluent disposal design	1,			Tank Size:				
Effluent disposal site plan	1			TYPE: Line Field Oth				
Proximity to water course(s) & buildings	1							
Stormwater cut off drain above effluent bed shown on plans (Sloping sites)	J							
Site Servicing	Section 1	(1)						
Is site serviced?		Yes/No						
Application suspended for further information?		Suspe Suspe		Date: 7-8-09 Lifted Date: Lifted Date:				

South Taranaki District Council Private Bag 902, Hawera Telephone: 06 278 0555 or 0800 111 323 Facsimile: 06 278 8757



Producer Statement Assessment

eatures/Items to be checked			
egister checked	/	Author qualifications	1
not registered – Application actioned	1	Insurance type shown	/
riginal	1	Insurance cover provided	/
ategory shown	/	Any limitations and/or assumptions shown	1
oject specific	1	Statement signed	1
ocation identified	1	Other verifications considered are listed	1
wner identified	/	Does it reference BC documents?	1
uilding work described	/	Supporting information provided	1
andards or codes specified	/	Has a peer review been conducted?	/
asis of issue stated	/	Should a peer review be undertaken?	/
uthor name	/	Any conflict of interest?	/
thor address /	1	Any special inspection requirements	1
PS1 PS2 the supporting information provided: RK reft Stor System For Support Steed in 5	Alex	PS3 PS4 PS4 Calculy appoint from my and 1st the deally	
	11. 15	pections are carried out:	

05 August 2009

Signature Homes
PO Box 3022
New Plymouth 4341

Dear Applicant

Re: Building Consent Application No BC090487
New Dwelling
Manawapou Road Hawera 4610

Your application for a building consent has been checked and the proposal does not comply with the requirements of the New Zealand Building Act in the following respects:

- As per our phone conversation could you please supply new plans as the ones supplied cannot be read due to fading?
- Please confirm compliance with NZBC H1 with regard to Glazing.
- Please indicate the type and make of build wrap to be used on the roof and exterior walls.
- Please supply construction details for the upper deck including footings, support pole type and size, connection details of beams and steel work.
- Please supply fixing details for the sheet bracing systems proposed.
- Please supply a threshold detail for all exterior doors.

When your plans and/or specifications have been resubmitted and amended to comply with the above requirements, approval of your application can recommence.

Please feel free to contact me further should you have any queries regarding the above.

Yours sincerely

Andre Phillips

Building Control Officer

05 August 2009

Signature Homes PO Box 3022 New Plymouth 4341

Dear Applicant

Re: Building Consent Application No BC090487 New Dwelling Manawapou Road Hawera 4610

Your application for a building consent has been checked and the proposal does not comply with the requirements of the New Zealand Building Act in the following respects:

- As per our phone conversation could you please supply new plans as the ones supplied cannot be read due to fading?
- Please confirm compliance with NZBC H1 with regard to Glazing.

When your plans and/or specifications have been resubmitted and amended to comply with the above requirements, approval of your application can recommence.

Please feel free to contact me further should you have any queries regarding the above.

Yours sincerely

Andre Phillips **Building Control Officer**

Categorisation of Building Consent Applications and Allocation for Processing Address Lot 1-475 Management Roy Hawda BC 090487...

	CATEGORY			CATEGORY	1	CATEGORY			
1.1				2.1			3.1 3.2		
				2.2					
				Initial triggers	3				
	Cat 1.1	Cat 1.2		Cat 2.1	Cat 2.2		Cat 3.1	Cat 3.2	
Risk (E2)	2) < 7 < 13			< 21	< 21		> 20	> 20	
Structure Attribute	Outbuildings Ancillary Buildings Sheds	Simple single storey design up to two dwellings side by side only NZS 3604 and 4229, assoc plumbing PS if applicable Residential Dairy sheds		Multi storey residential up to 3 storeys Ret. walls Specific design Pool in ground	Residential complex design >3 storeys Residential Shop fit outs or uncomplicated commercial less than FHC 3 less than 10 people, not open to public, no food handling SA, WL		> 3 storeys High Weathertight risk residential High level residential care Complex plumbing	Publicly owned buildings Multi storey Waste wate plants Bridges Restrained care Assisted care Unlimited CL, SC, SD WH Open ended	
Use	Not intended for human habitation			Multiple Residential Specific design Dairy Sheds			Care facility either residential or assembly Commercial SED engineer design		
Crowd activity				SR			CS,,CO, WM		
Other	No plumbing work Heating Units	Decks up to 3.0 metres Plumbing works		Decks over 3.0 metres Alternative solutions	May require assessment for accessibility and compliance schedule		Compliance schedule required Alternative solutions may require Peer review	Historic buildings Bridges SED Mechanical services	
	n consists of (circle								
Acceptable		Alt solu				pecific fire design			
Plumbing or drainage Geotec						ecific eng design			
Mech vent	ilation	(Compli	ance schedule		Othe	er spec design		
Building C	ategory Verified (YESINO		>		(Alloc	Dower cating Officer's Na	me)	

Reviewed for accuracy of category



COMPUTER FREEHOLD REGISTER **UNDER LAND TRANSFER ACT 1952**



Search Copy

Identifier

398113

Land Registration District Taranaki Date Issued

09 July 2008

Prior References

308898

Estate

Fee Simple

Area

3698 square metres more or less

Legal Description Lot 1 Deposited Plan 399802

Proprietors

Ross Leslie Patterson and Tsunako Sakamoto

Interests

Land Covenant in Easement Instrument 7943586.1 - 23.9.2008 at 9:00 am 7926467.3 Mortgage to TSB Bank Limited - 30.9.2008 at 3:59 pm



SPECIFICATION

FOR

PROPOSED ADDITION

FOR



Ross Patterson &

Tsunako Sakamoto

LOT 1, DP399802

475 Manawapou Road, HAWERA



SCOPE

This contract includes the supply and delivery of all materials, labour, fittings etc necessary for the due and proper completion of the building as shown on the drawings and herein specified or as directed by Owner, in accordance with N.Z. Building Code 2004 Regulations to complete this Contract.

Permit, Notices and Fees

The Owner is to apply for and obtain all necessary consent and pay all fees for same.

Insurance

The Builder is to take out Insurance against fire for a sum sufficient to cover the full amount of the contract sum for the period of construction and up to date on which the building is handed over to the Owner. The responsibility of the Builder for the Builder's Risk Cover Insurance shall cease on the date on which the building is handed over by the Builder to the Owner.

Interpretation

All figure dimensions shall be taken in preference to scale and all detail drawings shall supercede those to smaller scale.

Damage

Each trade shall take care to prevent damage or disfigurement of the work of other trades and will be responsible for cost of restoring same.

Materials and Substitutions

Any materials herein specified that are not procurable at the time they are required, thus tending to retard the progress of the contract, may be substituted to conform to the Approved document and with the permission of the Council Owner. The Contractor is to first notify the Owner of any change proposed and at the completion of the contract will adjust any difference in cost.

Site

This Contract is based upon the building site having soil bearing capacity equal to or better than NZS 3604:1999 ground levels as shown on plans.

ACCESS. It is recommended to visit the site before tendering to ascertain all Local conditions and restrictions likely to affect execution of work.