

STATEMENT OF PASSING OVER INFORMATION

This information has been supplied by the vendor or the vendor's agents. Accordingly, Ownly (REAA 2008) and Sold On Kapiti Limited is merely passing over the information as supplied to us by the vendor of the vendor's agents.

We cannot guarantee its accuracy and reliability as we have not checked, audited, or reviewed the information and all the intending purchasers are advised to conduct their own due diligence investigation into the same.

To the maximum extent permitted by law Ownly (REAA 2008) and Sold On Kapiti Limited does not accept any responsibility to any person for the accuracy of the information herein.

SOLD ON KĀPITI

NOTES:

- * IMPORTANT-INSPECTION AUTHORITY TO READ COVER LETTER PRIOR TO COMMENCING VETTING PROCESS
- * ARCHITECTURAL PLANS ARE TO BE READ IN CONJUNCTION WITH THE PROJECT SPECIFICATION & REFERENCED MANUFACTURERS DETAILS
- * A COPY OF THE SPECIFICATION IS TO REMAIN ON SITE FOR THE DURATION OF THE CONSTRUCTION & INSPECTION PROCESS
- * ALSO REFER TO RM200033 FOR APPROVED SITE DEVELOPMENT PLANS

SED:

- * FOUNDATIONS-WITH CONSIDERATION OF WATER TANK
- * BEAMS, LOAD PATH SUPPORT & FIXINGS
- * FIXING OF BRICK LINTELS
- * EYEBROW ROOF CONSTRUCTION-SIGN OFF DESIGN
- * SOFFIT ROOF CONSTRUCTION-SIGN OFF DESIGN
- * BRACING REVIEW-WALLS & ROOF
- * COLUMN FRAMING/SUPPORT INCLUDING HANGING COLUMN
- * DFCK PILES
- * SOAKPIT

NEW HOUSE FOR M PRITCHARD LOT 2 169 MANLY STREET, PARAPARAUMU BEACH

CONTENTS:

1:PROJECT NOTES
2:PROJECT NOTES
3:LOCATION PLAN
4:SITE PLAN
5:FILL CONTROL MITIGATION PLAN
6:FLOOR PLAN-LOWER
7:FLOOR PLAN-UPPER
8:ELEVATIONS
9:ELEVATIONS
10:DRAINAGE PLAN-LOWER
11:DRAINAGE PLAN-UPPER

12:DECK PLAN
13:FOUNDATION PLAN-LOWER
14:FOUNDATION PLAN-UPPER
15:FRAMING PLAN-LOWER
16:FRAMING PLAN-UPPER
17:INSULATION PLAN
18:BRACING PLAN-LOWER
19:BRACING PLAN-UPPER
20:WINDOW SCHEDULE
21:WINDOW SCHEDULE

23:ROOF FRAMING PLAN
24:ROOF PLAN
25:FINISHES PLAN-LOWER
26:FINISHES PLAN-UPPER
27:CROSS SECTION A-A
28:CROSS SECTION B-B
29:CROSS SECTION C-C
30:CROSS SECTION D-D
31:CROSS SECTION E-E
32-45:DETAILS



11 TE HARAWIRA STREET OTAKI—P: 022 607 0234— E: drafted.nz@gmail.com—W: www.drqfted.nz—Job #: 3224

SITE NOTES-GENERAL		
SITE SAFETY/PROTECTION	ENSURE WORK AREA IS SECURED FROM UNAUTHORIZED ENTRY, PROVIDE SAFETY FENCING & SIGNAGE IN ACCORDANCE WITH F5/AS I	
SITE BOUNDARIES	LOCATE ¢ CONFIRM EXISTING SITE BOUNDARIES, IF REQUIRED ENGAGE A REGISTERED SURVEYOR TO INSTALL NEW BOUNDARY PEGS FOR BUILDING SETOUT	
SITE SERVICES	LOCATE ALL SERVICE/SERVICE CONNECTION POINTS ON SITE PRIOR TO COMMENCEMENT OF WORK	
BUILDING PLATFORM	BEFORE A BUILDING IS ERECTED ON ANY SITE, ALL RUBBISH, NOXIOUS ¢ ORGANIC MATTER SHALL BE REMOVED FROM THE AREA TO BE COVERED BY THE BUILDING.	
GROUND BEARING GROUND BEARING CAPACITY MUST BE RECONFIRMED ON SITE FOLLOWING EXCAVATIONS BUT PRIOR PLACING CONCRETE & REINFORCEMENT, MINIMUM GROUND BEARING REQUIREMENTS TO NZS 3604, FIRTH RIBRAFT TECHNICAL MANUAL OR ENGINEERS SPECIFIC DESIGN- REFER PLANS & SPECIFICATIONS		
SEDIMENT CONTROL	NO BUILDING WORK IS TO BE CARRIED OUT UNTIL CONSTRUCTION OF ALL SEDIMENT CONTROL STRUCTURES ARE IN PLACE TO PREVENT ANY BACKFILL OR DEBRIS WASHING INTO ADJACENT PROPERTIES, STORMWATER SYSTEM OR WATERWAYS, ANY STOCKPILED SOIL, CLAY ETC TO BE COVERED WITH IMPERVIOUS TARPAULIN, DOWNPIPES TO BE CONNECTED TO STORMWATER SYSTEM AS SOON AS PRACTICAL	

FOUNDATION NOT	FOUNDATION NOTES		
DPM	THERMAKRAFT THERMATHENE BLACK-250 MICRON CONCRETE UNDERLAY		
FOUNDATION TYPE	RAISED SLAB WITH MASONRY FOUNDATION WALLS ON COMPACTED GRAVEL BED ALL INSTALLED TO ENGINEERS SPECIFIC DESIGN-UPPER RAISED SLAB TO RECEIVE GOMM EXPOL SLABX200 UNDER SLAB INSULATION 20mm H3.2 PLYWOOD TO UPPER LEVEL BATHROOM \$ ALFRESCO.		
	ALL OTHER AREAS 20mm STRAND-BOARD ON NOMINATED JOISTS		
CONCRETE	25MPa RAFT MIX OR RAFT PUMP MIX, CONFIRM INSTALLATION IN ACCORDANCE WITH FIRTH RIBRAFT TECHNICAL MANUAL (ENGINEERS STRUCTURAL DESIGN TAKES PRECEDENCE)		
THICKENINGS	REFER PRE NAIL FRAME \$ TRUSS MANUFACTURERS DESIGN/LAYOUT/ENGINEERS FOUNDATION PLAN FOR ADDITIONAL THICKENINGS/PADS NOT NOTED ON FOUNDATION PLAN		

FRAMING NOTES	FRAMING NOTES		
DPC	THERMAKRAFT PERIMETER BITUMEN DAMP PROOF COURSE		
BOTTOM PLATE HOLD DOWNS GENERAL EXTERNAL WALLS/ INTERIOR LOAD BEARING WALLS	MIOxI40 BOWMAC BLUE HEAD SCREW BOLT WITH 50X50X3mm GALVANIZED WASHERS @ 600 CRS SET 30mm INSIDE INTERNAL LINE OF FRAME FOR MASONRY HEADER BLOCKS \$ 150mm FROM EACH END OF BOTTOM PLATE, ALTERNATIVE BOTTOM PLATE ANCHORS MUST MEET THE REQUIREMENTS OF NZS3604:2011 CLAUSE 7.5.12		
	TIMBER FLOORS-3/90x3.15 GUN NAILS NZS3604:2011 @ 600 CRS		
BOTTOM PLATE HOLD DOWNS GENERAL INTERNAL NON LOAD	8x75 DRIVE PIN \$ WASHER @ GOO CRS		
BEARING WALLS	TIMBER FLOORS-3/90x3.15 GUN NAILS NZS3604:2011 @ 600 CRS		
BOTTOM PLATE HOLD DOWN BRACING ELEMENTS	REFER SPECIFICATIONS FOR BRACING MANUFACTURERS LITERATURE FOR SPECIFIC BOTTOM PLATE HOLD DOWN REQUIREMENTS		
WALL FRAMING	BOTTOM PLATE: 90/1 40x45 H1.2 EXTERNAL WALL STUDS: 90/1 40x45 H1.2 STUDS @ 400 MAX CRS FOR VERY HIGH WIND ZONE, PRENAILERS STRUCTURAL DESIGN TAKES PRECEDENCE INTERNAL WALLS: 90x45 H1.2 STUDS @ 600 MAX CRS FOR VERY HIGH WIND ZONE NOGS: 90x45 H1.2 @ 600/800 CRS, 800 CRS BRICK VENEER CLAD WALLS, ALL OTHER AREAS-600CRS LINTELS: H1.2 MINIMUM AS SPECIFIED BY PRENAILER/FRAMING PLAN TOP PLATE: 90x45/140/190 H1.2 WITH 90/140/190x35 PACKER PLATE AS REQUIRED		
ROOF & CEILING FRAMING	TRUSSES: HI.2 TRUSSES BY LICENSED PRENAILER (ENSURE WEBBING OF GABLE END TRUSSES ALIGNS WITH STUDS BENEATH) RAFTERS: 2/290x45 HI.2 RAFTERS @ 900CRS TO ALL PITCHED CEILING AREAS PURLINS: 90x45 @ 450 CRS MAX (FROM SUPPORT TO GABLE END VERGE) - FIXED WITH I/I OG SELF DRILLING SCREW 80mm LONG CEILING BATTENS: GIB RONDO CEILING BATTENS @ 600mm CRS MAX FOR I 3mm GIB CEILING LININGS OR 400mm CRS MAX FOR I 0mm GIB CEILING LININGS		
FRAMING FIXING	REFER SPECIFICATIONS FOR ATTACHED PROPRIETARY FRAMING FIXING SPECIFICATION		
PRE-NAIL FRAMES \$ TRUSSES	IN THE EVENT OF CONTRADICTION, LICENSED PRE-NAIL FRAME \$ TRUSS MANUFACTURERS DESIGN TAKES PRECEDENCE OVER ARCHITECTURAL PLANS-IF IN DOUBT CONTACT DRAFTED.NZ FOR CLARIFICATION		

CLADDING NOTES	
BUILDING WRAP	THERMAKRAFT WATERGATE PLUS INSTALLED TO MANUFACTURERS INSTALLATION INSTRUCTIONS, REFER ATTACHED SPECIFICATIONS
FLASHING TAPE	THERMAKRAFT ALUBAND WINDOW FLASHING TAPE SYSTEM
POLYPROPYLENE INSULATION RESTRAINT	WHERE EXTERIOR WALL STUDS EXCEED 450CRS INSTALL THERMAKRAFT UNDERLAY STRAP INSTALLED AT 300mm CRS, FIXED HORIZONTALLY & DRAWN TAUT
AIRSEAL	SELECTED EXPANDABLE FOAM OVER PEF BACKING ROD
ROOF UNDERLAY	THERMAKRAFT COVERTEK 401 INSTALLED TO MANUFACTURERS INSTALLATION INSTRUCTIONS, REFER SPECIFICATIONS
EAVES/SOFFIT LININGS	6.0mm FIBRE CEMENT SOFFIT LININGS WITH ARRISSED BUTT JOINTS OVER POLYPROPYLENE TAPE UNDER NOMINATED H1.2 SOFFIT BEARERS/FRAMING
FASCIA/BARGE	SELECTED COLORSTEEL (ALUMINIUM) BARGE CAPPINGS I 25MM COLORSTEEL (ALUMINIUM) BOX GUTTERS \$ 80MM DOWNPIPES INSTALLED STRAIGHT WITH NO BENDS
WALL CLADDING	SELECTED BRICK VENEER CLADDING OVER DRAINED & VENTED CAVITY, VERTICAL BGC STRATUM, STRATUM DUO OFFSET & STRATUM TRIO CAVITY FIXED CLADDING OVER BGC HORIZONTAL CAVITY BATTEN SYSTEM, COLUMNS CLAD WITH VERTICAL JAMES HARDIE (405MM) STRIA CLADDING OVER CASTELLATED H3.1 CAVITY BATTENS
ROOF CLADDING	COLORSTEEL ALTIMATE TRIMLINE METAL ROOFING INSTALLED WITH COLOUR MATCHED \$ COMPATIBLE FIXINGS TO MANUFACTURERS INSTALLATION INSTRUCTIONS

INTERNAL SPECIFICATIONS			
INSULATION	CONCRETE FLOORS: BY RAISED SLAB FOUNDATION WITH GOMM EXPOL SLABX200 UNDER SLAB INSULATION TIMBER FLOORS: R3.2 FLOOR BATTS-WHERE SHOWN WALLS: R2.8 BATTS CEILINGS: R7.0 CEILING BATTS GLAZING: R0.46 FOR STANDARD DOUBLE GLAZING		
INTERIOR LININGS	GENERAL: GIB STANDARD I Omm TO WALLS & I 3mm TO CEILINGS UNLESS NOTED, (SELECTED CEDAR LININGS TO ALFRESCO CEILINGS) WET AREAS: GIB AQUALINE I Omm TO WALLS & I 3mm TO CEILINGS TILING: REFER SPECIFICATIONS FOR GIB AQUALINE WET AREA SYSTEM MANUAL FOR WALL LINING FIXING REQUIREMENTS FOR ALL TILED WALLS OVER GIB PLASTER BOARD IF SELECTED TILES EXCEED MAXIMUM GIB AQUALINE WEIGHT LIMITS REFER TO JH VILLABOARD MANUAL FOR ALTERNATIVE SUBSTRATE SELECTION BRACING: REFER BRACING PLAN & SPECIFICATIONS FOR SPECIFIC BRACING TYPES, INSTALLATION INSTRUCTIONS & HOLD DOWN REQUIREMENTS		
SKIRTING	GOX I 2 SINGLE BEVEL MDF TO ALL AREAS EXCLUDING GARAGE \$ WET AREAS GOX I O SINGLE BEVEL PINE TO GARAGE TILED SKIRTING TO ALL WET AREAS		
SCOTIA	SQUARE STOP THROUGHOUT		
ARCHITRAVES/WINDOW REVEALS	20mm H3. I JAMBS WITH GOX I 2 MDF ARCHITRAVES		
INTERIOR DOORS	2200mm HIGH HOLLOWCORE INTERNAL DOORS WITH 30mm JAMBS, SOFTSTOP CAVITY SLIDER TO MASTER BED, ALL DOOR HANDLES INSTALL I.Om FROM F.F.L		
SHELVING	AS SELECTED BY OWNER		
SHOWERS	ENSUITE: WET AREA SHOWER WITH CENTRE DRAINS \$ TILED FINISH OVER ARDEX SUPERFLEX WATERPROOF MEMBRANE INSTALLED BY LICENSED CONTRACTOR ,BATHROOM: PRE-FORMED ACRYLIC UNIT		
BATH TUB	N/A		
WET AREA FLOOR FINISHES	ALL FLOOR FINISHES TO WET AREAS ARE TO BE IMPERVIOUS, EASILY CLEANABLE & SLIP RESISTANT IN ACCORDANCE WITH DI/ASI-VINYL, PROVIDE (MOULD RESISTANT) SILICONE SEAL AT FLOOR SKIRTING JUNCTION, REFER SPECIFICATIONS FOR EXCERPT FROM E3/ASI, CLAUSE 3.1.1		
WET AREA SURFACE FINISHES	RESENE SPACE COAT OVER GIB AQUALINE TO WET AREA WALLS & CEILINGS, TILED WALLS IN BATHROOM & ENSUITE		
BATHROOM GLAZING	-ALL INTERNAL GLAZING MIRRORS/SHOWER DOORS TO MEET THE REQUIREMENTS OF NZS 4223; -FULLY FRAMED GLAZING TO BE; TOUGHENED OR LAMINATED SAFETY GLASS UP TO 2000 MM OF FFL - REFER NZS 4223.3:2016 TABLE 1 -UNFRAMED PANELS \$ DOORS USING PIVOT OR HINGES: 6 MM TOUGHENED SAFETY GLASS MINIMUM. REFER NZS 4223.1:2016 APPENDIX D FOR THICKNESS		
KITCHEN	ALL KITCHEN/COUNTERS/VANITIES TO BE CONSTRUCTED WITH EASILY CLEANABLE FINISH OF HIGH PRESSURE LAMINATE, PORCELAIN OR ENGINEERED STONE/GRANITE & PRE-FINISHED MELTICA		



NOTES

-DO NOT SCALE FROM DRAWINGS

-DO NOT SCALE FROM DRAWINGS

-CONTRACTORS TO VERIFY ALL MEASUREMENTS & LOCATION OF SERVICES ON SITE PRIOR

TO COMMENCING WORK, CONTACT DRAFTED JULY FOR ANY CONTRADICTIONS OR ONSITE ANOMALIE

-PLANS ARE TO BE CROSS REFERENCED & READ IN CONCURRENCE WITH PROJECT SPECIFICATIONS.

CONSULTANT REPORTS & SPECIALIST DOCUMENTATION

-ALL WORK TO BE CARRIED OUT IN ACCORDANCE WITH THE NEW ZEALAND BUILDING

CODE, RELEVANT DISTRICT PLAN REQUIREMENTS & OR RESOURCE MANAGEMENT ACT

-THE COPPRIGHT OF THIS DRAWING IS VESTED IN DRAFTED JULY & IT MAY, NOT BE

REPRODUCED IN WHOLE OR PART OR USED FOR THE MANUFACTURE OF ANY

ARTICLE WITHOUT THE EXPRESS PERMISSION OF THE COPPRIGHT HOLDERS.

PROJECT: NEW TWO STOREY DWELLING LOT 2, 169 MANLY STREET, PARAPARAUMU CLIENT: M PRITCHARD

PROJECT	NOTE	S		
SCALE AT A3:	DATE:	DRAWN:	CHECKED:	STATUS:
1:50	OCT 25	JS	JS	AMEND
PROJECT NO:	REVISION:	DRAWING NO:	•	
3224		01		

DRIVEWAY, PATH &	DRIVEWAY, PATH & PATIOS		
DRIVEWAYS & PATIOS	DRIVEWAY- SEALED EXPOSED AGGREGATED CONCRETE FINISH PATHS/PATIOS - I OOMM THICK 25 MPa CONCRETE WITH ECONOMESH REINFORCEMENT, CONSULT OWNER FOR SELECTED FINISH, ALL PATHS/PATIOS LAID @ I:IOO FALL AWAY FROM BUILDING, DRIVEWAY INSTALLED WITH FALL AWAY FROM BUILDING, REFER E2/AS I TABLE 18 \$ FIGURE 65 FOR GARAGE DOOR THREASHOLD REQUIREMENTS		
MINIMUM HEIGHT OF FINISHED CONCRETE TO PAVING/ UNPROTECTED GROUND	MINIMUM CLEARANCE FROM FINISHED FLOOR LEVEL TO FINISHED EXT. GROUND LEVEL I 50mm MIN. TO PAVED/SEALED GROUND,225mm min. TO UNPROTECTED GROUND		
SLIP RESISTANCE	ACCEPTABLE SLIP RESISTANCE FOR WALKING SURFACES; PORTLAND CEMENT CONCRETE: BROOMED (CLASS 5 OR 6)(6) OR WOOD FLOAT FINISH (CLASS U2), COATED AND SAND/GRIT IMPREGNATED(5), CRUSHED AGGREGATE, REFER D I /AS I -TABLE 2 FOR FULL LIST \$ REQUIREMENTS		

NATURAL VENTILATION & LIGHT SCHEDULE

SCALE 1:50 NOTES:

-NATURAL VENTILATION G4/AS I -FLOOR TO NET OPENABLE WINDOW/DOOR RATIO OF NOT LESS THAN 5% -NATURAL LIGHT G7/AS I -FLOOR TO NET GLAZED WINDOW/DOOR RATIO OF NOT LESS THAN 10%

ROOM NAME	FLOOR AREA	GLAZED AREA	RATIO	OPENABLE AREA	RATIO
KITCHEN/LIVING/DINING	68.6M2	24.3M2	35.4% > 10%-COMPLIES	9.0M2	13.1% >5%-COMPLIES
SCULLERY	6.3M2	1.3M2	20.6% > 10%-COMPLIES	1.3M2	20.6% >5%-COMPLIES
BED I	17.6M2	3.4M2	19.3% > 10%-COMPLIES	2.1M2	.9% >5%-COMPLIES
BED 2	10.8M2	4.4M2	40.7% > I 0%-COMPLIES	3.7M2	34.2% >5%-COMPLIES
BED 3	14.1M2	7.9M2	56.0% > 10%-COMPLIES	7.1M2	50.3% >5%-COMPLIES
RUMPUS	15.8M2	9.2M2	58.2% > 10%-COMPLIES	7.1M2	44.9% >5%-COMPLIES
OFFICE	8.1M2	1.9M2	23.4% > 10%-COMPLIES	0.95M2	11.7% >5%-COMPLIES
ENSUITE	6.6M2	1.4M2	21.2% > 10%-COMPLIES	0.8M2	12.1% >5%-COMPLIES
BATHROOM I	5.3M2	1.2M2	22.6% > 10%-COMPLIES	1.2M2	22.6% >5%-COMPLIES
W/C	2.1M2	1.0M2	47.6% > 10%-COMPLIES	0.5M2	23.8% >5%-COMPLIES

MECHANICAL VENTILATION REQUIREMENTS

- -INSTALL MANROSE HI SPEED INLINE EXTRACT FAN TO ALL BATHROOMS -VENT DRYER, RANGEHOOD VIA EXTRACT FANS DUCTED IN CEILING VOID TO OUTLET
- GRILLS IN EXTERNAL WALLS/SOFFITS
- -SELECTED FANS TO HAVE A FLOW RATE NOT LESS THAN:
- 25 L/S FOR SHOWERS & BATHS, &:
- b) 50 L/S FOR COOKTOPS.

ARTIFICAL LIGHT REQUIREMENTS

-SPACES WITHIN BUILDINGS USED BY PEOPLE, SHALL BE PROVIDED WITH ADEQUATE

ARTIFICIAL LIGHTING WHICH, WHEN ACTIVATED IN THE ABSENCE OF SUFFICIENT NATURAL LIGHT, WILL ENABLE SAFE MOVEMENT

-IN THE ABSENCE OF NATURAL LIGHT ARTIFICIAL LIGHT SHALL BE PROVIDED TO ACHIEVE ILLUMINANCE AT FLOOR LEVEL OF NOT LESS THAN 20 LUX

-ALL LIGHTING TO BE INSTALLED TO MANUFACTURERS SPECIFICATIONS, ALL DOWN LIGHTS TO BE IC OR IC-F RATED \$ INSTALLED AS PER AS/NZS 60598.2.2 PLUS AMENDMENT A

-EXCEPT FOR EXTERNAL PRIVATE STAIRWAYS, SWITCHES FOR STAIRWAY LIGHTING SHALL BE ABLE TO BE ACTIVATED AT:

- A) THE TOP OF THE STAIRWAY,
- THE BOTTOM OF THE STAIRWAY, AND
- ANY INTERMEDIATE LANDINGS HAVING ACCESS TO OR FROM ANY FLOOR

HEATING REQUIREMENTS

NOTES:

-SELECTED CENTRAL HEATING SYSTEM

-SELECTED ELECTRIC FIRE INSTALLED TO MANUFACTURERS SPECIFICATIONS

ELECTRICAL REQUIREMENTS

NOTES:

-ALL ELECTRICAL INSTALLATIONS, FIXTURES & FITTINGS TO BE INSTALLED IN FULL COMPLIANCE WITH NZBC G9 BY LICENSED ELECTRICAL CONTRACTOR. ENERGY WORKS CERTIFICATE TO BE SUPPLIED TO HOMEOWNER UPON COMPLETION

SMOKE ALARMS

NOTES:

-SMOKE ALARMS TO BE INSTALLED TO COMPLY WITH NZBC C/AS | \$ F7/AS | \$ ARE TO BE LOCATED: ON OR NEAR THE CEILING; IN ALL BEDROOMS, LIVING SPACES, HALLWAYS & LANDINGS; IN A KITCHEN WHERE IT CAN BE SEPARATED FROM THE LIVING SPACES \$ HALLWAYS BY DOORS THAT CAN BE CLOSED. THIS MAY BE A HEAT ALARM TO AVOID NUISANCE ACTIVATIONS. FOR MULTI-LEVEL HOUSEHOLD UNITS, A MINIMUM OF ONE ALARM PER LEVEL. ALARM TYPES:

MAINS POWERED: THIS SYSTEM IS HARDWIRED & DRAWS POWER FROM A 230V AC SOURCE WITH A NON-REMOVABLE BACKUP BATTERY, TO POWER THE SMOKE ALARM DURING PERIODS OF TEMPORARY MAINS POWER FAILURE. THE SYSTEM MUST BE INSTALLED BY A REGISTERED ELECTRICIAN.

WIRELESS: POWERED BY A NON-REMOVABLE, SEALED BATTERY WITH A LIFESPAN OF AT LEAST 10 YEARS, THIS SYSTEM MAY BE INSTALLED BY ANYONE WHILE ADHERING TO MANUFACTURER'S INSTRUCTIONS \$ THE SPECIFIED LOCATIONS REQUIRED BY THE STANDARD. ALL ALARMS MUST INCLUDE A HUSH BUTTON, EITHER ON THE ALARM ITSELF OR IN ANOTHER READILY ACCESSIBLE LOCATION FOR TEMPORARY SILENCE DURING FALSE ALARMS.

	DRAFTED ARCHITECTURAL	Ţ
	<u>DESIGN</u>	ŀ
	11 TE HARAWIRA STREET OTAKI.NZ	-
♦ DRAFTED [PHONE: 022 607 0234 EMAIL: drafted.nz@amail.com	-
	www.drafted.nz	Ι.

NOTES

NOTES

DO NOT SCALE FROM DRAWINGS

-CONTRACTORS TO VERIFY ALL MEASUREMENTS & LOCATION OF SERVICES ON SITE PRIOR TO COMMENCINON WORK, CONTACT DRAFTED NZ FOR ANY CONTRADICTIONS OR ONSITE ANOMALIE -PLANS ARE TO BE CROSS REFERENCED & BEAD IN CONCURRENCE WITH PROJECT SPECIFICATIONS, CONSULTANT REPORTS & SPECIALIST DOCUMENTATION

-ALL WORK TO BE CARRED OUT IN ACCORDANCE WITH THE NEW ZEALAND BUILDING CODE RELEVANT DISTRICT PLAN REQUIREMENTS & OR RESOURCE MANAGEMENT ACT -THE COPYRIGHT OF THIS DRAWING IS VESTED IN DRAFTED NZ & IT MAY NOT BE REPRODUCED IN WHOLE OR PART OR USED FOR THE MANUFACTURE OF ANY ARTICLE WITHOUT THE EXPRESS PERMISSION OF THE COPYRIGHT HOLDERS.

PROJECT: NEW TWO STOREY DWELLING LOT 2, 169 MANLY STREET, PARAPARAUMU

CLIENT:	
M PRITCHARD	

TLE: PROJECT	NOTE	S		
CALE AT A3: :50	DATE: OCT 25	DRAWN: JS	JS	STATUS: AMEND
ROJECT NO: 3224	REVISION:	DRAWING NO: 02		



LOT 2-169 MANLY STREET, PARAPARAUMU BEACH, LOCATION OF NEW HOUSE ON SUBDIVIDED SECTION, SITE DEVELOPMENT IN ACCORDANCE WITH APPROVED RESOURCE CONSENT RM200033



DRAFTED ARCHITECTURAL

<u>DESIGN</u> 11 TE HARAWIRA STREET OTAKI,NZ
PHONE: 022 607 0234
EMAIL: drafted.nz@gmail.com

<u>NOTES</u>

INDIES


- DO NOT SCALE FROM DRAWINGS
- CONTRACTORS TO VERIFY ALL MEASUREMENTS & LOCATION OF SERVICES ON SITE PRIOR
- CONTRACTORS TO VERIFY ALL MEASUREMENTS & LOCATION OF SERVICES ON SITE PRIOR
- TO COMMENDICHING WORK, CONTACT DRAFTED.NY FOR ANY CONTRADICTIONS OR ONSITE ANOMAI
- PLANS ARE TO BE CROSS REFERENCED & READ IN CONCURRENCE WITH PROJECT SPECIFICATIONS,
- CONSULTANT REPORTS & SPECIALIST DOCUMENTATION
- ALL WORK TO BE CARRIED OUT IN ACCORDANCE WITH THE NW ZEALAND BUILDING
- CODE, RELEVAND DISTRICT LAND REQUIREMENTS & OR RESOURCE MANAGEMENT ACT
- THE COPYRIGHT OF THIS DRAWING IS VESTED IN DRAFTED.NY & IT MAY NOT BE
- REPRODUCED IN WHOLE OR PART OR USED FOR THE MANUFACTURE OF ANY
- ARTICLE WITHOUT THE EXPRESS PERMISSION OF THE COPYRIGHT HOLDERS.


PROJECT: NEW TWO STOREY DWELLING LOT 2, 169 MANLY STREET, PARAPARAUMU


CLIENT: M PRITCHARD

3224

LOCATION PLAN STATUS: AMEND N.T.S OCT 25 JS

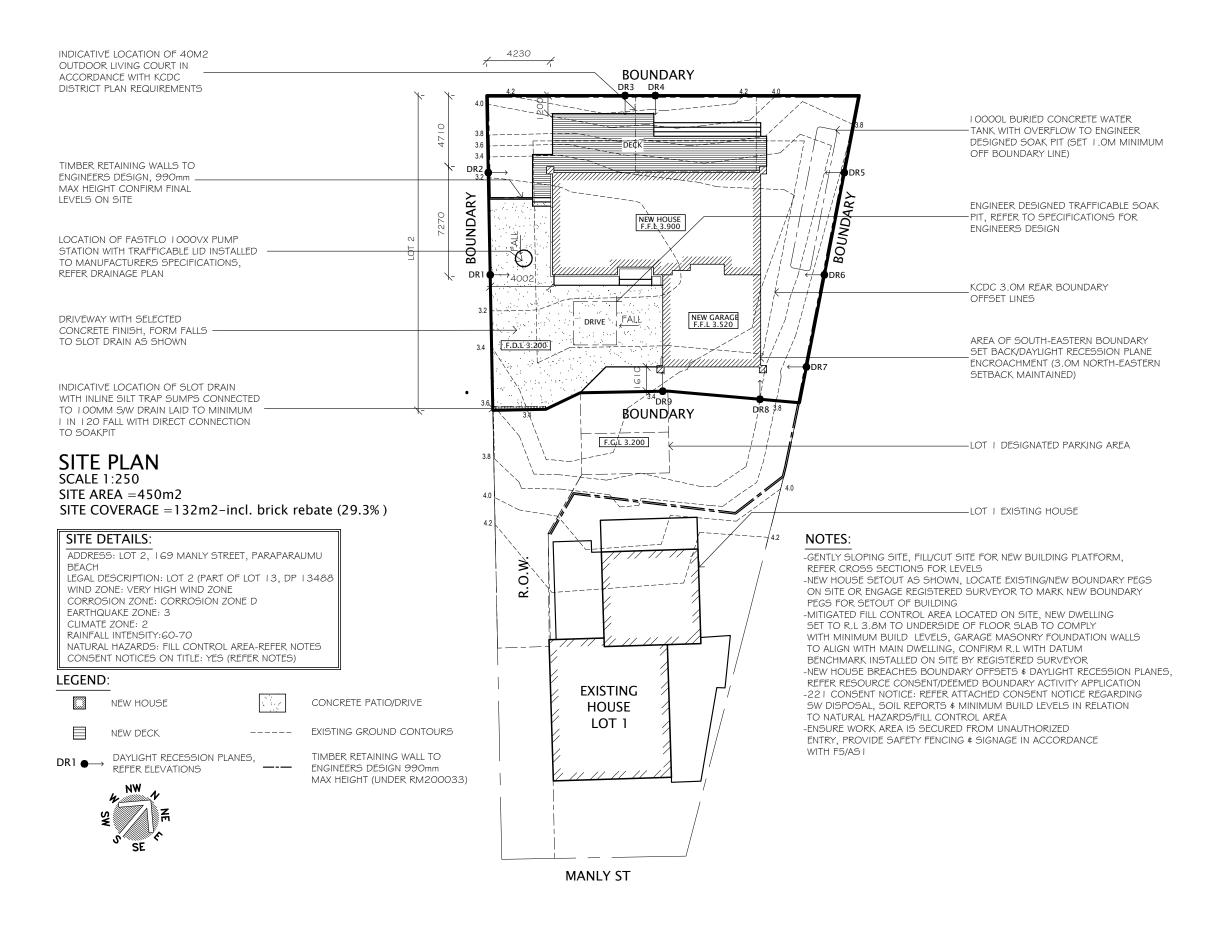

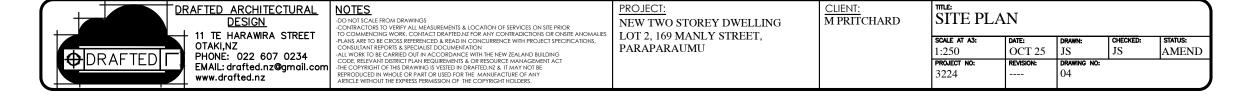

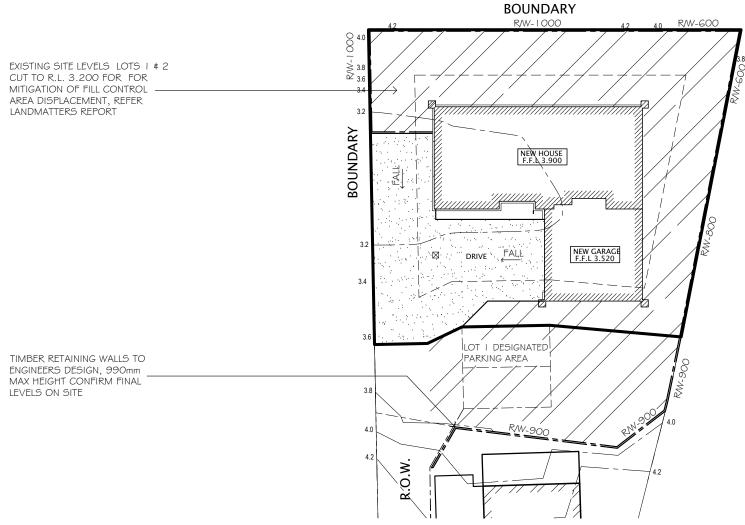

FILL CONTROL MITIGATION PLAN SCALE 1:250 LEGEND: NOTE

R.L. 3.200 FINISHED GROUND LEVEL

-ALL SITE DEVELOPMENT WORK IN ACCORDANCE WITH APPROVED RESOURCE CONSENT-RM200033

TIMBER RETAINING WALL TO ENGINEERS DESIGN 990mm MAX HEIGHT (R/W-900= RETAINING WALL HEIGHT ABOVE PROPOSED GROUND LEVEL)

	DRAFTED ARCHITECTURAL DESIGN
	11 TE HARAWIRA STREET OTAKI,NZ
Φ DRAFTED Γ	PHONE: 022 607 0234 EMAIL: drafted.nz@gmail.com
	www.drafted.nz

<u>NOTES</u>

NOTES.

DO NOT SCALE FROM DRAWINGS

-CONTRACTORS TO VERIFY ALL MEASUREMENTS & LOCATION OF SERVICES ON SITE PRIOR

TO COMMENCING WORK, CONTACT DRAFTED MZ FOR ANY CONTRADICTIONS OR ONSITE ANOMALIES

PLANS ARE TO BE CROSS REFERENCED & READ IN CONCURRENCE WITH PROJECT SPECIFICATIONS,

CONSULTANT REPORTS & SPECIALIST DOCUMENTATION

-ALL WORK TO BE CARRIED OUT IN ACCORDANCE WITH THE NEW ZEALAND BUILDING

CODE, RELEVANT DISTRICT FLAN REQUIREMENTS & OR RESOURCE MANAGEMENT ACT

11 - THE COPYRIGHT OF THIS DRAWING IS VESTED IN DRAFTED MZ & IT MAY NOT BE

REPRODUCED IN WHOLE OR PART OR USED FOR THE MANUFACTURE OF ANY


ARTICLE WITHOUT THE EXPRESS PERMISSION OF THE COPYRIGHT HOLDERS,

PROJECT: NEW TWO STOREY DW LOT 2, 169 MANLY STRE PARAPARAUMU

CLIENT:	
CLIENT: M PRITCHARI)

THE CONTROL MITICATION DIAN

WELLING M PRITCHARD FILL CONTROL WITHGATTE	
SCALE AT AS: DATE: DRAWN: CHECKED	
1:250 OCT 25 JS JS	AMEND
PROJECT NO: REVISION: DRAWING NO:	
3224 05	

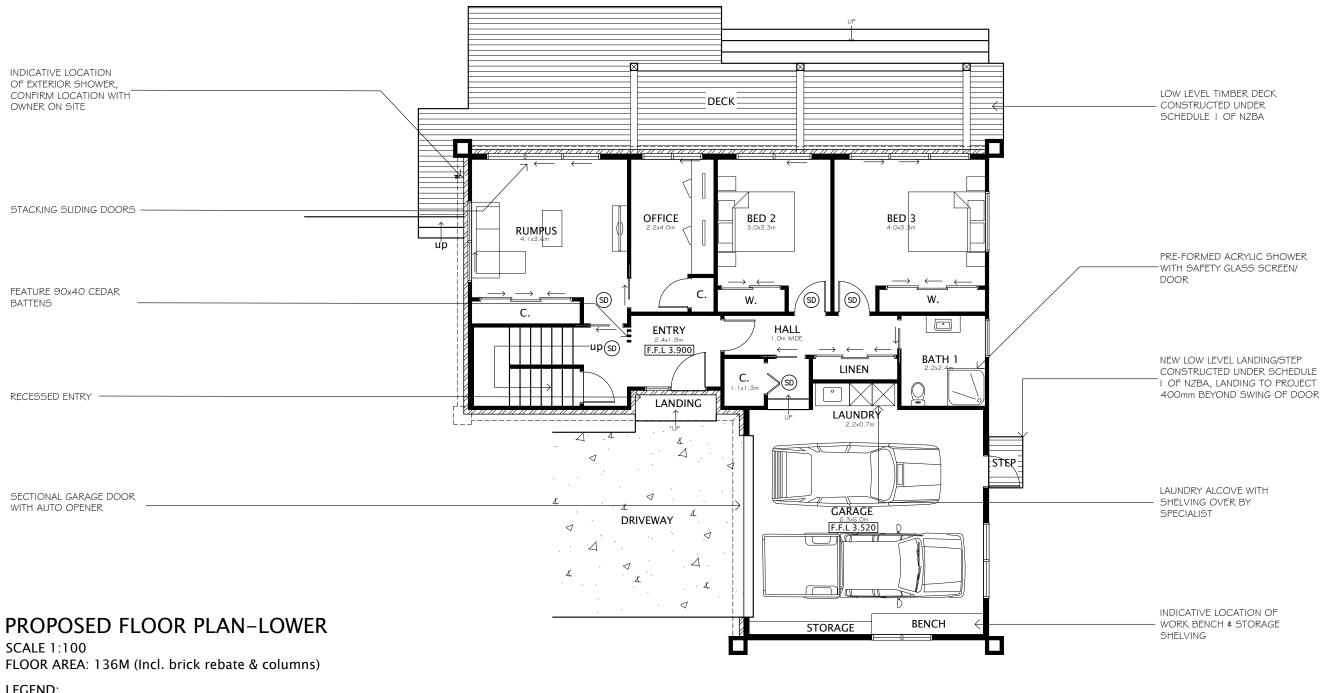

LEGEND:

TIMBER FRAMING

NOMINATED BRICK VENEER

SMOKE DETECTORS INSTALLED (SD) WHERE SHOWN

CONCRETE DRIVEWAY/PATIOS

DOWN TO THE NEAREST MEASUREMENT

TIMBER DECKS *FLOOR PLAN DIMENSIONS MAY VARY SLIGHTLY, ROOM DIMENSIONS HAVE BEEN ROUNDED UP OR

ELEVATION KEY:





<u>NOTES</u> NOTES

DO NOT SCALE FROM DRAWINGS

-CONTRACTORS TO VERIFY ALL MEASUREMENTS & LOCATION OF SERVICES ON SITE PRIOR

TO COMMENCING WORK, CONTACT DRAFTED IN FOR ANY CONTRACTORS TO SER ON SITE ANOMAI

PLANS ARE TO BE CROSS REFERENCED & READ IN CONCURRENCE WITH PROJECT SPECIFICATIONS,

CONSULTANT REPORTS & SPECIALIST DOCUMENTATION

ALL WORK TO BE CARRIED OUT IN ACCORDANCE WITH THE NEW ZEALAND BUILDING

CODE, RELEVANT DISTRICT FLAN REQUIREMENTS & OR RESOURCE MANAGEMENT ACT


-THE COPYRIGHT OF THIS DRAWING IS VESTED IN DRAFTED. ZR. IT IMAY NOT BE

REPRODUCED IN WHOLE OR PART OR USED FOR THE MANUFACTURE OF ANY

ARTICLE WITHOUT THE EXPRESS PERMISSION OF THE COPYRIGHT HOLDERS.

PROJECT: NEW TWO STOREY DWELLING LOT 2, 169 MANLY STREET, PARAPARAUMU

FLOOR PLAN-LOWER M PRITCHARD STATUS: AMEND 1:100 OCT 25 JS PROJECT NO: REVISION: 06 3224

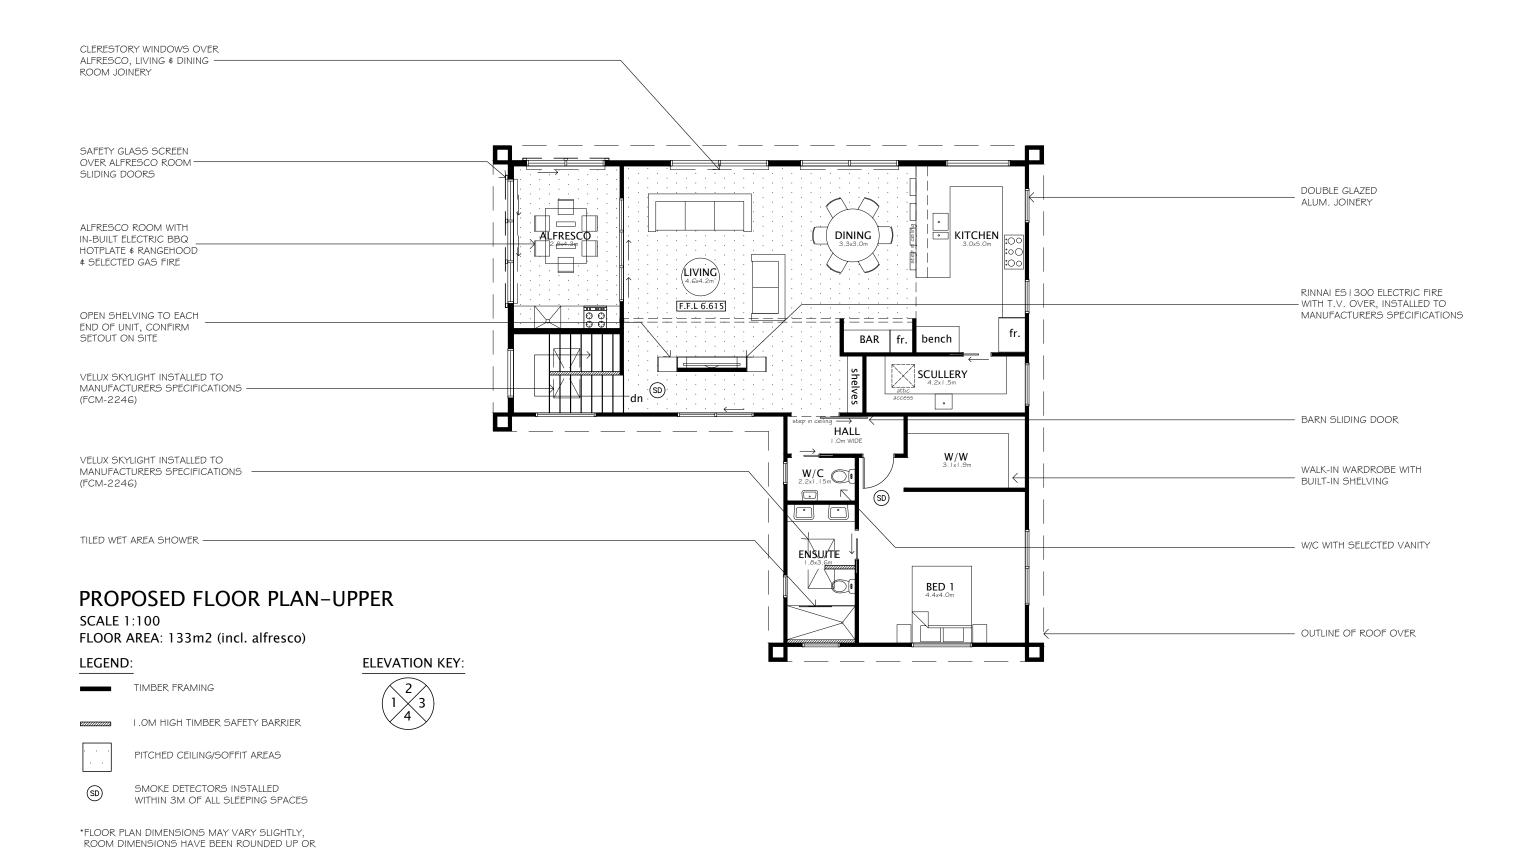

DOWN TO THE NEAREST MEASUREMENT

DRAFTED ARCHITECTURAL PROJECT: FLOOR PLAN-UPPER TOO HOT SCALE FROM DRAWINGS

-CONTRACTORS TO VERIFY ALL MEASUREMENTS & LOCATION OF SERVICES ON SITE PRIOR

-CONTRACTORS TO VERIFY ALL MEASUREMENTS & LOCATION OF SERVICES ON SITE PRIOR

TO COMMENDIGN GOVER, CONTRACT DRAFTED NY FOR ANY CONTRADICTIONS OR ONSITE ANOMAI

-PLANS ARE TO BE CROSS REFERENCED & READ IN CONCURRENCE WITH PROJECT SPECIFICATIONS,

-CONSULTANT REPORTS & SPECIALIST DOCUMENTATION


-ALL WORK TO BE CARRIED OUT IN ACCORDANCE WITH THE NEW ZEALAND BUILDING


-CODE, RELEVANT DISTRICT LAN REQUIREMENTS & OR RESOURCE MANAGEMENT ACT


-THE COPYRIGHT OF THIS DRAWING IS VESTED IN DRAFTED NZ & IT MAY NOT BE


REPRODUCED IN WHOLE OR PART OR USED FOR THE MANUFACTURE OF ANY

ARTICLE WITHOUT THE EXPRESS PERMISSION OF THE COPYRIGHT HOLDERS. M PRITCHARD <u>DESIGN</u> NEW TWO STOREY DWELLING 11 TE HARAWIRA STREET LOT 2, 169 MANLY STREET, STATUS: OTAKI,NZ PARAPARAUMU 1:100 OCT 25 JS AMEND Φ|drafted|Γ PHONE: 022 607 0234 PROJECT NO: REVISION: EMAIL: drafted.nz@gmail.com 07 3224 www.drafted.nz

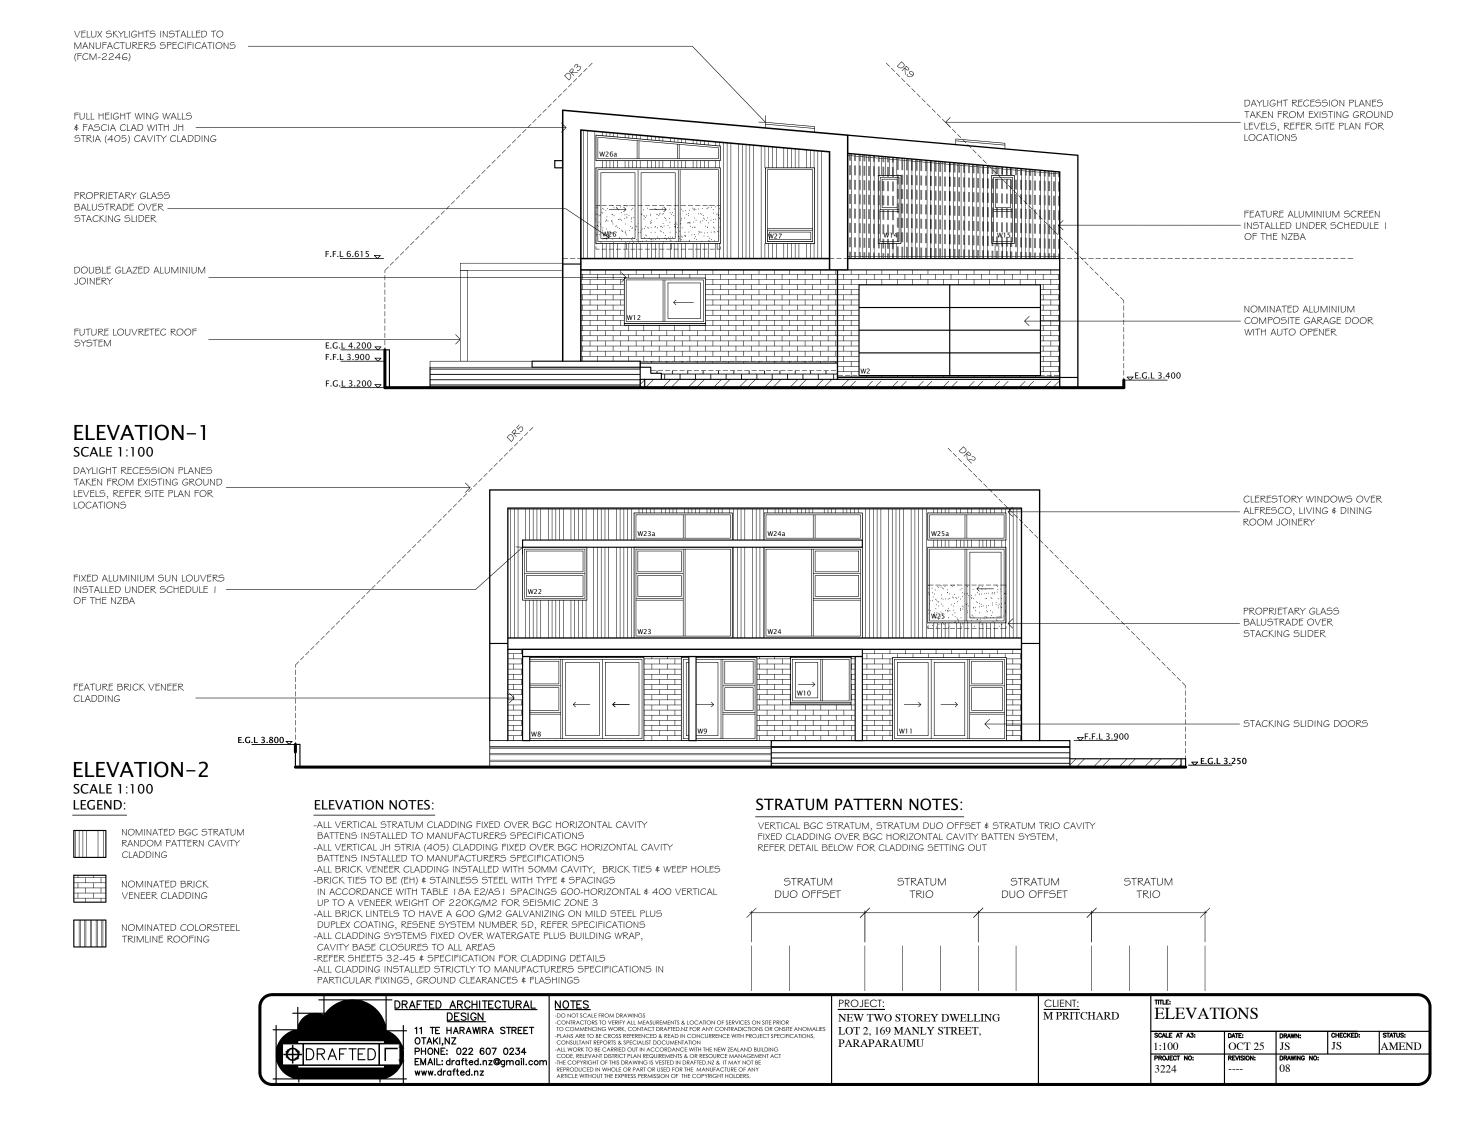

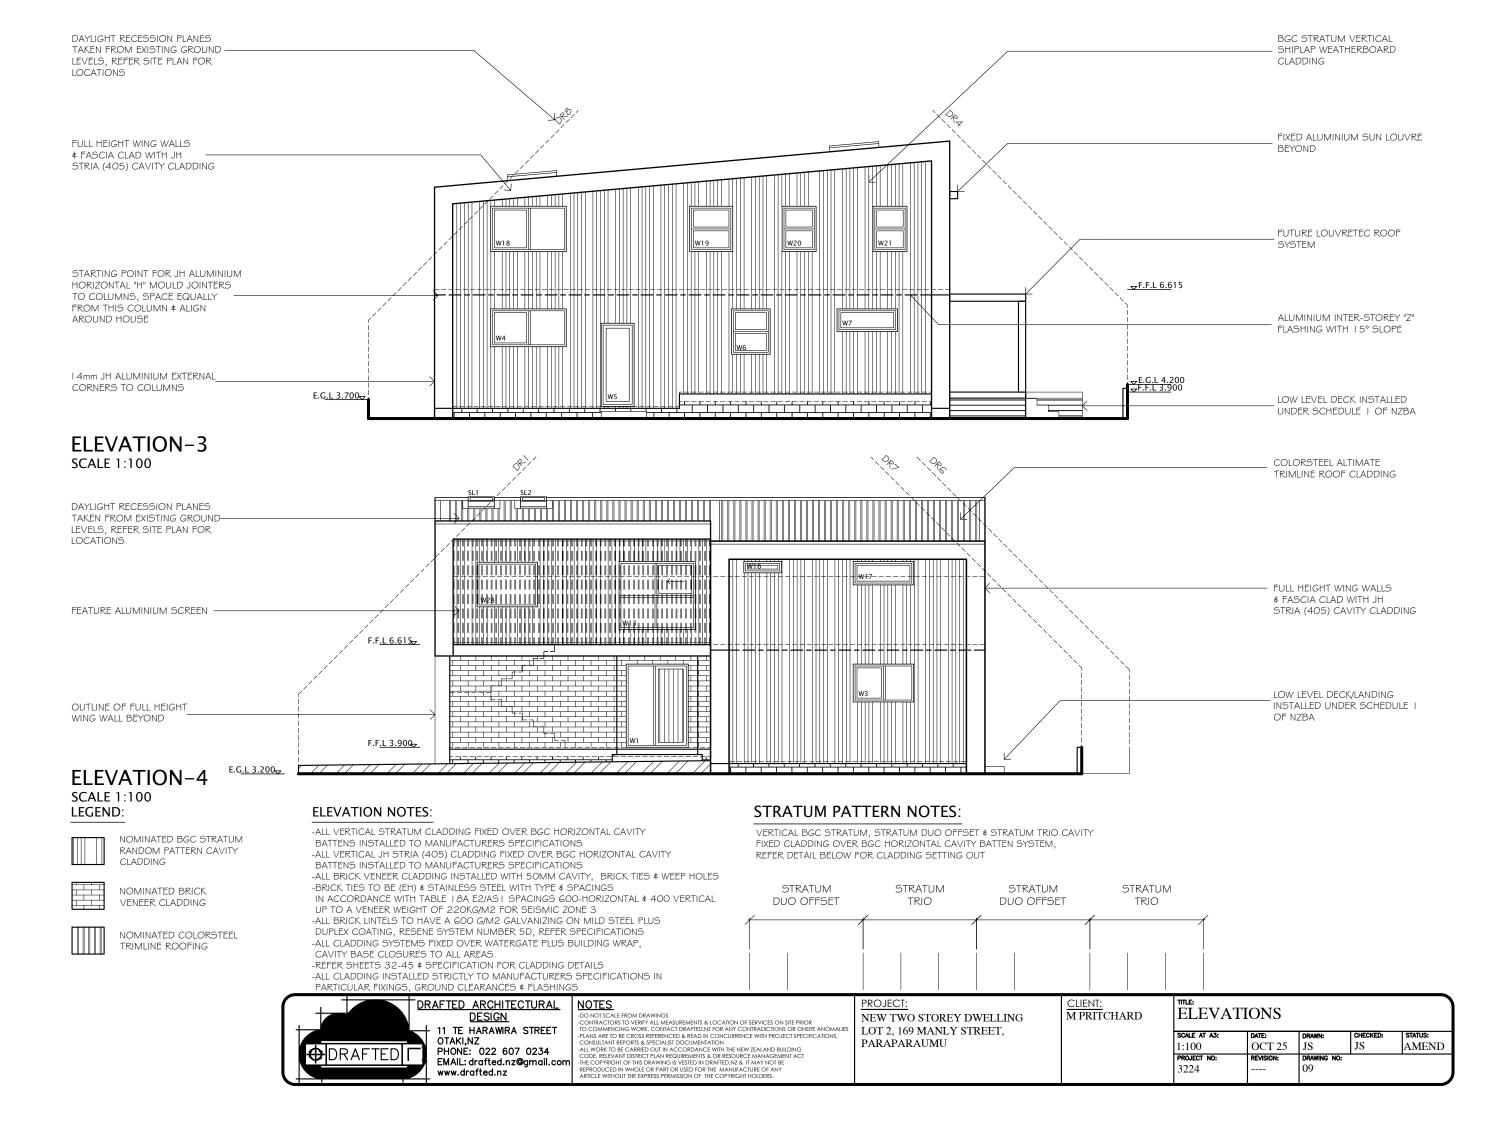

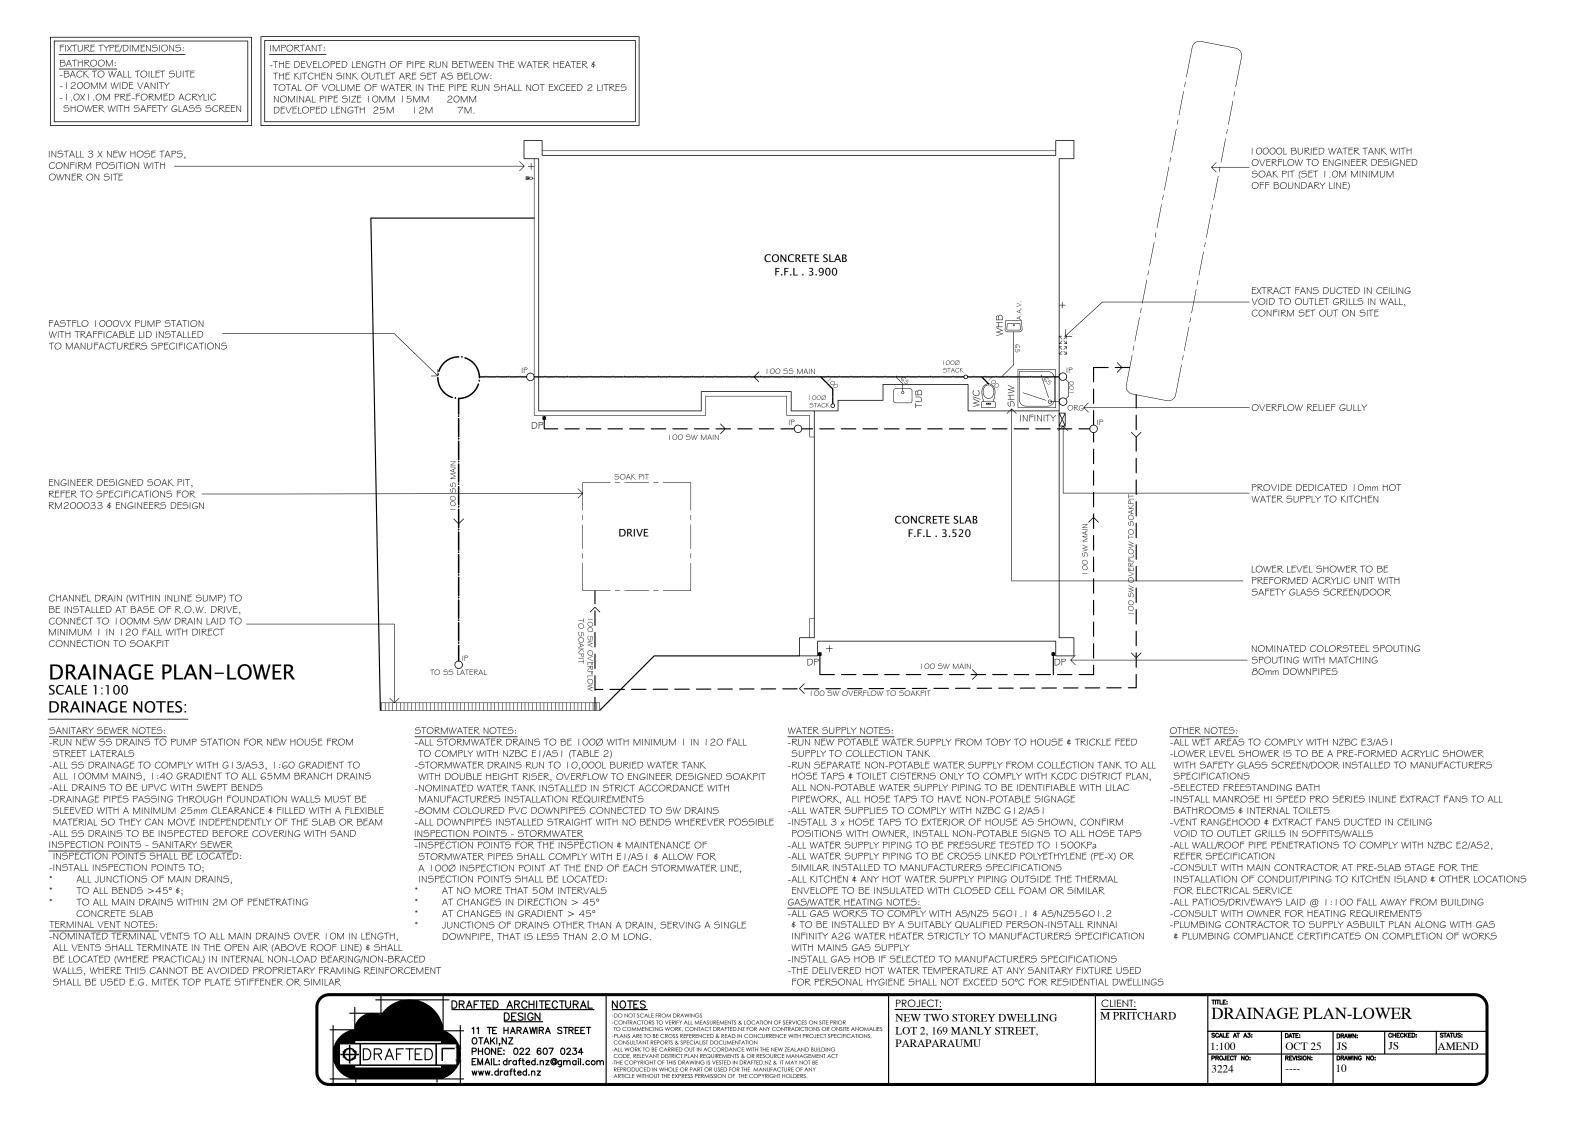

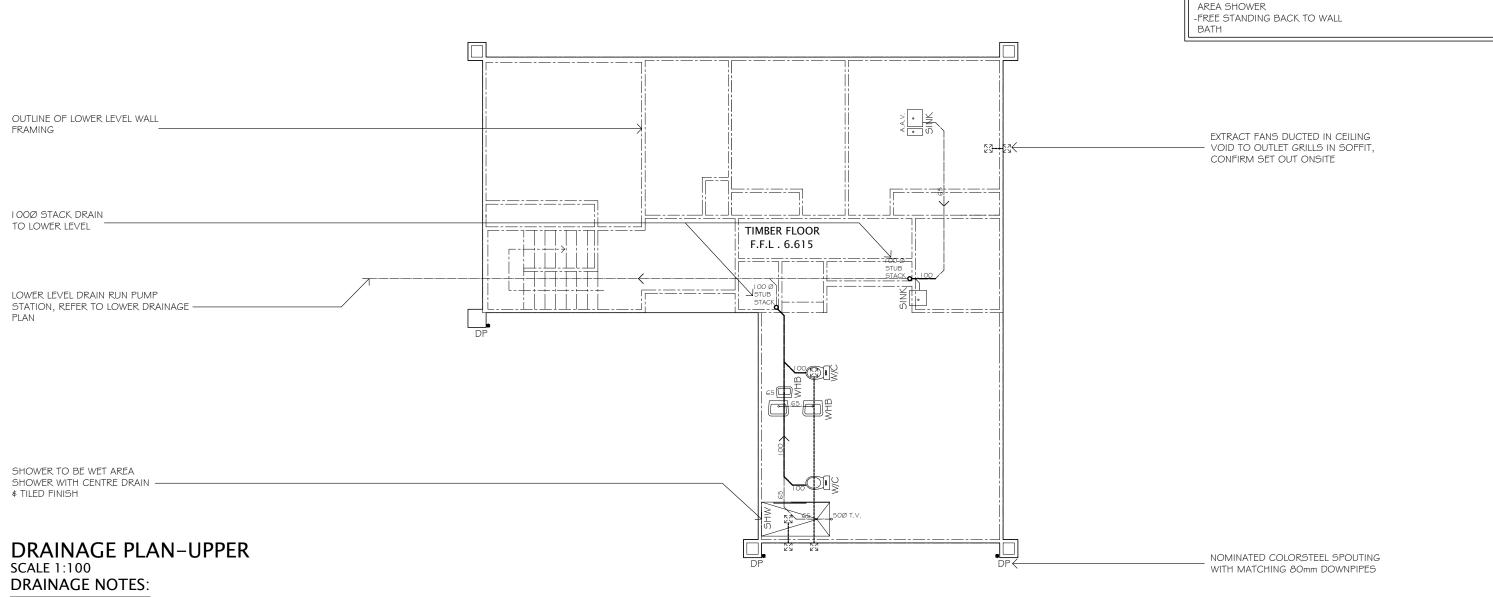

SANITARY SEWER NOTES:

-RUN NEW SS DRAINS TO PUMP STATION FOR NEW HOUSE FROM STRFFT LATERALS

-ALL SS DRAINAGE TO COMPLY WITH G13/AS3, 1:60 GRADIENT TO ALL IOOMM MAINS, I:40 GRADIENT TO ALL 65MM BRANCH DRAINS -ALL DRAINS TO BE UPVC WITH SWEPT BENDS

-DRAINAGE PIPES PASSING THROUGH FOUNDATION WALLS MUST BE SLEEVED WITH A MINIMUM 25mm CLEARANCE & FILLED WITH A FLEXIBLE MATERIAL SO THEY CAN MOVE INDEPENDENTLY OF THE SLAB OR BEAM -ALL SS DRAINS TO BE INSPECTED BEFORE COVERING WITH SAND INSPECTION POINTS - SANITARY SEWER

INSPECTION POINTS SHALL BE LOCATED

- -INSTALL INSPECTION POINTS TO; ALL JUNCTIONS OF MAIN DRAINS.
- TO ALL BENDS >45° ¢;
- TO ALL MAIN DRAINS WITHIN 2M OF PENETRATING CONCRETE SLAB

TERMINAL VENT NOTES:

-NOMINATED TERMINAL VENTS TO ALL MAIN DRAINS OVER LOM IN LENGTH. ALL VENTS SHALL TERMINATE IN THE OPEN AIR (ABOVE ROOF LINE) \$ SHALL BE LOCATED (WHERE PRACTICAL) IN INTERNAL NON-LOAD BEARING/NON-BRACED WALLS, WHERE THIS CANNOT BE AVOIDED PROPRIETARY FRAMING REINFORCEMENT SHALL BE USED E.G. MITEK TOP PLATE STIFFENER OR SIMILAR

STORMWATER NOTES

-ALL STORMWATER DRAINS TO BE 1000 WITH MINIMUM 1 IN 120 FALL TO COMPLY WITH NZBC E1/AS1 (TABLE 2)

-STORMWATER DRAINS RUN TO 10,000L BURIED WATER TANK WITH DOUBLE HEIGHT RISER, OVERFLOW TO ENGINEER DESIGNED SOAKPIT -NOMINATED WATER TANK INSTALLED IN STRICT ACCORDANCE WITH MANUFACTURERS INSTALLATION REQUIREMENTS

-80MM COLOURED PVC DOWNPIPES CONNECTED TO SW DRAINS -ALL DOWNPIPES INSTALLED STRAIGHT WITH NO BENDS WHEREVER POSSIBLE INSPECTION POINTS - STORMWATER

-INSPECTION POINTS FOR THE INSPECTION \$ MAINTENANCE OF STORMWATER PIPES SHALL COMPLY WITH EI/ASI & ALLOW FOR A 1000 INSPECTION POINT AT THE END OF EACH STORMWATER LINE, INSPECTION POINTS SHALL BE LOCATED:

- AT NO MORE THAT 50M INTERVALS
- AT CHANGES IN DIRECTION > 45°
- AT CHANGES IN GRADIENT > 45°
- JUNCTIONS OF DRAINS OTHER THAN A DRAIN, SERVING A SINGLE DOWNPIPE, THAT IS LESS THAN 2.0 M LONG.

WATER SUPPLY NOTES

-RUN NEW POTABLE WATER SUPPLY FROM TOBY TO HOUSE \$ TRICKLE FEED SUPPLY TO COLLECTION TANK

-RUN SEPARATE NON-POTABLE WATER SUPPLY FROM COLLECTION TANK TO ALL HOSE TAPS & TOILET CISTERNS ONLY TO COMPLY WITH KCDC DISTRICT PLAN, ALL NON-POTABLE WATER SUPPLY PIPING TO BE IDENTIFIABLE WITH LILAC PIPEWORK, ALL HOSE TAPS TO HAVE NON-POTABLE SIGNAGE

-ALL WATER SUPPLIES TO COMPLY WITH NZBC G I 2/AS I

-INSTALL 3 x HOSE TAPS TO EXTERIOR OF HOUSE AS SHOWN, CONFIRM POSITIONS WITH OWNER, INSTALL NON-POTABLE SIGNS TO ALL HOSE TAPS

-ALL WATER SUPPLY PIPING TO BE PRESSURE TESTED TO 1500KPa -ALL WATER SUPPLY PIPING TO BE CROSS LINKED POLYETHYLENE (PE-X) OR SIMILAR INSTALLED TO MANUFACTURERS SPECIFICATIONS

-ALL KITCHEN & ANY HOT WATER SUPPLY PIPING OUTSIDE THE THERMAL ENVELOPE TO BE INSULATED WITH CLOSED CELL FOAM OR SIMILAR GAS/WATER HEATING NOTES:

-ALL GAS WORKS TO COMPLY WITH AS/NZS 5601.1 \$ AS/NZS5601.2 \$ TO BE INSTALLED BY A SUITABLY QUALIFIED PERSON-INSTALL RINNAI INFINITY A26 WATER HEATER STRICTLY TO MANUFACTURERS SPECIFICATION WITH MAINS GAS SUPPLY

-INSTALL GAS HOB IF SELECTED TO MANUFACTURERS SPECIFICATIONS -THE DELIVERED HOT WATER TEMPERATURE AT ANY SANITARY FIXTURE USED FOR PERSONAL HYGIENE SHALL NOT EXCEED 50°C FOR RESIDENTIAL DWELLINGS

OTHER NOTES

FIXTURE TYPE/DIMENSIONS:

-900x I 800mm TILED WET

-BACK TO WALL TOILET SUITE

- I 500MM WIDE DOUBLE VANITY -W/C VANITY

-BACK TO WALL TOILET SUITE

ENSUITE

-ALL WET AREAS TO COMPLY WITH NZBC E3/AS I -UPPER LEVEL SHOWER IS TO BE A TILED WET AREA SHOWER WITH CENTRE DRAIN OVER ARDEX SUPERFLEX WATERPROOFING MEMBRANE, SHOWER SET TO 1:50 FALL TO DRAIN, REFER DETAILS

-SELECTED FREESTANDING BATH

-INSTALL MANROSE HI SPEED PRO SERIES INLINE EXTRACT FANS TO ALL BATHROOMS & INTERNAL TOILETS

-VENT RANGEHOOD \$ EXTRACT FANS DUCTED IN CEILING VOID TO OUTLET GRILLS IN SOFFITS/WALLS


-ALL WALL/ROOF PIPE PENETRATIONS TO COMPLY WITH NZBC E2/AS2, REFER SPECIFICATION


-CONSULT WITH MAIN CONTRACTOR AT PRE-SLAB STAGE FOR THE INSTALLATION OF CONDUIT/PIPING TO KITCHEN ISLAND \$ OTHER LOCATIONS FOR ELECTRICAL SERVICE

-ALL PATIOS/DRIVEWAYS LAID @ 1:100 FALL AWAY FROM BUILDING


-CONSULT WITH OWNER FOR HEATING REQUIREMENTS -PLUMBING CONTRACTOR TO SUPPLY ASBUILT PLAN ALONG WITH GAS


PLUMBING COMPLIANCE CERTIFICATES ON COMPLETION OF WORKS

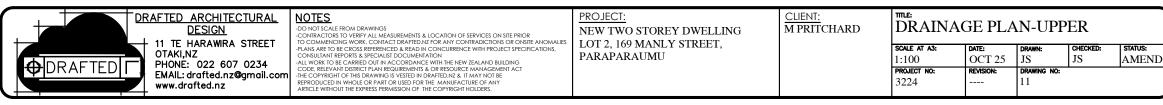


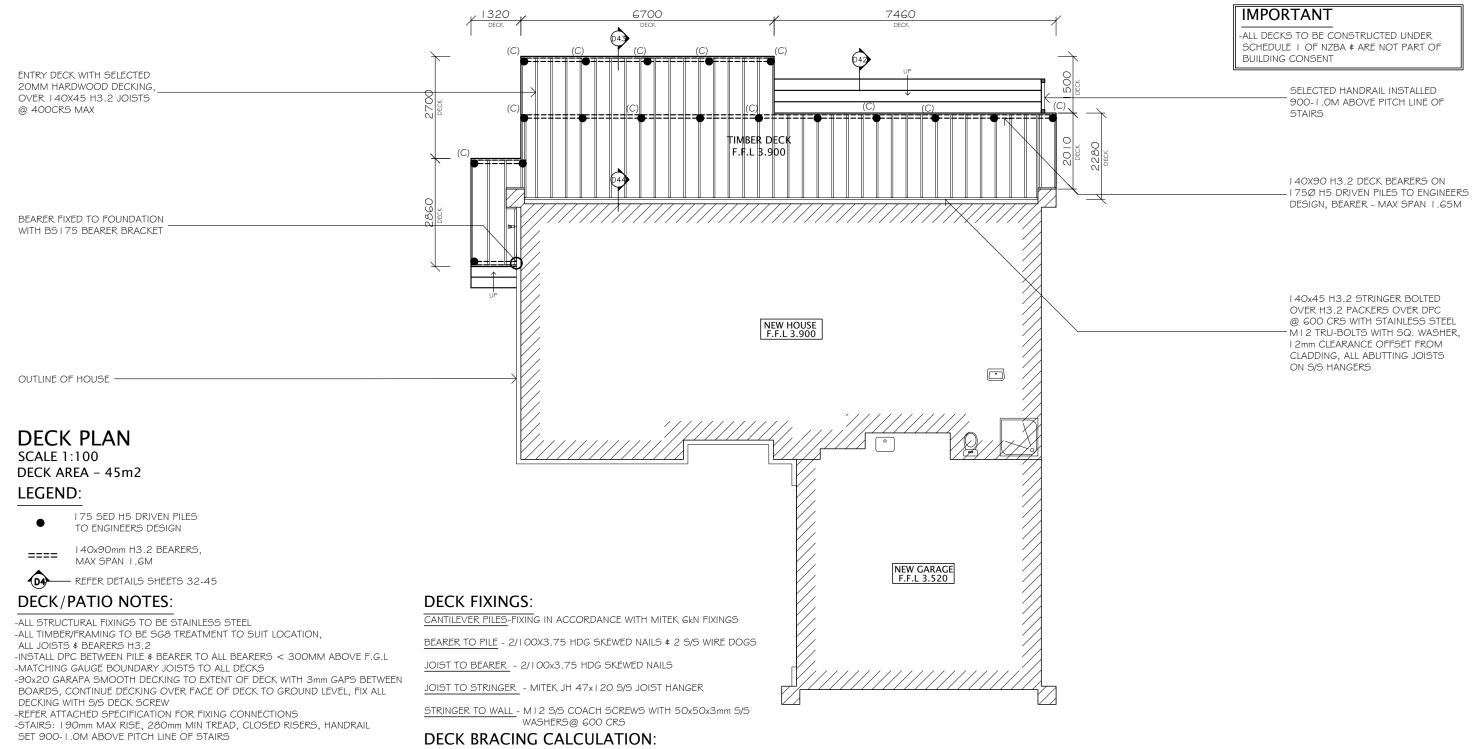


-LOWER DECK (45m2) - 45m2 x 7.5 B/U's = 337 B/U's REQUIRED 12 x CANTILEVER PILES x 30 B/U's = 360 B/U's - COMPLIES

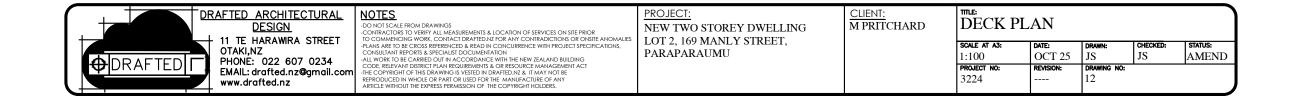

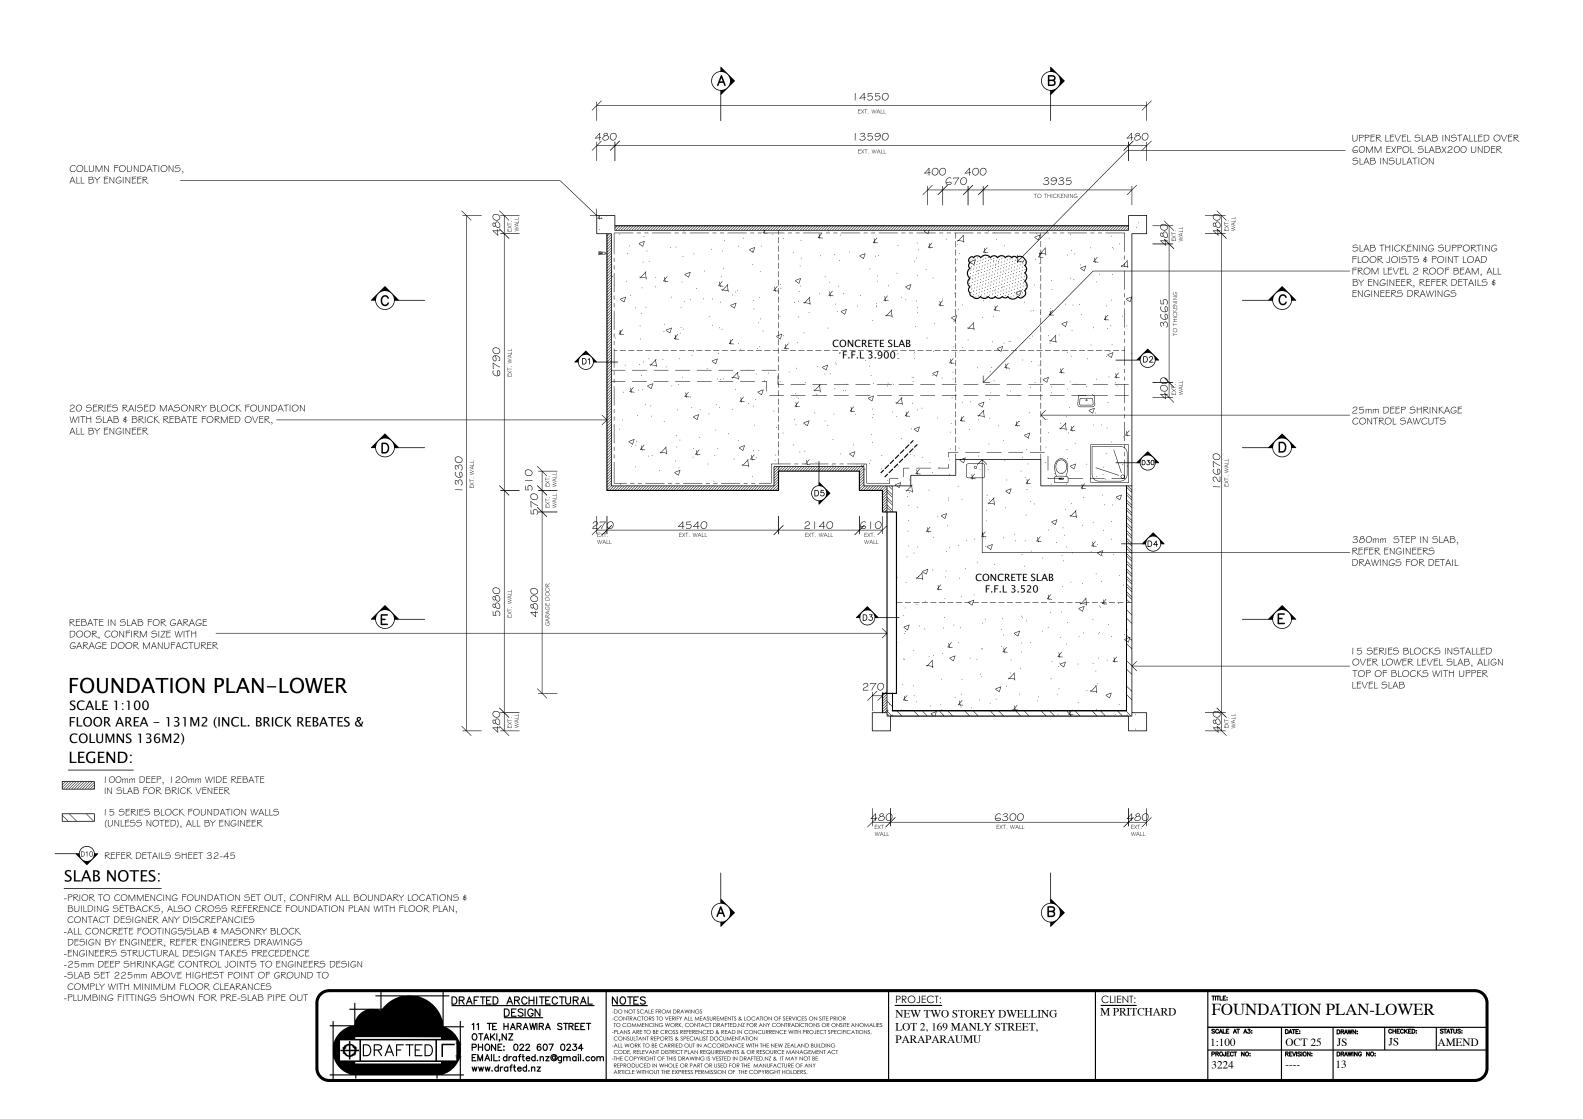

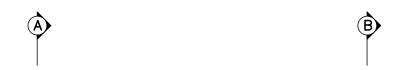

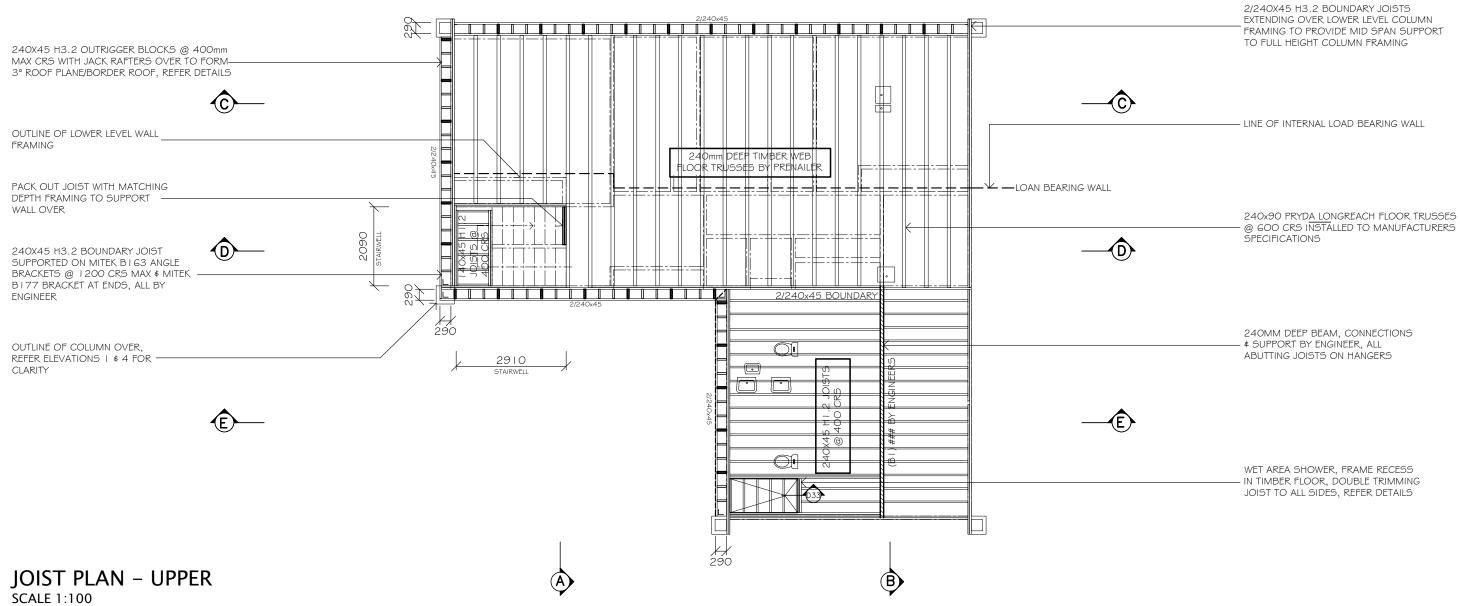

TOTAL FLOOR AREA - 133M2 LEGEND:







- MITEK B I 63 ANGLE BRACKETS
- MITEK B I 77 BRACKET


NOTES:


- -20mm H3.2 PLYWOOD FLOORING TO ENSUITE \$ W/C \$ ALFRESCO ONLY, ALL OTHER AREAS TO BE 20mm STRANDBOARD FLOORING, ALL SCREWED
- **& GLUED TO MANUFACTURERS SPECIFICATIONS**
- -ALL BOUNDARY JOISTS & OUTRIGGER FLOOR BLOCKS TO BE H3.2, ALL
- OTHER FLOOR FRAMING TO BE A MINIMUM OF HILZ
 -INSTALL CONTINUOUS FULL DEPTH BLOCKING @ MIDSPAN OF ALL JOIST
- SPANS > 2.5m TO NZS3604
- -SOLID BLOCKING @ 1800 CRS MAXIMUM
- -MATCHING GAUGE BOUNDARY JOISTS TO ALL AREAS
- -PLUMBING FITTINGS SHOWN FOR PIPE SETOUT


DESIGN	NOTES -DO NOT SCALE FROM DRAWINGS -CONTRACTORS TO VERIFY ALL MEASUREMENTS & LOCATION OF SERVICES ON SITE PRIOR TO COMMENCING WORK, CONTACT DRAFTED.NZ FOR ANY CONTRADICTIONS OR ONSITE ANOMALIES	PROJECT: NEW TWO STOREY DWELLING	CLIENT: M PRITCHARD	FOUND	ATION I	PLAN-	UPPER	
OTAKI,NZ	-PLANS ARE TO BE CROSS REFERENCED & READ IN CONCURRENCE WITH PROJECT SPECIFICATIONS, CONSULTANT REPORTS & SPECIALIST DOCUMENTATION -ALL WORK TO BE CARRIED OUT IN ACCORDANCE WITH THE NEW ZEALAND BUILDING	LOT 2, 169 MANLY STREET, PARAPARAUMU		SCALE AT A3: 1:100	OCT 25	JS	JS	STATUS: AMEND
EMAIL: drafted.nz@gmail.com	CODE, RELEVANT DISTRICT PLAN REQUIREMENTS & OR RESOURCE MANAGEMENT ACT - 1 THE COPYRIGHT OF THIS DRAWING IS VESTED IN DRAFTED N.Z. & IT MAY NOT BE REPRODUCED IN WHOLE OR PART OR USED FOR THE MANUFACTURE OF ANY ARTICLE WITHOUT THE EXPRESS PERMISSION OF THE COPYRIGHT HOLDERS.			PROJECT NO: 3224	REVISION:	DRAWING NO:		

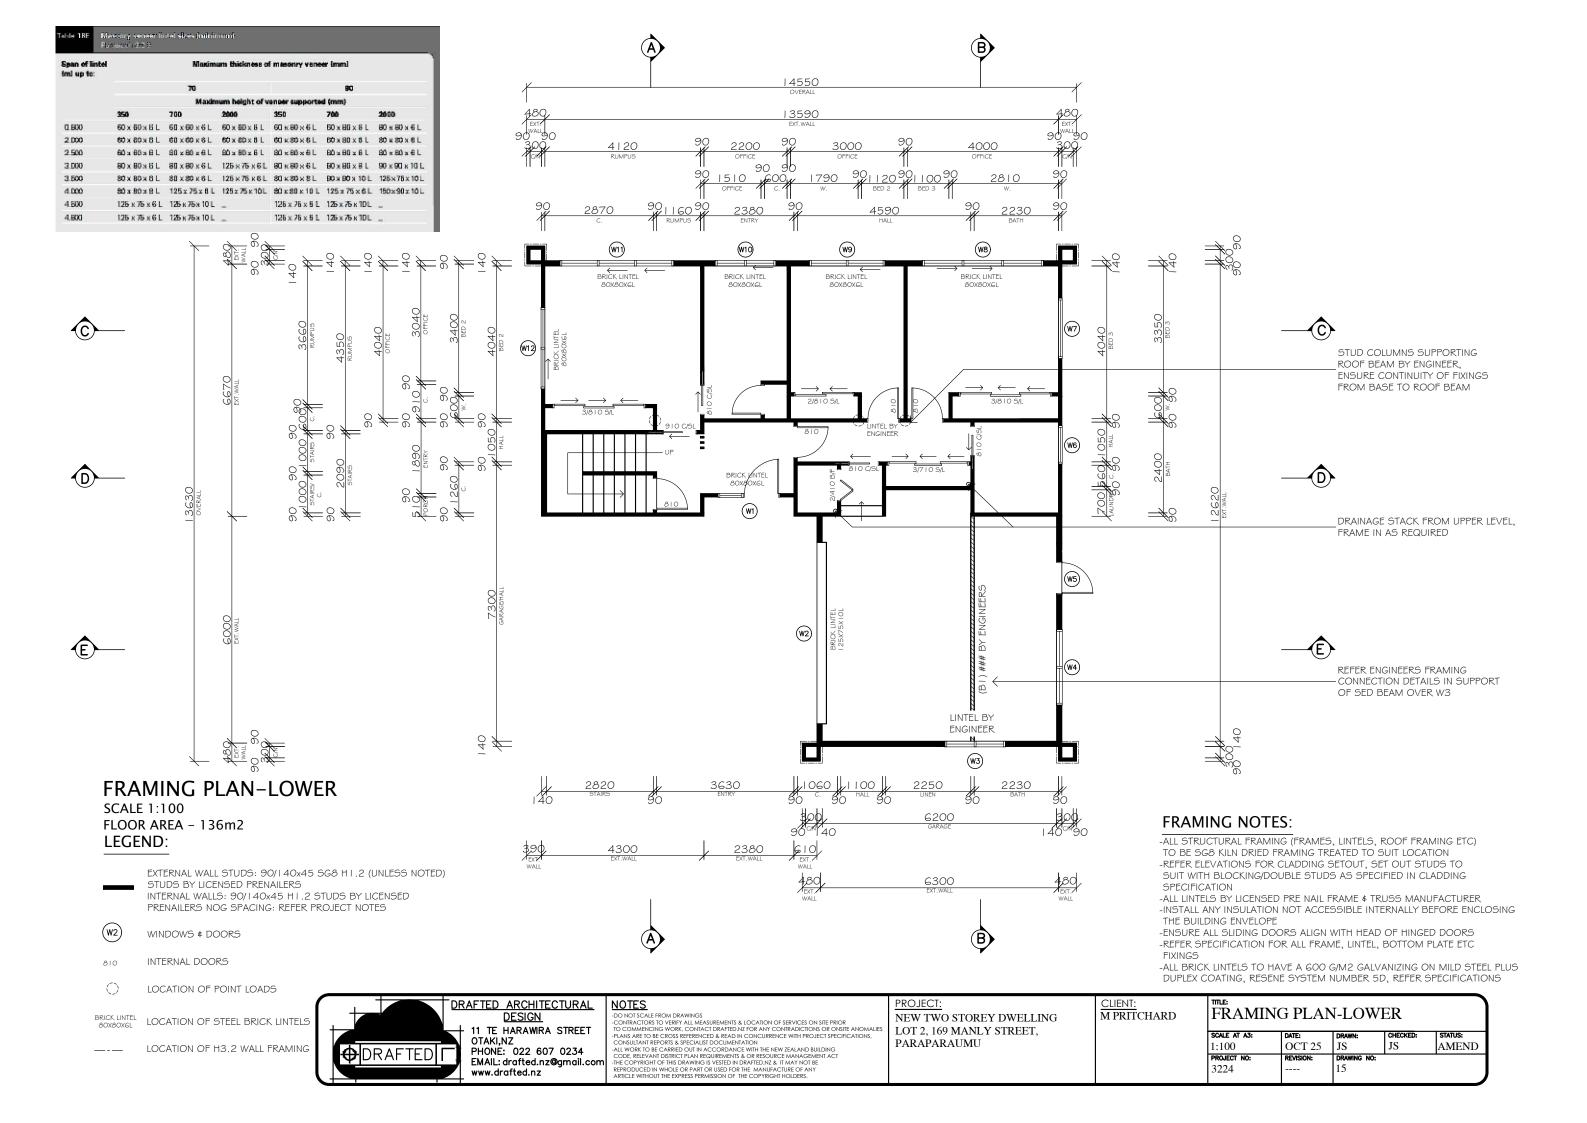


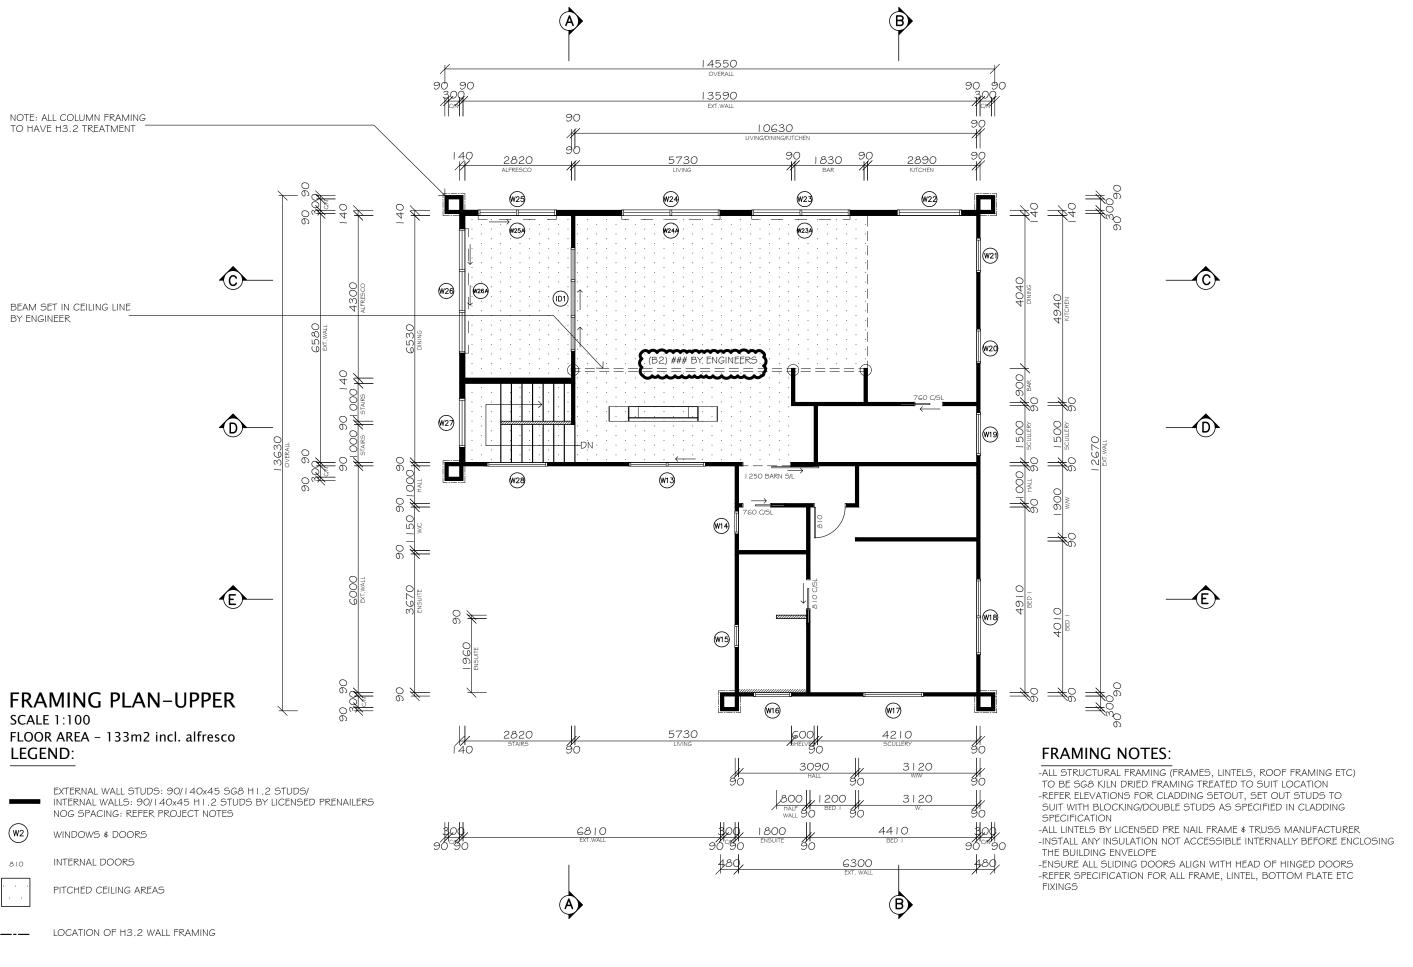

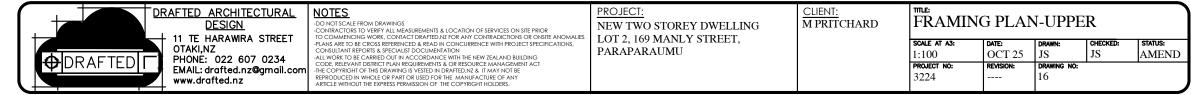

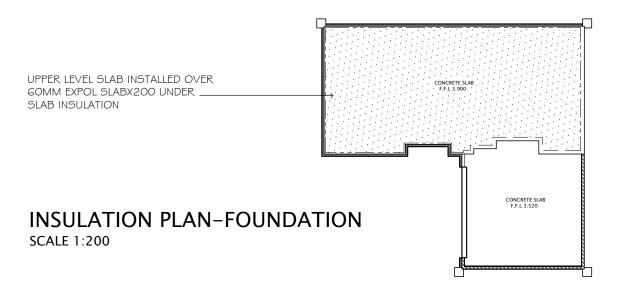

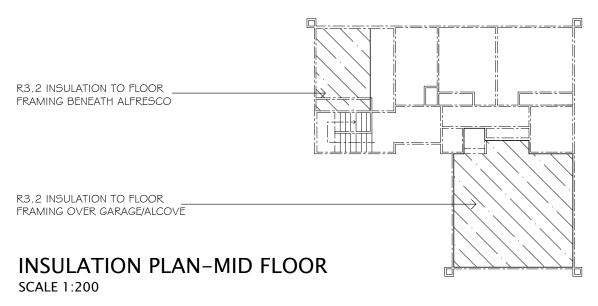

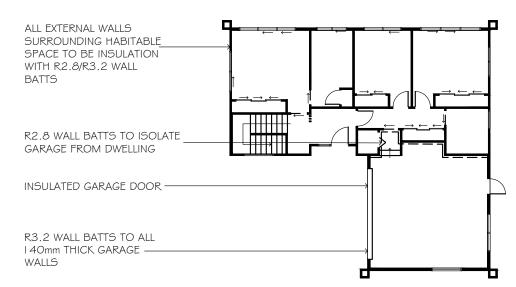



INSULATION PLAN-LOWER

SCALE 1:200

INSULATION NOTES:

-R2.8 WALL BATTS TO 90MM THICK FRAMING -R3.2 WALL BATTS TO 140MM THICK FRAMING

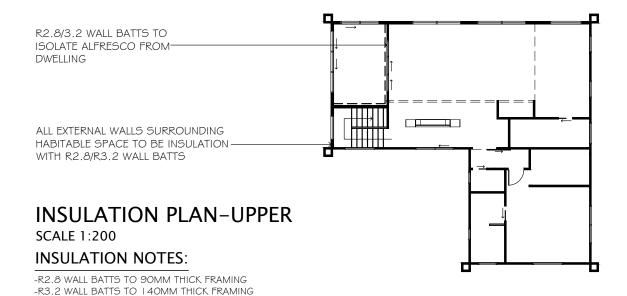

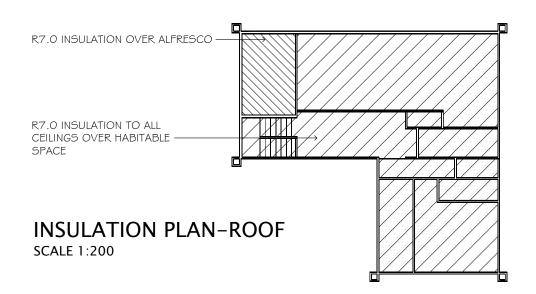




NOTES

NOTES

- DO NOT SCALE FROM DRAWINGS
- CONTRACTORS TO VERIFY ALL MEASUREMENTS & LOCATION OF SERVICES ON SITE PRIOR
- CONTRACTORS TO VERIFY ALL MEASUREMENTS & LOCATION OF SERVICES ON SITE PRIOR
- TO COMMENTION WORK. CONTACT DRAFTED MY FOR ANY CONTRADICTIONS OR ONSITE ANOMALIES
- PLANS ARE TO BE CROSS REFERENCED & READ IN CONCURRENCE WITH PROJECT SPECIFICATIONS,
- CONSULTANT REPORTS & SPECIALIST DOCUMENTATION
- ALL WORK TO BE CARRIED OUT IN ACCORDANCE WITH THE NEW ZEALAND BUILDING
- CODE. RELEVANT DISTRICT PLAN REQUIREMENTS & OR RESOURCE MANAGEMENT ACT
- THE COPYRIGHT OF HIS DRAWING IS VESTED IN DRAFTED MY. & IT MAY NOT BE
- REPRODUCED IN WHOLE OR PAST OR USED FOR THE MANUFACTURE OF ANY
- ARTICLE WITHOUT THE EXPRESS PERMISSION OF THE COPYRIGHT HOLDERS.

LO PA

CLIENT: M PRITCHARD	INSULAT	ION PI	LAN/S		
	SCALE AT A3:	DATE:	DRAWN:	CHECKED:	STATUS:
	1:200	OCT 25	JS	JS	AMEND
	PROJECT NO:	REVISION:	DRAWING NO:		
	3224		17		
	M PRITCHARD	M PRITCHARD INSULAT SCALE AT A3: 1:200 PROJECT NO:	M PRITCHARD INSULATION PI SCALE AT A3: DATE: 1:200 OCT 25 PROJECT NO: REVISION:	M PRITCHARD INSULATION PLAN/S SCALE AT A3: DATE: DRAWN: 1:200 OCT 25 JS PROJECT NO: REVISION: DRAWING NO:	M PRITCHARD INSULATION PLAN/S SCALE AT A3: DATE: DRAWN: CHECKED: 1:200 OCT 25 JS JS PROJECT NO: REVISION: DRAWING NO:

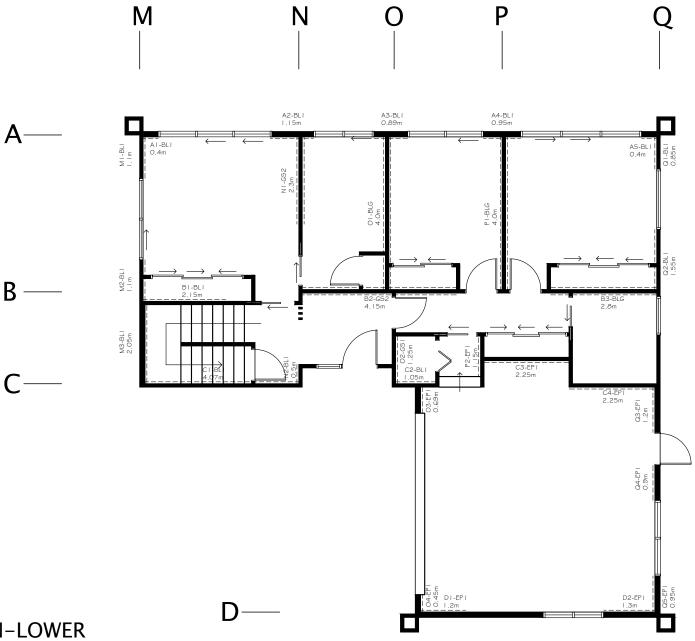


BRACING PLAN-LOWER SCALE 1:100

BRACING NOTES:

-ALL BRACING DESIGN FOR VERY HIGH WIND ZONE
-ALL BRACES FIXED TO MANUFACTURERS SPECIFICATIONS
-BRACING ADDITIONAL TO THAT CALCULATED ARE DENOTED "ADD"


DESIGN	NOTES -DO NOT SCALE FROM DRAWINGS -CONTRACTORS TO VERIFY ALL MEASUREMENTS & LOCATION OF SERVICES ON SITE PRIOR TO COMMENCING WORK, CONTACT DRAFTED AT FOR ANY CONTRADICTIONS OR ONSITE ANOMALIES	PROJECT: NEW TWO STOREY DWELLING	CLIENT: M PRITCHARD	BRACING	3 PLAN	V-LOW	ER	
OTAKI,NZ	-PLANS ARE 10 BE CRUSS REPERENCED & READ IN CONCURRENCE WITH PROJECT SPECIFICATIONS, CONSULTANT REPORTS & SPECIALIST DOCUMENTATION -ALL WORK TO BE CARRIED OUT IN ACCORDANCE WITH THE NEW ZEALAND BUILDING	LOT 2, 169 MANLY STREET, PARAPARAUMU		SCALE AT A3: 1:100	DATE: OCT 25	JS	JS	STATUS: AMEND
EMAIL: drafted nz	CODE, RELEVANT DISTRICT PLAN REQUIREMENTS & OR RESOURCE MANAGEMENT ACT -THE COPYRIGHT OF THIS DRAWING IS VESTED IN DRAFTED.NZ &. IT MAY NOT BE REPRODUCED IN WHOLE OR PART OR USED FOR THE MANUFACTURE OF ANY ARTICLE WITHOUT THE EXPRESS PERMISSION OF THE COPYRIGHT HOLDERS.			PROJECT NO: 3224	REVISION:	DRAWING NO:		

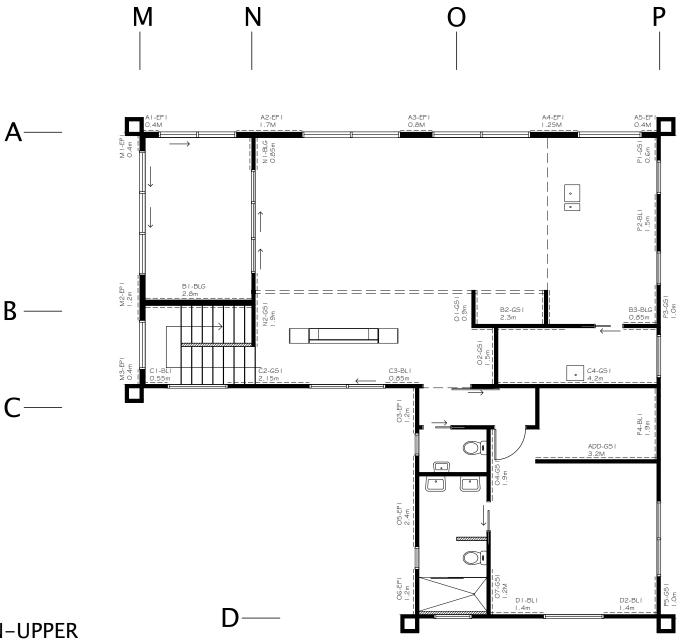



BRACING PLAN-UPPER SCALE 1:100

BRACING NOTES:


-ALL BRACING DESIGN FOR VERY HIGH WIND ZONE
-ALL BRACES FIXED TO MANUFACTURERS SPECIFICATIONS
-BRACING ADDITIONAL TO THAT CALCULATED ARE DENOTED "ADD"

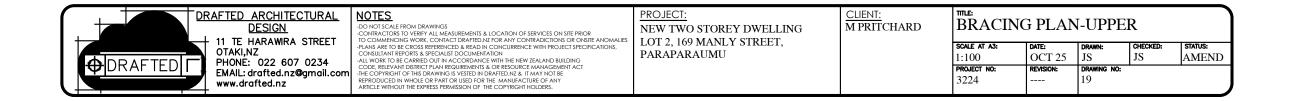


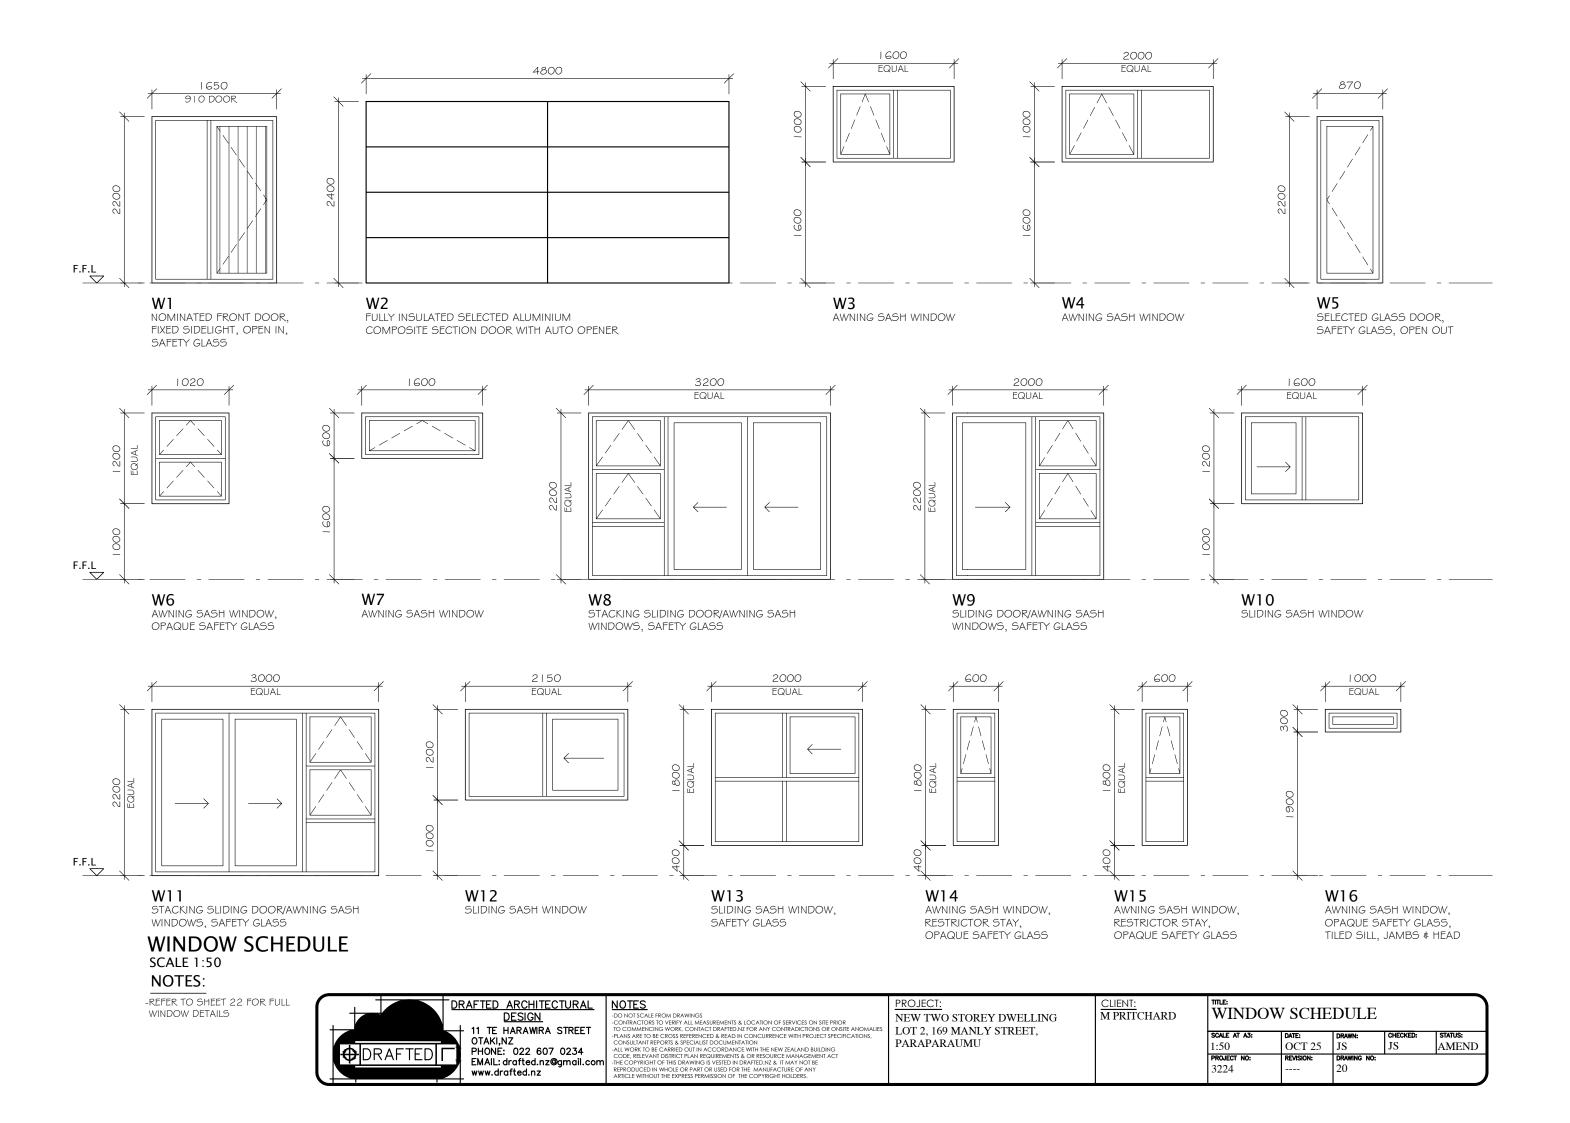

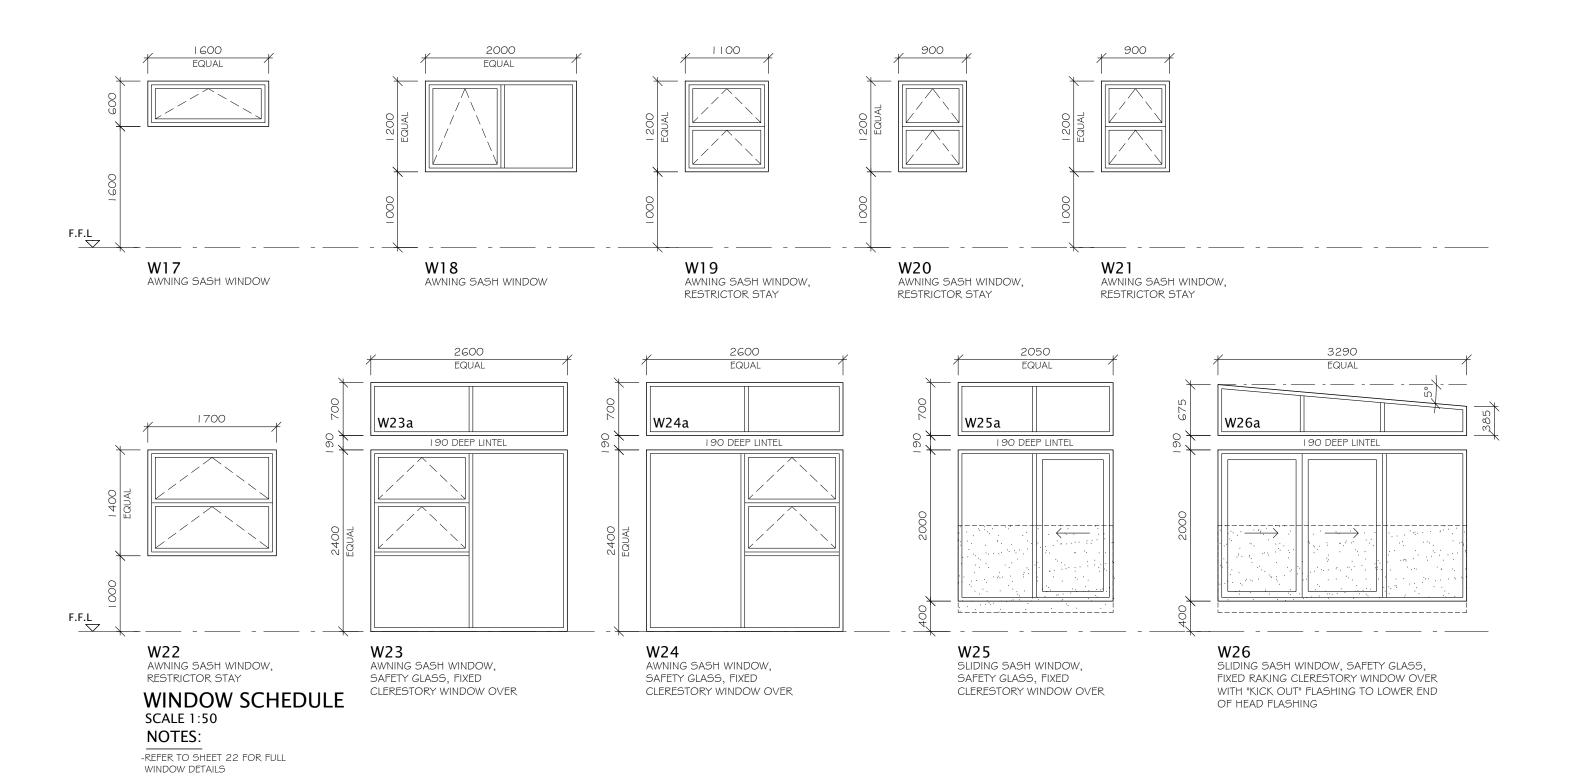



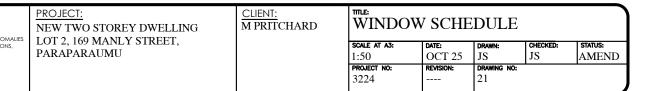

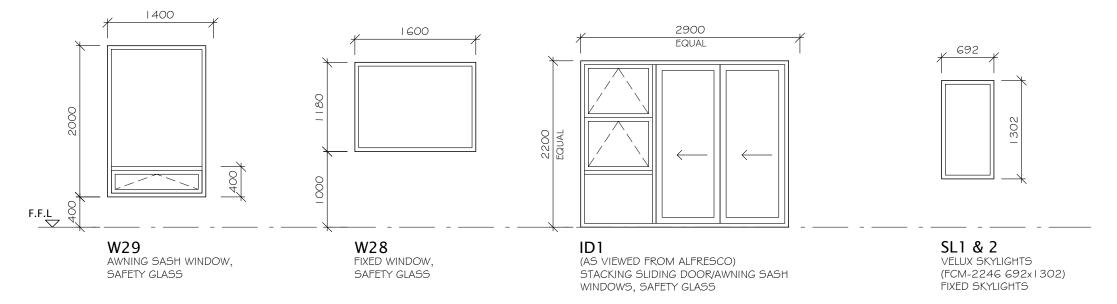

WINDOW SCHEDULE

SCALE 1:50

WINDOW NOTES:

-WINDOWS SHOWN AS VIEWED FROM OUTSIDE, REFER FRAMING PLAN & ELEVATIONS

-ALL UNITS POWDERCOAT FINISH, CONFIRM COLOUR WITH OWNER

-ALL UNITS WITH COLOUR MATCHED HARDWARE, LARGE URBO D HANDLES TO ALL SLIDERS, ALL DOOR HANDLES INSTALLED TO MATCH TO CENTRELINE

ABOVE F.F.L, ALL SASHES WITH DOUBLE TONGUE VENTED LATCHES (WHERE POSSIBLE)
-ALUMINIUM JOINER TO CHECK ALL OPENINGS SIZES \$ WINDOW CONFIGURATION
ON SITE BEFORE MANUFACTURE

-ALL JOINERY TO COMPLY WITH NZS 42 I I -ALL UNITS DOUBLE GLAZED FOR VERY HIGH WIND ZONE, I 550PA DWP, SAFETY GLASS AS REQUIRED/NOMINATED, ALL GLAZING TO NZS4223

-ALL WINDOWS WITH MATCHING POWDERCOATED HEAD FLASHINGS \$ WRAP ALL OPENINGS WITH ALUBAND TAPE TO NZBC E2, REFER CLADDING SPECIFICATION \$ DETAILS FOR WEATHERPROOFING DETAILS

-INSTALL STOP ENDS TO ANY HEAD FLASHINGS \$ DIVERTERS TO ALL RAKING WINDOW **HFADS**

-ALL CAVITY FIXED WINDOWS/DOORS TO HAVE WANZ SILL SUPPORT BRACKETS -20mm H3.1 PRE-PRIMED PINE REVEALS WITH ARCHITRAVE FINISH -NOMINATED BRICK VENEER & BGC VERTICAL STRATUM WEATHERBOARD CLADDING, REFER ELEVATIONS FOR LOCATION

IMPORTANT:

-ALUMINIUM JOINER TO CHECK ALL OPENINGS SIZES & WINDOW CONFIGURATION ON-SITE BEFORE MANUFACTURE



www.drafted.nz


NOTES

NOTES

- DO NOT SCALE FROM DRAWINGS
- CONTRACTORS TO VERIFY ALL MEASUREMENTS & LOCATION OF SERVICES ON SITE PRIOR
- CONTRACTORS TO VERIFY ALL MEASUREMENTS & LOCATION OF SERVICES ON SITE PRIOR
- COMMENCING WORK, CONTACT DRAFTED NZ FOR ANY CONTRADICTIONS OR ONSITE ANOMALI
- PLANS ARE TO BE CROSS REFERENCED & READ IN CONCURRENCE WITH PROJECT SPECIFICATIONS,
- CONSULTANT REPORTS & SPECIALIST DOCUMENTATION
- ALL WORK TO BE CARRIED OUT IN ACCORDANCE WITH THE NEW ZEALAND BUILDING
- CODE, RELEVANT DISTRICT PLAN REQUIREMENTS & OR RESOURCE MANAGEMENT ACT
- THE COPYRIGHT OF THIS DRAWING IS VESTED IN DRAFTED NZ & IT MAY NOT BE
- REPRODUCED IN WHOLE OR PART OR USED FOR THE MANUFACTURE OF ANY
- ARTICLE WITHOUT THE EXPRESS PERMISSION OF THE COPYRIGHT HOLDERS.

PROJECT: NEW TWO STOREY DWELLING LOT 2, 169 MANLY STREET, PARAPARAUMU

CLIENT: M PRITCHARD	WINDOW SCHEDULE				
	SCALE AT A3:	DATE:	DRAWN:	CHECKED:	STATUS:
	1:50	OCT 25	JS	JS	AMEND
	PROJECT NO:	REVISION:	DRAWING NO:		
	3224		22		

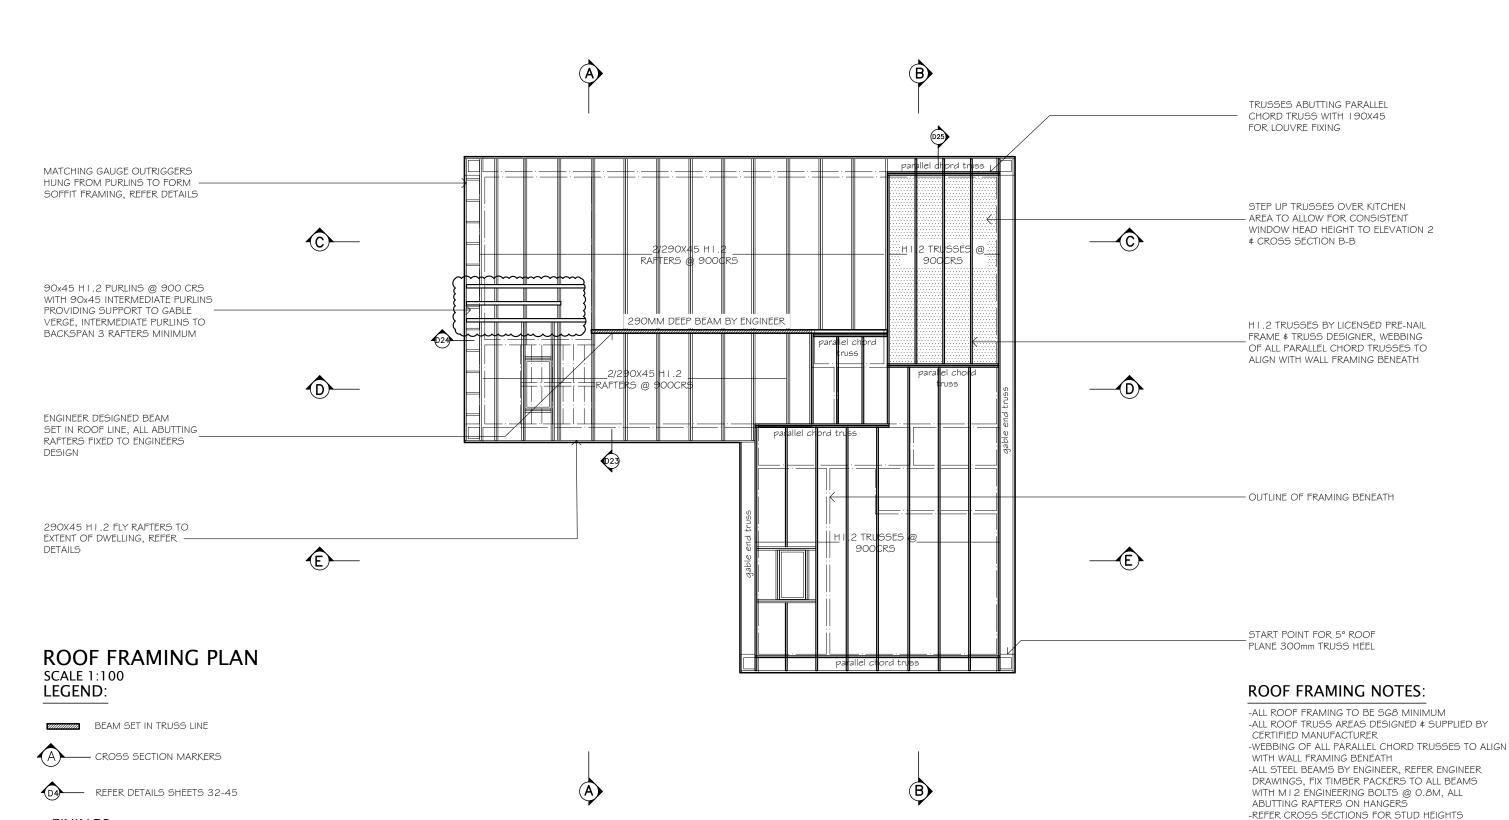

FIXINGS:

LIVING, DINING, KITCHEN RAFTERS/OUTRIGGER TO TOP PLATE -2/90X3. I 5MM SKEWED NAILS + 2/STRAP FIXINGS LIVING, DINING, KITCHEN RAFTERS/OUTRIGGER TO BEAM -2/90X3. I 5MM SKEWED NAILS + 2/STRAP FIXINGS TRUSSES TO TOP PLATE -BY TRUSS MANUFACTURER

> DRAFTED ARCHITECTURAL <u>DESIGN</u> 11 TE HARAWIRA STREET PHONE: 022 607 0234 **⊕**|drafted|**┌** EMAIL: drafted.nz@gmail.com www.drafted.nz

NOTES


NOTES

- DO NOT SCALE FROM DRAWINGS
- CONTRACTORS TO VERIFY ALL MEASUREMENTS & LOCATION OF SERVICES ON SITE PRIOR
- COMMENCING WORK, CONTACT DRAFTED NZ FOR ANY CONTRADICTIONS OR ONSITE ANOMALIE:
- PLANS ARE TO BE CROSS REFERENCED & READ IN CONCURRENCE WITH PROJECT SPECIFICATIONS,
- CONSULTANT REPORTS & SPECIALIST DOCUMENTATION
- ALL WORK TO BE CARRIED OUT IN ACCORDANCE WITH 1HE NEW ZEALAND BUILDING
- CODE, RELEVANT DISTRICT PLAN REQUIREMENTS & OR RESOURCE MANAGEMENT ACT
- THE COPYRIGHT OF THIS DRAWING IS VESTED IN DRAFTED NZ & IT MAY NOT BE
- REPRODUCED IN WHOLE OR PART OR USED FOR THE MANUFACTURE OF ANY
- ARTICLE WITHOUT THE EXPRESS PERMISSION OF THE COPYRIGHT HOLDERS.

PROJECT: NEW TWO STOREY DWELLING LOT 2, 169 MANLY STREET, PARAPARAUMU

CLIENT:	
M PRITCHARD	

ROOF FRAMING PLAN SCALE AT A3: STATUS: OCT 25 AMEND 1:100 JS PROJECT NO: REVISION: 3224

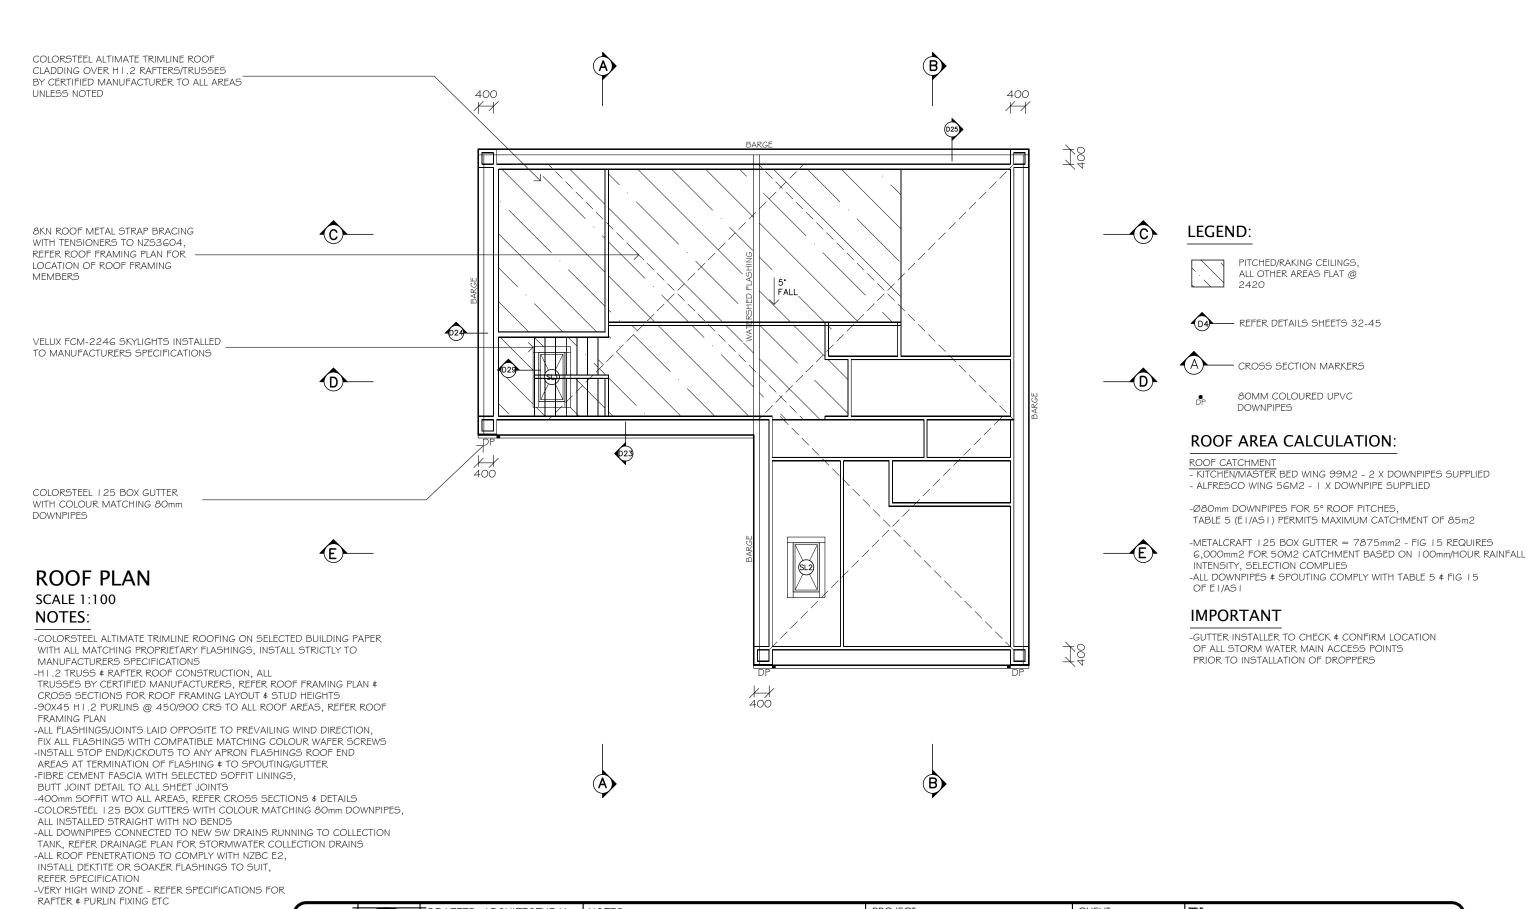

PROJECT: DRAFTED ARCHITECTURAL **NOTES** NOTES

- DO NOT SCALE FROM DRAWINGS

- CONTRACTORS TO VERIFY ALL MEASUREMENTS & LOCATION OF SERVICES ON SITE PRIOR

- CONTRACTORS TO VERIFY ALL MEASUREMENTS & LOCATION OF SERVICES ON SITE PRIOR

- TO COMMENDING WORK, CONTACT DRAFFED NZ FOR ANY CONTRADICTIONS OR ONSITE ANOMALIES.

- PLANS ARE TO BE CROSS REFERENCED B. READ IN CONCURRENCE WITH PROJECT SPECIFICATIONS,

- CONSULTANT REPORTS & SPECIALIST DOCUMENTATION


- ALL WORK TO BE CARRIED OUT IN ACCORDANCE WITH 1HE NEW ZEALAND BUILDING

- CODE, RELEVAND IDSTRICT PLAN REQUIREMENTS & OR RESOURCE MANAGEMENT ACT

- THE COPYRIGHT OF THIS DRAWING IS VESTED IN DRAFTED NZ & IT MAY NOT BE

- REPRODUCED IN WHOLE OR PART OR USED FOR THE MANUFACTURE OF ANY

- ARTICLE WITHOUT THE EXPRESS PERMISSION OF THE COPYRIGHT HOLDERS. ROOF FRAMING PLAN M PRITCHARD <u>DESIGN</u> NEW TWO STOREY DWELLING 11 TE HARAWIRA STREET LOT 2, 169 MANLY STREET, SCALE AT A3: STATUS: PARAPARAUMU OCT 25 AMEND JS 1:100 JS PHONE: 022 607 0234 **⊕**|drafted|**Γ** PROJECT NO: REVISION: EMAIL: drafted.nz@gmail.com 3224 www.drafted.nz

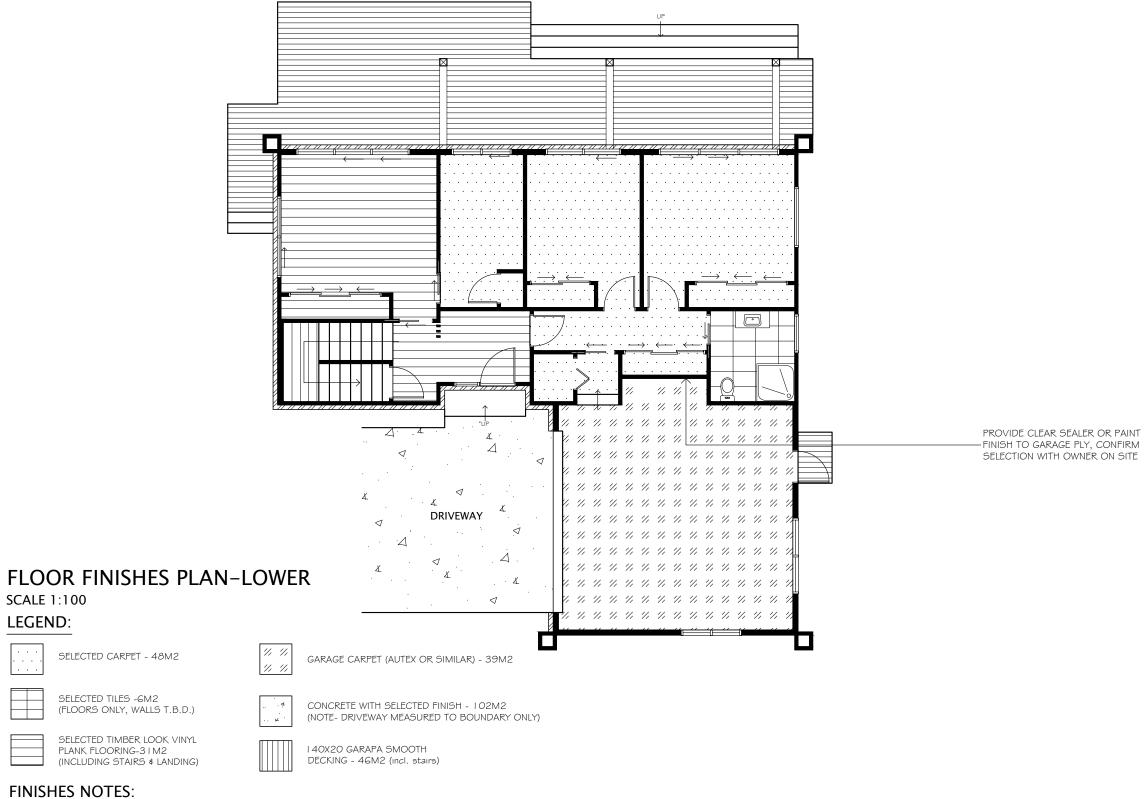

FINISHES NOTES:

-ALL MEASUREMENTS ARE APPROXIMATE \$ MUST BE CONFIRMED BY FLOORING SUPPLIER/INSTALLER, NO WASTAGE HAS BEEN ACCOUNTED FOR

	-		<u> </u>	RAFTED ARCHITECTURAL DESIGN
-				- 11 TE HARAWIRA STREET OTAKI,NZ
	ф DF	RAFTED		PHONE: 022 607 0234 EMAIL: drafted.nz@gmail.com
				www.drafted.nz

<u>NOTES</u>

INDIES

- DO NOT SCALE FROM DRAWINGS

- CONTRACTORS TO VERIFY ALL MEASUREMENTS & LOCATION OF SERVICES ON SITE PRIOR

TO COMMENDIGNE WORK, CONTACT DRAFTED.NZ FOR ANY CONTRADICTIONS OR ONSITE ANOMAI

- PLANS ARE TO BE CROSS REFERENCED & READ IN CONCURRENCE WITH PROJECT SPECIFICATIONS,

CONSULTANT REPORTS & SPECIALIST DOCUMENTATION

- ALL WORK TO BE CARRIED OUT IN ACCORDANCE WITH THE NEW ZEALAND BUILDING

- CODE, RELEVANT DISTRICT PLAN REQUIREMENTS & OR RESDUCE MANAGEMENT ACT

- THE COPYRIGHT OF THIS DRAWING IS VESTED IN DRAFTED.NZ & IT MAY NOT BE

REPRODUCED IN WHOLE OR PAST OR USED FOR THE MANUFACTURE OF ANY


ARTICLE WITHOUT THE EXPRESS PERMISSION OF THE COPYRIGHT HOLDERS.

PROJECT: NEW TWO STOREY DWELLING LOT 2, 169 MANLY STREET, PARAPARAUMU

<u>CLIENT:</u> M PRITCHARD

FINISHES PLAN-LOWER

SCALE AT A3:	DATE:	DRAWN:	CHECKED:	STATUS:
1:100	OCT 25	JS	JS	AMEN
PROJECT NO:	REVISION:	DRAWING NO):	•
3224		125		

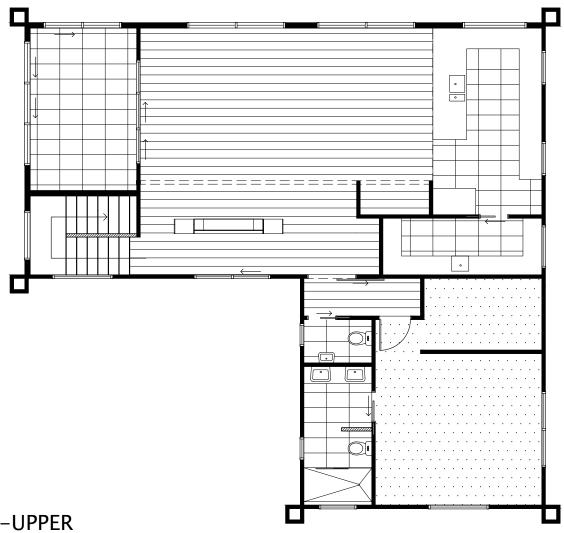

FLOOR FINISHES PLAN-UPPER

SCALE 1:100

LEGEND:

SELECTED CARPET - 25M2

SELECTED TIMBER LOOK VINYL PLANK FLOORING-58M2 (INCLUDING STAIRS & LANDING)



SELECTED TILES -23M2 (FLOORS ONLY, WALLS T.B.D.)

FINISHES NOTES:

-ALL MEASUREMENTS ARE APPROXIMATE & MUST BE CONFIRMED BY FLOORING SUPPLIER/INSTALLER, NO WASTAGE HAS BEEN ACCOUNTED FOR

DRAFTED ARCHITECTURAL <u>DESIGN</u> 11 TE HARAWIRA STREET PHONE: 022 607 0234 EMAIL: drafted.nz@gmail.com www.drafted.nz

<u>NOTES</u>

INDITED

OD NOT SCALE FROM DRAWINGS

-CONTRACTORS TO VERIFY ALL MEASUREMENTS & LOCATION OF SERVICES ON SITE PRIOR

TO COMMENCING WORK, CONTACT DRAFTED.NZ FOR ANY CONTRADICTIONS OR ONSITE ANOMAL

-PLANS ARE TO BE CROSS REFERENCED & READ IN CONCURRENCE WITH PROJECT SPECIFICATIONS,

CONSULTANT REPORTS & SPICLALIST DOCUMENTATION

-ALL WORK TO BE CARRIED OUT IN ACCORDANCE WITH THE NEW ZEALAND BUILDING

CODE, RELEVANT DISTRICT PLAN REQUIREMENTS & OR RESOURCE MANAGEMENT ACT

-THE COPYRICHT OF THIS DRAWING BY VESTED IN DRAFTED.NZ & IT MAY NOT BE


REPRODUCED IN WHOLE OR PART OR USED FOR THE MANUFACTURE OF ANY

ARTICLE WITHOUT THE EXPRESS PERMISSION OF THE COPYRIGHT HOLDERS.


PROJECT: NEW TWO STOREY DWELLING LOT 2, 169 MANLY STREET, PARAPARAUMU


CLIENT:	
M PRITCHARD	

FINISHE	FINISHES PLAN-UPPER							
SCALE AT A3:	DATE:	DRAWN:	CHECKED:	STATUS:				
1:100	OCT 25	JS	JS	AMEND				
PROJECT NO:	REVISION:	DRAWING NO:						
3224		26						

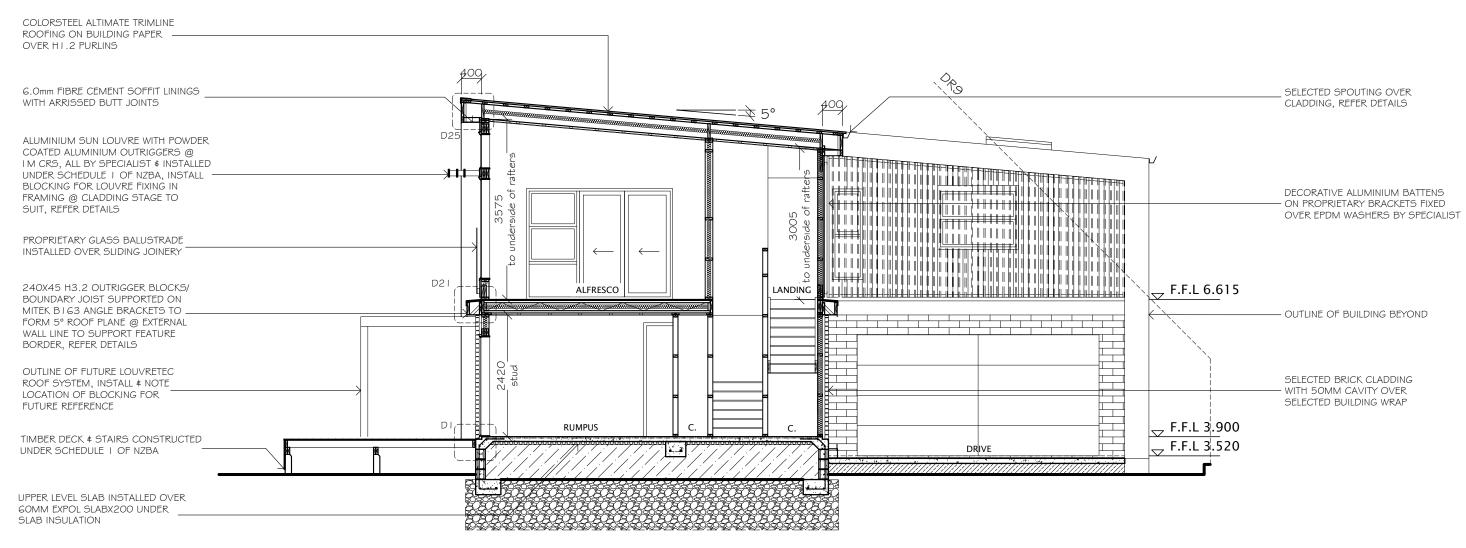



CROSS SECTION A-A SCALE 1:75

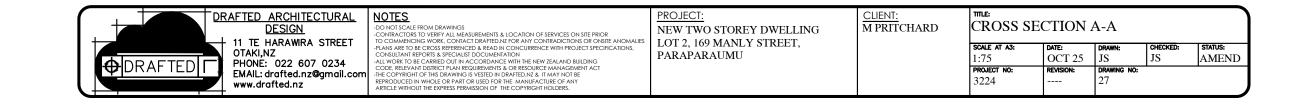

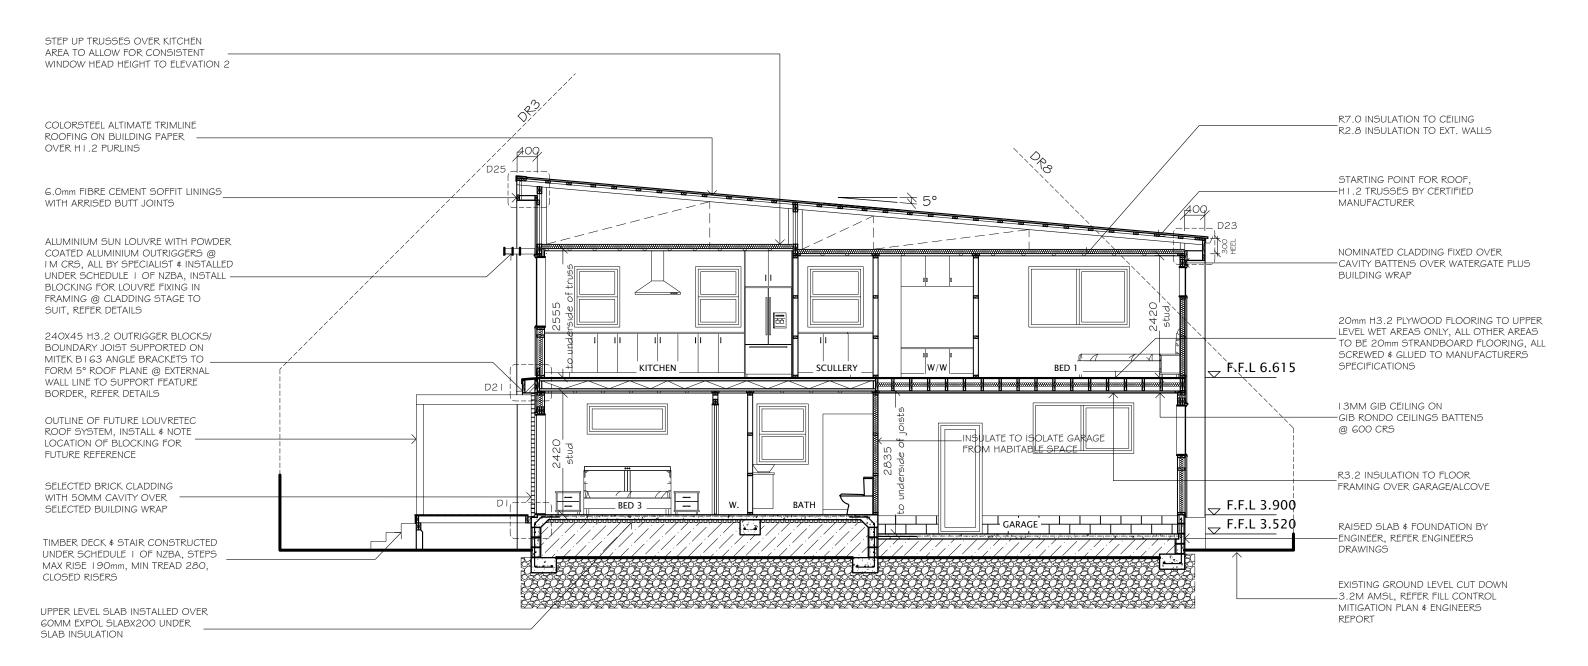



CROSS SECTION B-B SCALE 1:75

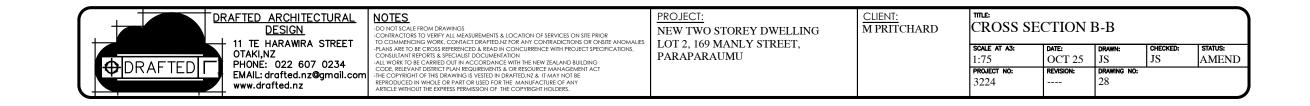

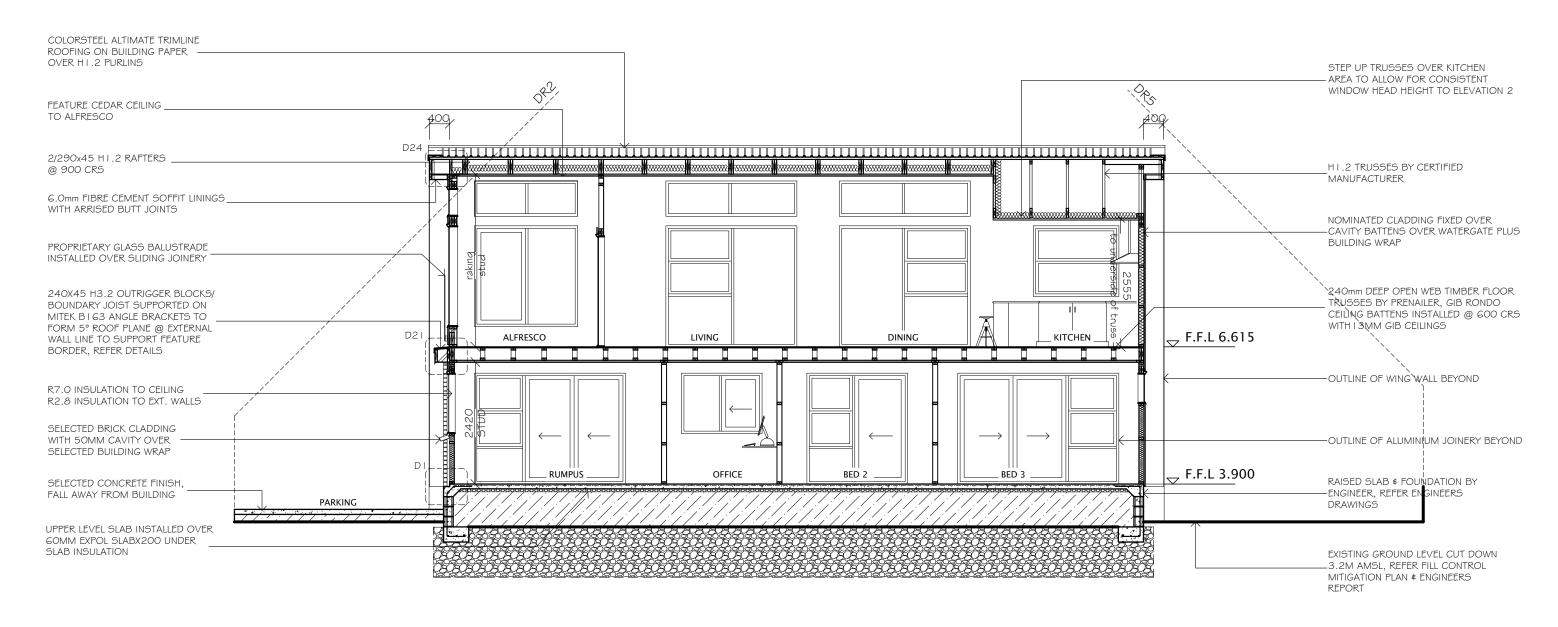



CROSS SECTION C-C

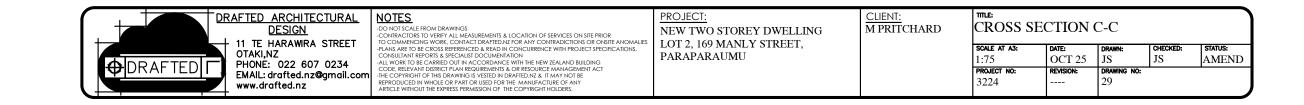

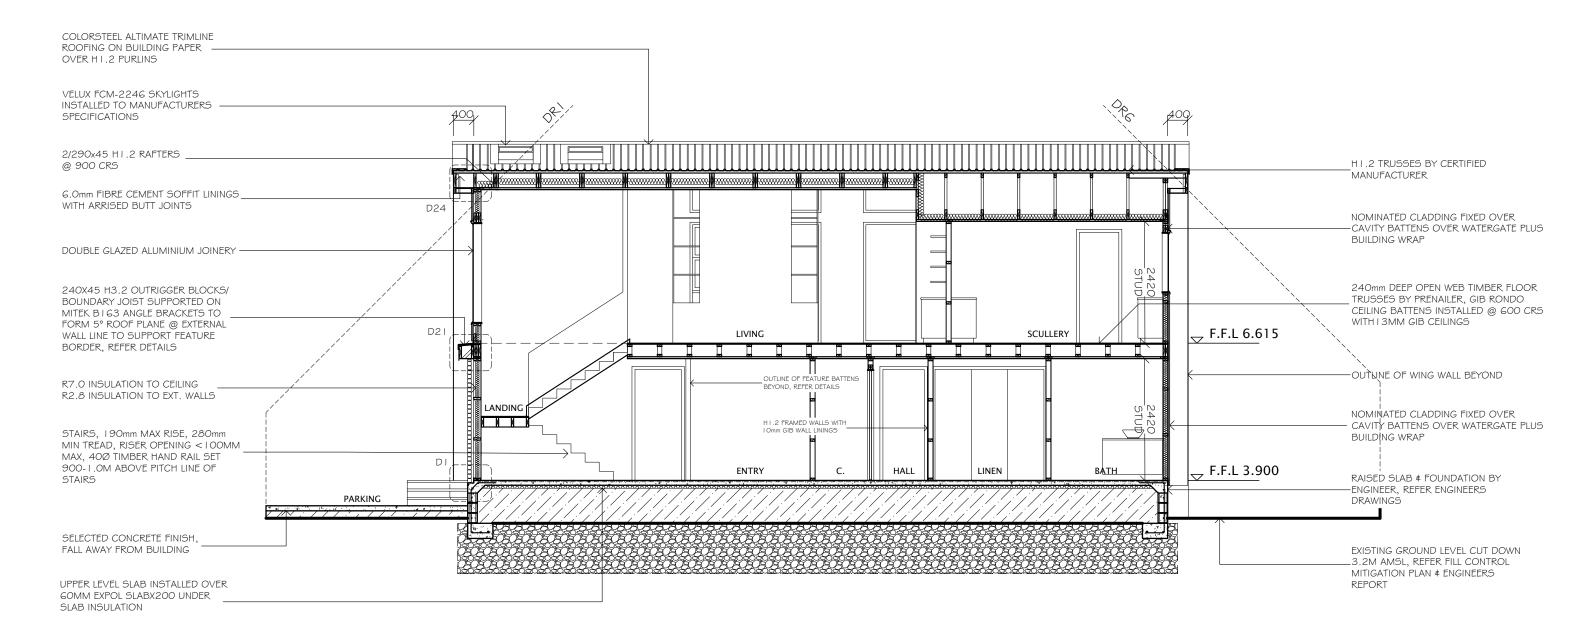



CROSS SECTION D-D SCALE 1:75

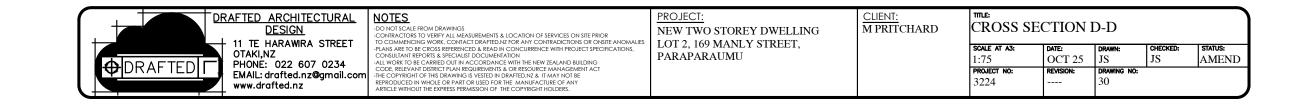

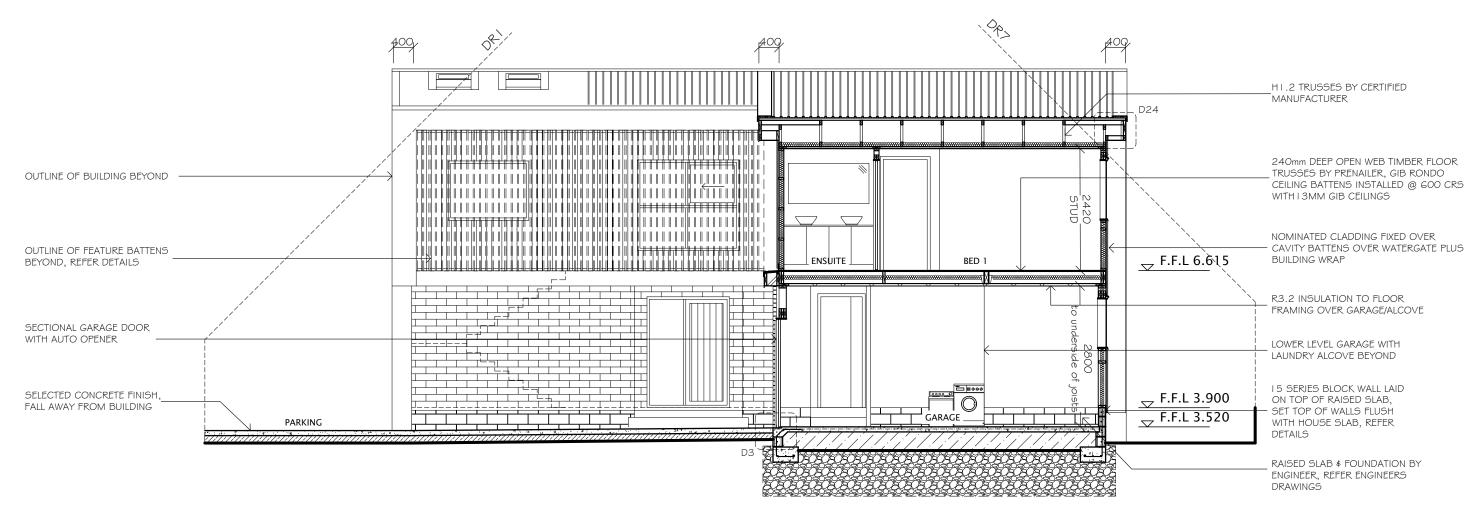

CROSS SECTION E-E SCALE 1:75

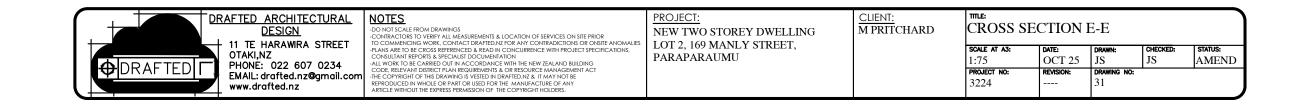

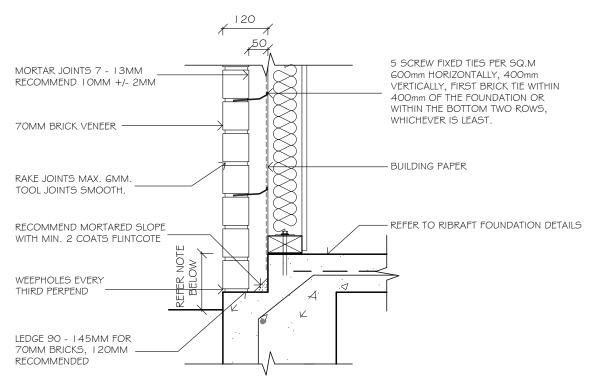

DETAIL 1 (D1)

BRICK VENEER FOUNDATION DETAIL

SCALE 1:10

NOTE:


FINISHED FLOOR LEVEL

TO FINISHED EXT. GROUND LEVEL

- I OOmm MIN. TO PAVED/SEALED GROUND - 225mm MIN. TO UNPROTECTED GROUND

CAVITY WIDTH 40mm MIN -75mm MAX-50mm RECOMMENDED



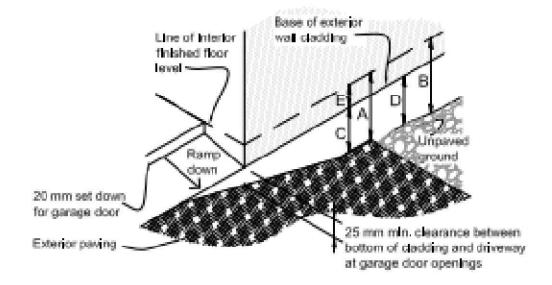

DETAIL 3 (D3) **GARAGE DOOR ENTRY DETAIL**

> DRAFTED ARCHITECTURAL <u>DESIGN</u> 11 TE HARAWIRA STREET PHONE: 022 607 0234 **⊕**|drafted|**r** EMAIL: drafted.nz@gmail.cor www.drafted.nz

NOTES

NOTES

- DO NOT SCALE FROM DRAWINGS

- CONTRACTORS TO VERIFY ALL MEASUREMENTS & LOCATION OF SERVICES ON SITE PRIOR

- CONTRACTORS TO VERIFY ALL MEASUREMENTS & LOCATION OF SERVICES ON SITE PRIOR

- COMMENCING WORK, CONTACT DRAFTED N.F OR ANY CONTRADICTIONS OR ONSITE ANOMALI

- PLANS ARE TO BE CROSS REFERENCED A READ IN CONCURRENCE WITH PROJECT SPECIFICATIONS,

- CONSULTAIN REPORTS & SPECIALIST DOCUMENTATION

- ALL WORK TO BE CARRIED OUT IN ACCORDANCE WITH THE NEW ZEALAND BUILDING

- CODE, RELEVANT DISTRICT PLAN REQUIREMENTS & OR RESOURCE MANAGEMENT ACT

- THE COPYRIGHT OF THIS DRAWING IS VESTED IN DRAFTED N.Z & IT MAY NOT BE


- REPRODUCED IN WHOLE OR PART OR USED FOR THE MANUFACTURE OF ANY

- ARTICLE WITHOUT THE EXPRESS PERMISSION OF THE COPYRIGHT HOLDERS.

PROJECT: NEW TWO STOREY DWELLING LOT 2, 169 MANLY STREET, PARAPARAUMU

M PRITCHARD

DETAILS SCALE AT A3: STATUS: AS SHOWN OCT 25 AMEND PROJECT NO: 3224

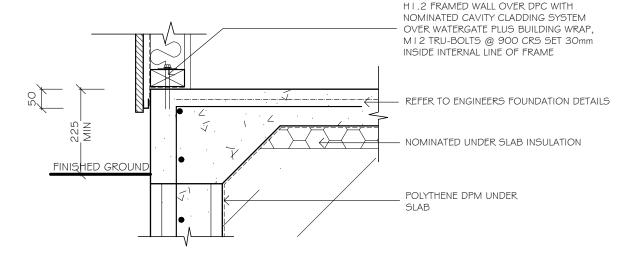

DETAIL 2 (D2)

FOUNDATION DETAIL- WEATHERBOARD SCALE 1:10


NOTE:

MINIMIUM CLEARANCE FROM FINISHED FLOOR LEVEL TO FINISHED EXT. GROUND LEVEL


- I 50mm MIN. TO PAVED/SEALED GROUND


- 225mm MIN. TO UNPROTECTED GROUND

Table 18:				, 9.1.3).1.3.5					
Minimum clearances	Masonry Other claddings veneer						AND		
(mm)	A	В	A	В	C	D	E		
Concrete slab	100	150	150	225	100	175	50		
Timber floo	r Refe	Note	1)		100	175	502		
	fer to I adding t	o exter	nd min	imum !	50 mm	below			

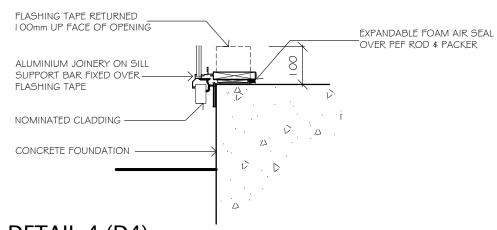


DETAIL 4 (D4) FOUNDATION SILL DETAIL **SCALE** 1:10

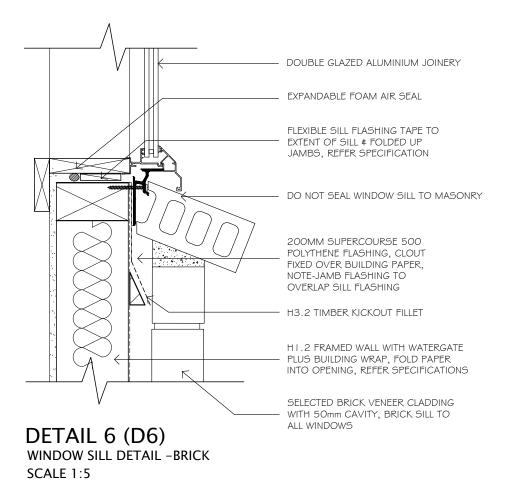

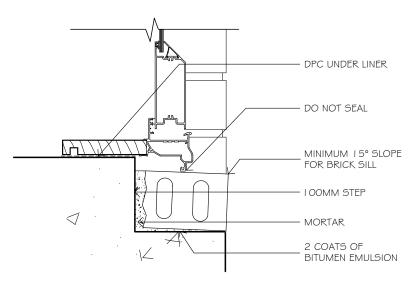

DETAIL 5 (D5) DOOR SILL DETAIL-BRICK SCALE 1:5 NOTE:

-WANZ ALUMINIUM SUPPORT BAR OMITTED FOR CLARITY -NOTE: IF BRICK IS TO BE SLOPED FURTHER EITHER INCREASE THE DEPTH OF THE STEP OR REDUCE THE THICKNESS OF BRICK.

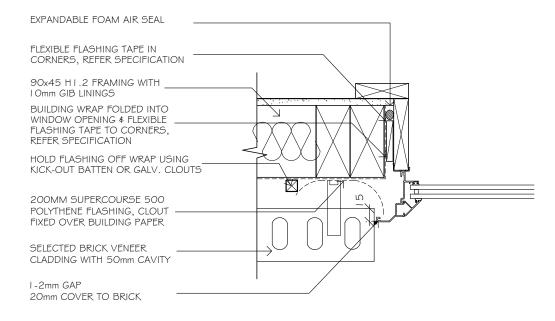

DETAIL 7 (D7) WINDOW JAMB DETAIL - BRICK SCALE 1:5



NOTES


NOTES

- DO NOT SCALE FROM DRAWINGS
- CONTRACTORS TO VERIFY ALL MEASUREMENTS & LOCATION OF SERVICES ON SITE PRIOR
- CONMENCING WORK, CONTACT DRAFTED MZ FOR ANY CONTRADICTIONS OR ONSITE ANOMALIES
- PLANS ARE TO BE CROSS REFERENCED & READ IN CONCURRENCE WITH PROJECT SPECIFICATIONS,
- CONSULTANT REPORTS & SPECIALIST DOCUMENTATION
- ALL WORK TO BE CARRIED OUT IN ACCORDANCE WITH THE NEW ZEALAND BUILDING
- CODE, RELEVANT DISTRICT PLAN REQUIREMENTS & OR RESOURCE MANAGEMENT ACT
- THE COPYRIGHT OF THIS DRAWING IS VESTED IN DRAFTED MZ & IT MAY NOT BE
- REPRODUCED IN WHOLE OR PAST OR USED FOR THE MANUFACTURE OF ANY
- ARTICLE WITHOUT THE EXPRESS PERMISSION OF THE COPYRIGHT HOLDERS.

PROJECT:
NEW TWO STOREY DWELLING
LOT 2, 169 MANLY STREET,
PARAPARAUMU

CLIENT: M PRITCHARD	DETAILS	}	
	SCALE AT A3:	DATE:	D
	AS SHOWN	OCT 25	J
	PROJECT NO:	REVISION:	D


DETAILS				
SCALE AT A3:	DATE:	DRAWN:	CHECKED:	STATUS:
AS SHOWN	OCT 25	JS	JS	AMEND
PROJECT NO:	REVISION:	DRAWING NO:		
3224		33		

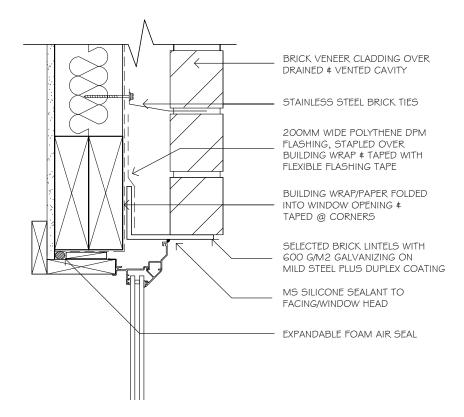


DETAIL 8 (D8) WINDOW HEAD DETAIL SCALE 1:5

NOTE:

ALL BRICK LINTELS TO HAVE A 600 G/M2 GALVANIZING ON MILD STEEL PLUS DUPLEX COATING, RESENE SYSTEM NUMBER 5D, REFER SPECIFICATIONS

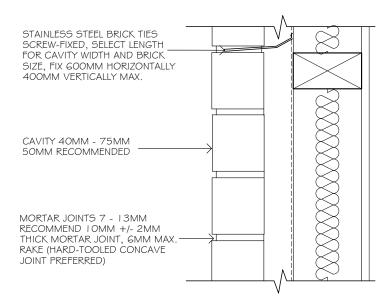


DETAIL 10 (D10) TYPICAL WALL SECTION DETAIL-BRICK SCALE 1:5

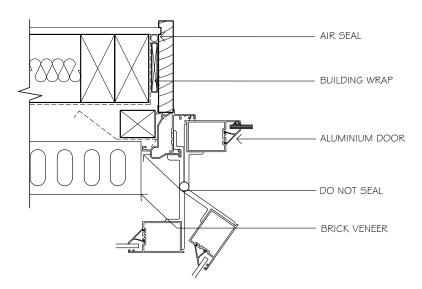

DETAIL 9 (D9) DOOR JAMB DETAIL-BRICK SCALE 1:5 NOTE:

-LINE OF HEAD & SILL FLASHINGS TO EXTEND 200mm EACH SIDE OF OPENING

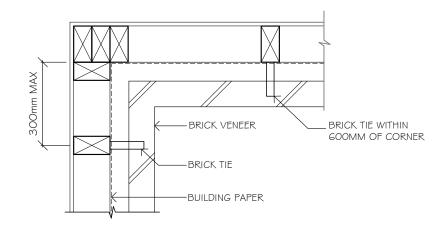

DETAIL 11 (D11) STANDARD INTERNAL CORNER DETAIL-BRICK SCALE 1:10



NOTES


NOTES

- DO NOT SCALE FROM DRAWINGS
- CONTRACTORS TO VERIFY ALL MEASUREMENTS & LOCATION OF SERVICES ON SITE PRIOR
- CONTRACTORS TO VERIFY ALL MEASUREMENTS & LOCATION OF SERVICES ON SITE PRIOR
- COMMENCING WORK, CONTACT DRAFTED NZ FOR ANY CONTRADICTIONS OR ONSITE ANOMALIE
- PLANS ARE TO BE CROSS REFERENCED & READ IN CONCURRENCE WITH PROJECT SPECIFICATIONS,
- CONSULTANT REPORTS & SPECIALIST DOCUMENTATION
- ALL WORK TO BE CARRIED OUT IN ACCORDANCE WITH THE NEW ZEALAND BUILDING
- CODE. RELEVAND IDSTRICT PLAN REQUIREMENTS & OR RESOURCE MANAGEMENT ACT
- THE COPYRIGHT OF THIS DRAWING IS VESTED IN DRAFTED NZ & IT MAY NOT BE
- REPRODUCED IN WHOLE OR PART OR USED FOR THE MANUFACTURE OF ANY
- ARTICLE WITHOUT THE EXPRESS PERMISSION OF THE COPYRIGHT HOLDERS.

PROJECT: NEW TWO STOREY DWELLING LOT 2, 169 MANLY STREET, PARAPARAUMU


<u>CLIENT:</u> I PRITCHARD	DE7
	SCALE AT
	AS SI

DETAILS				
SCALE AT A3:	DATE:	DRAWN:	CHECKED:	STATUS:
AS SHOWN	OCT 25	JS	JS	AMEND
PROJECT NO:	REVISION:	DRAWING NO:		
3224		34		

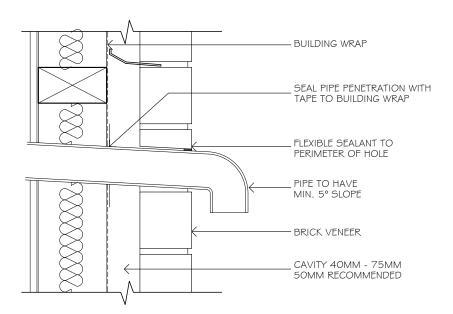


DETAIL 12 (D12) TYPICAL PIPE PENETRATION DETAIL-BRICK SCALE 1:5

SCALE 1:5

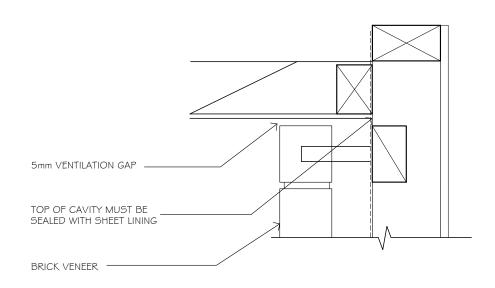

DETAIL 13 (D13) FLAT SOFFIT DETAIL-BRICK SCALE 1:5

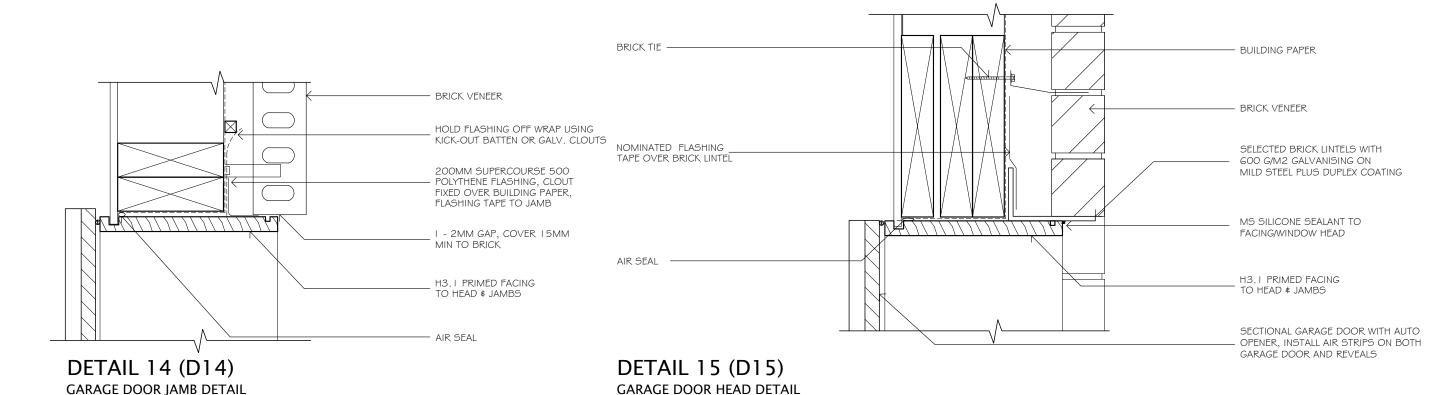



NOTES

INDIES


- ON DIS SCALE FROM DRAWINGS
- CONTRACTORS TO VERIFY ALL MEASUREMENTS & LOCATION OF SERVICES ON SITE PRIOR
- COMMENCING WORK, CONTACT DRAFTED NZ FOR ANY CONTRADICTIONS OR ONSITE ANOMALIE
- PLANS ARE TO BE CROSS REFERENCED & READ IN CONCURRENCE WITH PROJECT SPECIFICATIONS,
- CONSULTANT REPORTS & SPECIALIST DOCUMENTATION
- ALL WORK TO BE CARRIED OUT IN ACCORDANCE WITH THE NEW ZEALAND BUILDING
- CODE, RELEVANT DISTRICT PLAN REQUIREMENTS & OR RESOURCE MANAGEMENT ACT
- THE COPYRICHT OF THIS DRAWING IS VESTED IN DRAFTED NZ & IT MAY NOT BE
- REPRODUCED IN WHOLE OF PART OR USED FOR THE MANUFACTURE OF ANY
- ARTICLE WITHOUT THE EXPRESS PERMISSION OF THE COPYRIGHT HOLDERS.

SCALE 1:5


PROJECT: NEW TWO STOREY DWELLING LOT 2, 169 MANLY STREET, PARAPARAUMU

CLIENT: I PRITCHARD	DE'
	SCALE A
	AS SI
	PROJECT
	3224


ETAILS				
e at a3: Shown	DATE: OCT 25	JS	JS	STATUS: AMEND
ECT NO: 24	REVISION:	DRAWING NO:		

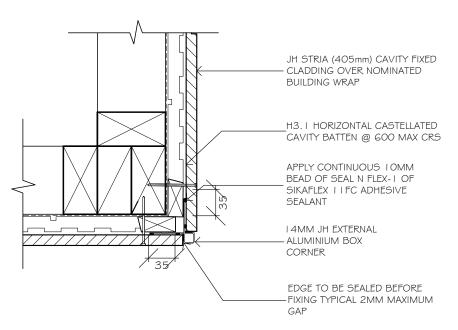


DETAIL 16 (D16)
EXTERNAL CORNER DETAIL-STRIA
SCALE 1:5

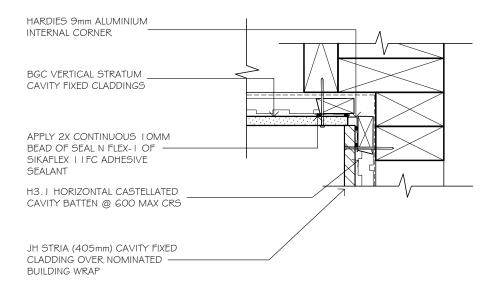

DETAIL 18 (D18)
INTERNAL CORNER BGC STRATUM TO STRIA DETAIL
SCALE 1:5

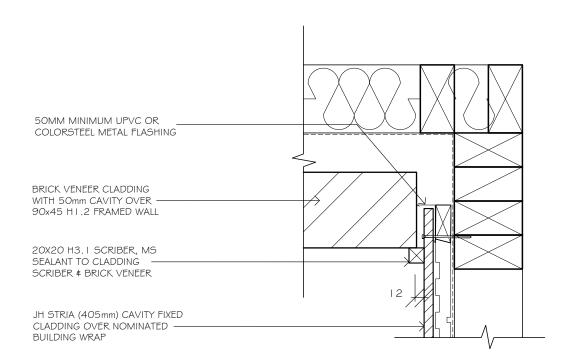



DETAIL 17 (D17)
INTERNAL CORNER BRICK TO STRIA DETAIL
SCALE 1:5

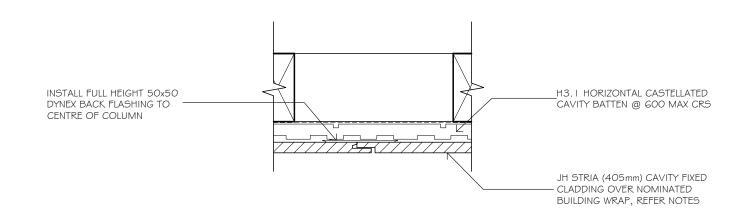


DETAIL 19 (D19) VERTICAL JOINT DETAIL @ COLUMNS SCALE 1:5 NOTES:

- I . INSTALL FULL HEIGHT 50x50 DYNEX BACK FLASHING TO CENTRE OF COLUMN
- 2. TRIM TONGUE OF REAR BOARD TO CREATE A 2-5MM MAX VERTICAL GAP AT
- THE VERTICAL JOINT
- 3. PRIME ALL CUT EDGES
- 4. PAINT TONGUE OF REAR BOARD WITH FINAL COLOUR SELECTION PRIOR TO INSTALLATION
- 5. INSTALL BOARDS WITH JOINT PLACED CENTRE OF COLUMN-OVER BACK FLASHING

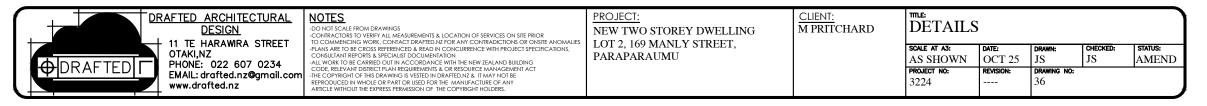

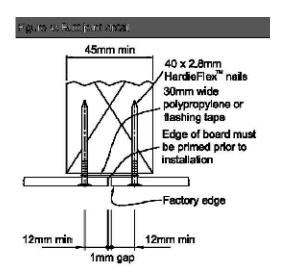

DETAIL 20 (D20) SOFFIT JOINT DETAIL- WEATHERBOARD SCALE 1:10

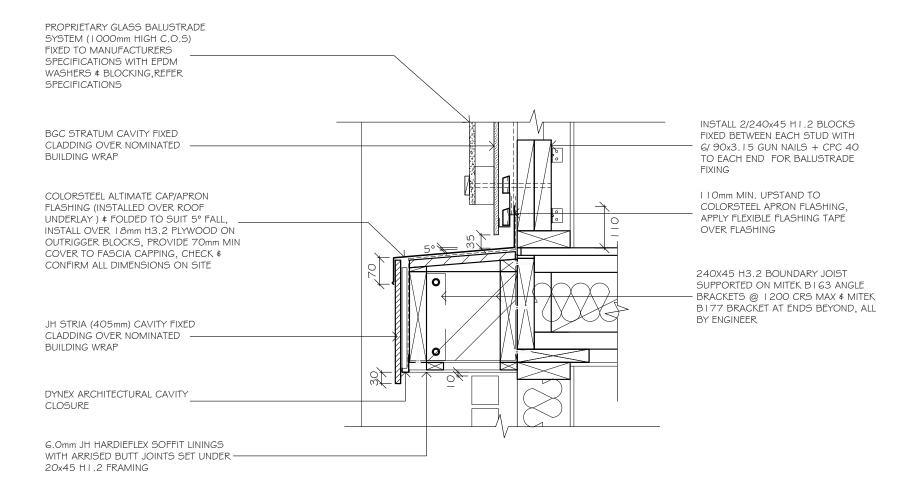

DETAIL 21 (D21)

FEATURE BORDER ROOF **SCALE** 1:10



NOTES

INDIES


- ON DIS SCALE FROM DRAWINGS
- CONTRACTORS TO VERIFY ALL MEASUREMENTS & LOCATION OF SERVICES ON SITE PRIOR
- CONTRACTORS TO VERIFY ALL MEASUREMENTS & LOCATION OF SERVICES ON SITE PRIOR
- COMMENCING WORK, CONTACT DRAFTED NZ FOR ANY CONTRADICTIONS OR ONSITE ANOMALIE
- PLANS ARE TO BE CROSS REFERENCED & BEAD IN CONCURRENCE WITH PROJECT SPECIFICATIONS,
- CONSULTANT REPORTS & SPECIALIST DOCUMENTATION
- ALL WORK TO BE CARRED OUT IN ACCORDANCE WITH THE NEW ZEALAND BUILDING
- CODE, RELEVANT DISTRICT PLAN REQUIREMENTS & OR RESOURCE MANAGEMENT ACT
- THE COPYRICHT OF THIS DRAWING IS VESTED IN DRAFTED NZ & IT MAY NOT BE
- REPRODUCED IN WHOLE OR PART OR USED FOR THE MANUFACTURE OF ANY
- ARTICLE WITHOUT THE EXPRESS PERMISSION OF THE COPYRIGHT HOLDERS.

PROJECT: NEW TWO STOREY DWELLING LOT 2, 169 MANLY STREET, PARAPARAUMU


CLIENT: M PRITCHARD

DETAILS JS

SCALE AT A3: STATUS: AS SHOWN OCT 25 JS AMEND PROJECT NO: REVISION: 3224

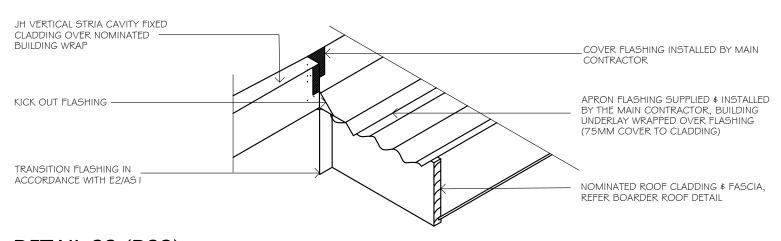

DETAIL 22 (D22) BOARDER ROOF KICK OUT FLASHING DETAIL SCALE 1:5

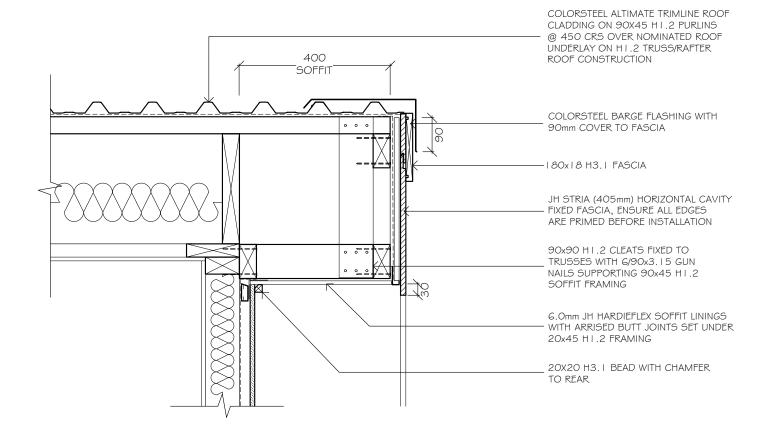

DETAIL 24 (D24)

BARGE DETAIL SCALE 1:10 NOTE:

-INSTALL 50X50 DYNAFLASH FLASHING TO SOFFIT & WALL CLADDING JUNCTION

DRAFTED ARCHITECTURAL <u>DESIGN</u> 11 TE HARAWIRA STREET PHONE: 022 607 0234 **H**DRAFTEDI**F** EMAIL: drafted.nz@gmail.cor www.drafted.nz

NOTES

NOTES

- DO NOT SCALE FROM DRAWINGS

- CONTRACTORS TO VERIFY ALL MEASUREMENTS & LOCATION OF SERVICES ON SITE PRIOR

- CONTRACTORS TO VERIFY ALL MEASUREMENTS & LOCATION OF SERVICES ON SITE PRIOR

- COMMENCING WORK, CONTACT DRAFTED NZ FOR ANY CONTRADICTIONS OR ONSITE ANOMALIE

- PLANS ARE TO BE CROSS REERENCED & READ IN CONCURRENCE WITH PROJECT SPECIFICATIONS,

- CONSULTAIN REPORTS & SPECIALIST DOCUMENTATION

- ALL WORK TO BE CARRIED OUT IN ACCORDANCE WITH THE NEW ZEALAND BUILDING

- CODE, RELEVAND IDSTRICT PLAN REQUIREMENTS & OR RESOURCE MANAGEMENT ACT

- THE COPYRIGHT OF THIS DRAWING IS VESTED IN DRAFTED NZ & IT MAY NOT BE


- REPRODUCED IN WHOLE OR PART OR USED FOR THE MANUFACTURE OF ANY

- ARTICLE WITHOUT THE EXPRESS PERMISSION OF THE COPYRIGHT HOLDERS.

PROJECT: NEW TWO STOREY DWELLING LOT 2, 169 MANLY STREET, PARAPARAUMU

CLIENT: M PRITCHARD

DETAILS SCALE AT A3: STATUS: AS SHOWN OCT 25 AMEND JS JS PROJECT NO: 3224

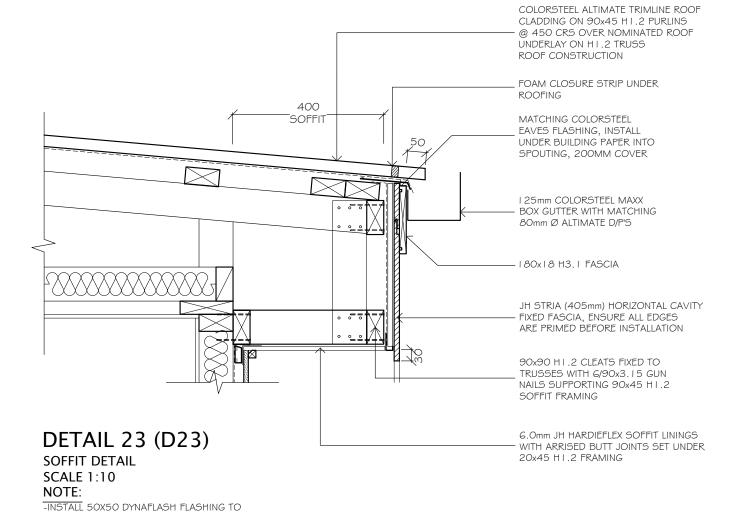

COLORSTEEL ALTIMATE TRIMLINE ROOF CLADDING ON 90X45 H1.2 PURLINS @ 450 CRS OVER NOMINATED ROOF UNDERLAY ON HI.2 TRUSS/RAFTER ROOF CONSTRUCTION COLORSTEEL BARGE FLASHING WITH 90mm COVER TO FASCIA FLASHING 180x18 H3.1 FASCIA

> JH STRIA (405mm) HORIZONTAL CAVITY FIXED FASCIA. ENSURE ALL EDGES ARE PRIMED BEFORE INSTALLATION

90x90 H I .2 CLEATS FIXED TO TRUSSES WITH 6/90x3.15 GUN NAILS SUPPORTING 90x45 H1.2 SOFFIT FRAMING

6.0mm JH HARDIEFLEX SOFFIT LININGS WITH ARRISED BUTT JOINTS SET UNDER 20x45 H1.2 FRAMING

20X20 H3. I BEAD WITH CHAMFER TO REAR

-INSTALL 50X50 DYNAFLASH FLASHING TO SOFFIT # WALL CLADDING JUNCTION


DETAIL 25 (D25)

BARGE DETAIL


SCALE 1:10

NOTE:


SOFFIT # WALL CLADDING JUNCTION

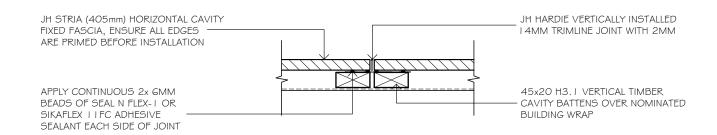

DETAIL 26 (D26) VERTICAL FASCIA JOINT DETAIL SCALE 1:5

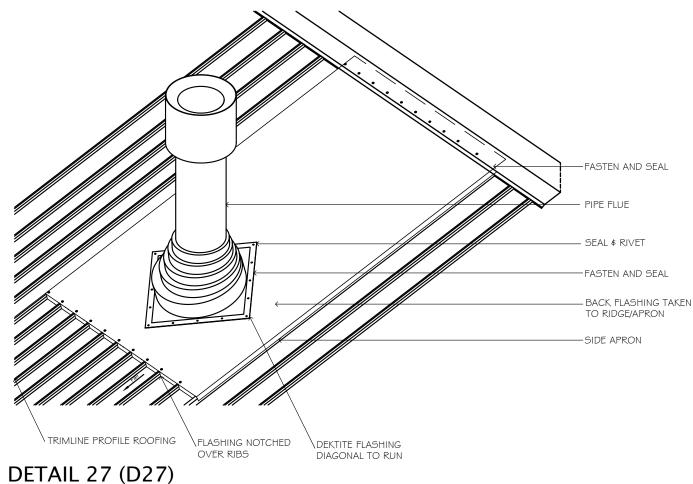

ROOF PENETRATION DETAIL SCALE 1:20

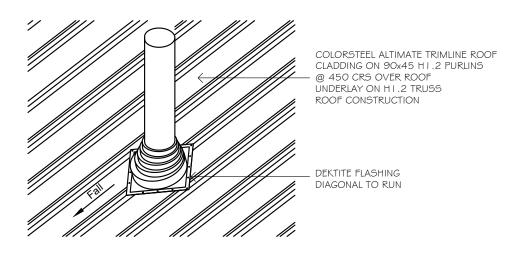

NOTE:

DETAIL 28 (D28) ROOF PENETRATION DETAIL

-PROPRIETARY VENT FLASHING TO BE INSTALLED IN STRICT ACCORDANCE WITH MANUFACTURERS RECOMMENDATIONS IN PARTICULAR ORIENTATION TO RIDGE \$ MINIMUM FALL REQUIREMENTS



DRAFTED ARCHITECTURAL **DESIGN** 11 TE HARAWIRA STREET

PHONE: 022 607 0234 EMAIL: drafted.nz@gmail.cor www.drafted.nz

SCALE 1:10

NOTES


OD NOT SCALE FROM DRAWINGS
-CONTRACTORS TO VERIFY ALL MEASUREMENTS & LOCATION OF SERVICES ON SITE PRIOR
TO COMMENCING WORK, CONTACT DRAFTED.NZ FOR ANY CONTRADICTIONS OR ONSITE ANOMAL
-PLANS ARE TO BE CROSS REFERENCED & READ IN CONCURRENCE WITH PROJECT SPECIFICATIONS,
CONSULTANT REPORTS & SPECIALIST DOCUMENTATION
-ALL WORK TO BE CARRIED OUT IN ACCORDANCE WITH THE NEW ZEALAND BUILDING
CODE, RELEVANT DISTRICT PLAN REGOUREMENTS & OR RESOURCE MANAGEMENT ACT
-THE COPYRICHT OF THIS DRAWING BY VESTED IN DRAFTED.NZ & IT MAY NOT BE
REPRODUCED IN WHOLE OR PART OR USED FOR THE MANINECTURE OF ANY
ARTICLE WITHOUT THE EXPRESS PERMISSION OF THE COPYRIGHT HOLDERS.

PROJECT:


NEW TWO STOREY DWELLING LOT 2, 169 MANLY STREET, PARAPARAUMU


CLIENT:	
M PRITCHARD	

DETAILS					
	SCALE AT A3:	DATE:	DRAWN:	CHECKED:	STATUS:
	AS SHOWN	OCT 25	JS	JS	AMEND
	PROJECT NO:	REVISION:	DRAWING NO:		
	3224		39		
		1			

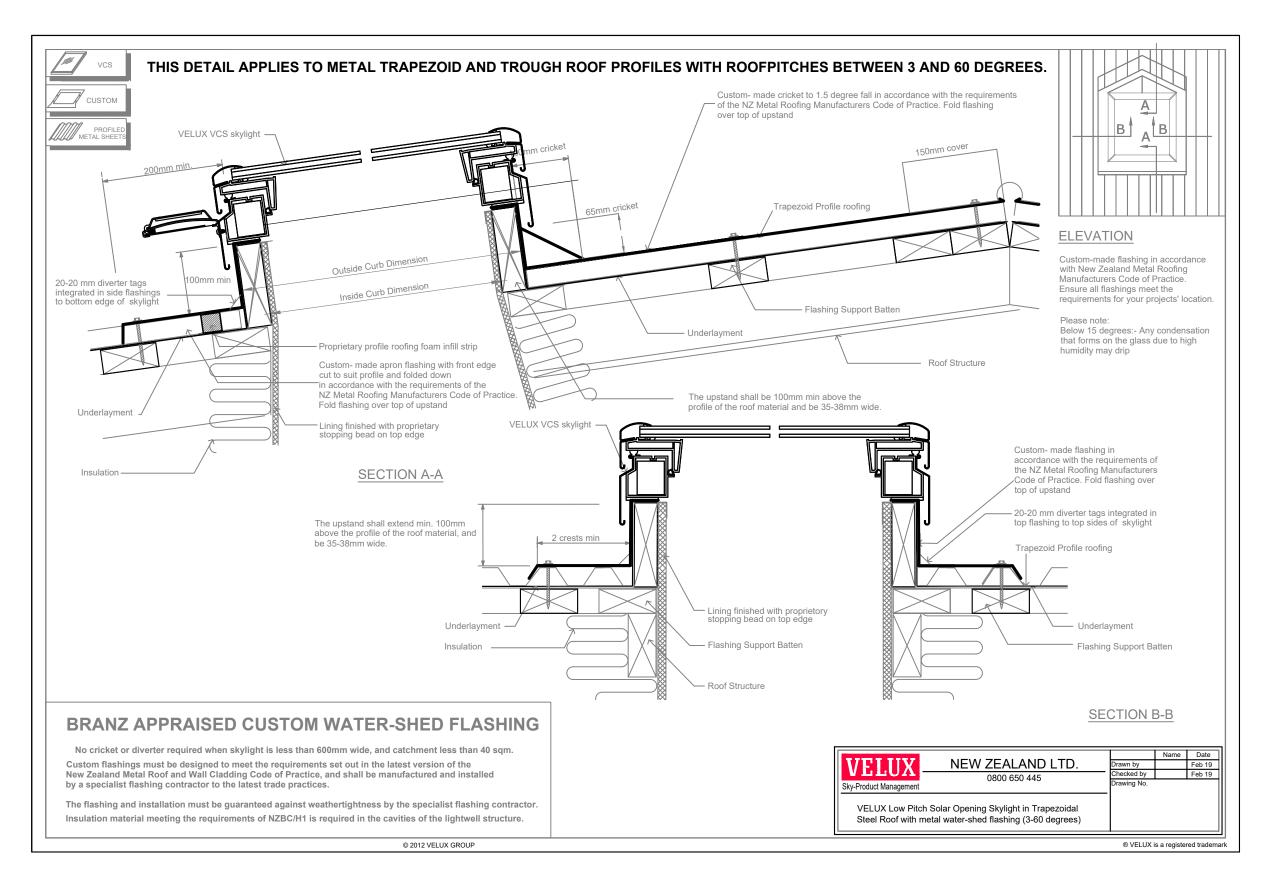

DETAIL 29 (D29) SKYLIGHT DETAIL SCALE N.T.S.

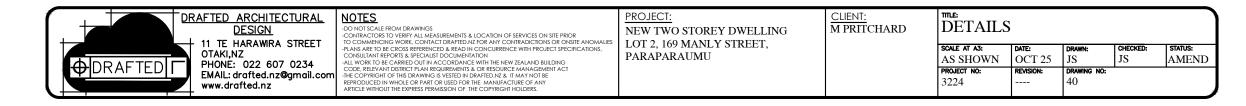


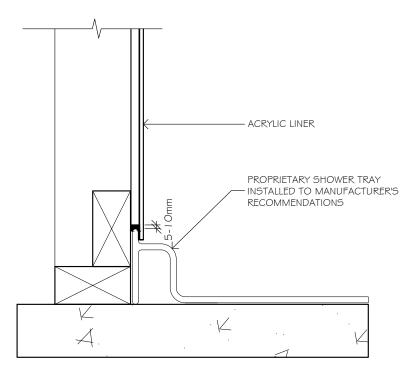


DETAIL 30 (D30) ACRYLIC SHOWER DETAIL SCALE 1:5

NOTE:

-ACRYLIC SHOWER TO BE INSTALLED IN STRICT ACCORDANCE WITH MANUFACTURERS INSTALLATION INSTRUCTIONS

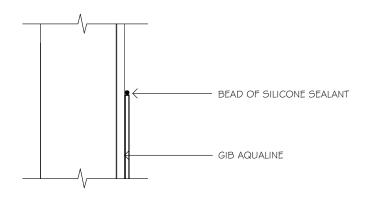


DETAIL 32 (D32) SHOWER WALL DETAIL SCALE 1:5

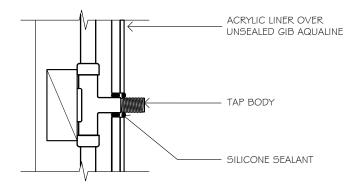

DETAIL 31 (D31) PENETRATION DETAIL SCALE 1:5

NOTE:

-WHERE IMPACT NOISE FROM PIPE IS AN ISSUE. FIX ALL PIPES ON RESILIENT BRACKETS

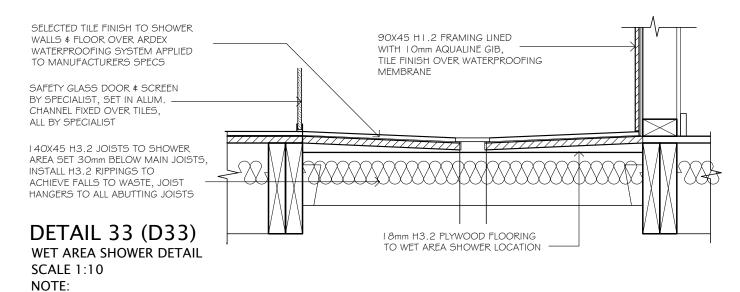

-EASY DWANG BOND BREAK TO INTERNAL CORNERS, REFER SPECIFICATION FOR WALL/FLOOR & PENETRATION DETAILS -REFER SPECIFICATIONS FOR GIB AQUALINE WET AREA SYSTEM MANUAL FOR WALL LINING FIXING REQUIREMENTS FOR ALL TILED WALLS OVER GIB PLASTER BOARD, IF SELECTED TILES EXCEED MAXIMUM WEIGHT LIMITS REFER TO JH VILLABOARD MANUAL OR ALTERNATIVE WET AREA LININGS



NOTES

NOTES

- DO NOT SCALE FROM DRAWINGS
- CONTRACTORS TO VERIFY ALL MEASUREMENTS & LOCATION OF SERVICES ON SITE PRIOR
- COMMENCING WORK, CONTACT DRAFTED NZ FOR ANY CONTRADICTIONS OR ONSITE ANOMALIE
- PLANS ARE TO BE CROSS REFERENCED & READ IN CONCURRENCE WITH PROJECT SPECIFICATIONS,
- CONSULTANT REPORTS & SPECIALIST DOCUMENTATION
- ALL WORK TO BE CARRIED OUT IN ACCORDANCE WITH 1HE NEW ZEALAND BUILDING
- CODE, RELEVAND IDSTRICT PLAN REQUIREMENTS & OR RESOURCE MANAGEMENT ACT
- THE COPYRIGHT OF THIS DRAWING IS VESTED IN DRAFTED NZ & IT MAY NOT BE
- REPRODUCED IN WHOLE OR PART OR USED FOR THE MANUPLACTURE OF ANY
- ARTICLE WITHOUT THE EXPRESS PERMISSION OF THE COPYRIGHT HOLDERS.


PROJECT: NEW TWO STOREY DWELLING LOT 2, 169 MANLY STREET, PARAPARAUMU

CLIENT: M PRITCHARD	DETAILS		
	SCALE AT A3:	DATE:	DRAW
	AS SHOWN	OCT 25	JS
	PROJECT NO:	REVISION:	DRAW
	3224		41

STATUS:

JS

AMEND

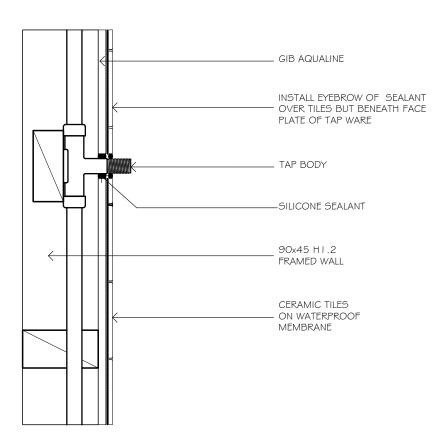


DETAIL 34 (D34)


PENETRATION DETAIL SHOWER - TILED WALLS SCALE 1:5

NOTE:

-WHERE IMPACT NOISE FROM PIPE IS AN ISSUE, FIX ALL PIPES ON RESILIENT BRACKETS

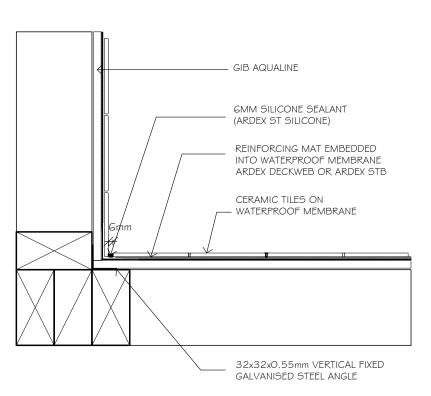

DETAIL 35 (D35) SHOWER WALL DETAIL SCALE 1:5

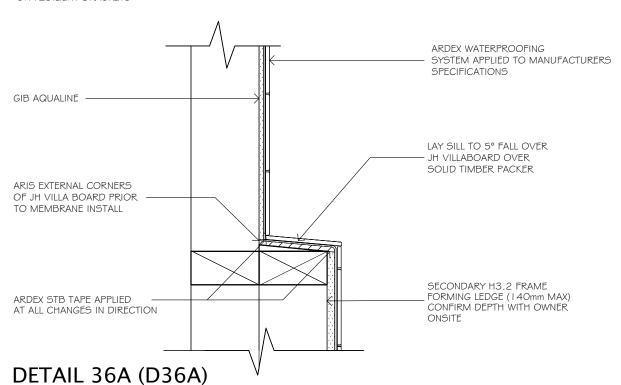

SHOWER LEDGE DETAIL – WET AREA SHOWER SCALE 1:5

NOTE:

-CONFIRM POSITION & DEPTH OF SHOWER LEDGE ONSITE WITH OWNER -WATERPROOF MEMBRANE TO BE INSTALLED IN ACCORDANCE WITH MANUFACTURERS SPECIFICATIONS BY LICENSED APPLICATOR



NOTES

NOTES

- DO NOT SCALE FROM DRAWINGS

- CONTRACTORS TO VERIFY ALL MEASUREMENTS & LOCATION OF SERVICES ON SITE PRIOR

- CONTRACTORS TO VERIFY ALL MEASUREMENTS & LOCATION OF SERVICES ON SITE PRIOR

- COMMENCING WORK, CONTACT DRAFTED NZ FOR ANY CONTRADICTIONS OR ONSITE ANOMALIE

- PLANS ARE TO BE CROSS REFERENCED & READ IN CONCURRENCE WITH PROJECT SPECIFICATIONS,

- CONSULTAIN REPORTS & SPECIALIST DOCUMENTATION

- ALL WORK TO BE CARRIED OUT IN ACCORDANCE WITH THE NEW ZEALAND BUILDING

- CODE, RELEVAND IDSTRICT PLAN REQUIREMENTS & OR RESOURCE MANAGEMENT ACT

- THE COPYRIGHT OF THIS DRAWING IS VESTED IN DRAFTED NZ & IT MAY NOT BE

- REPRODUCED IN WHOLE OR PART OR USED FOR THE MANUFACTURE OF ANY

- ARTICLE WITHOUT THE EXPRESS PERMISSION OF THE COPYRIGHT HOLDERS.

PROJECT: NEW TWO STOREY DWELLING LOT 2, 169 MANLY STREET, PARAPARAUMU

CLIENT: M PRITCHARD

DETAILS SCALE AT A3: STATUS: AS SHOWN OCT 25 AMEND JS PROJECT NO: 3224

DETAIL 36 (D36) OPTIONAL SHOWER RECESS DETAIL - WET AREA SHOWER SCALE 1:5 NOTE:

- GIB AQUALINE

SELECTED L.E.D. WET AREA

MANUFACTURERS SPECIFICATIONS

LIGHTING INSTALLED TO

ARIS EXTERNAL CORNERS

OF JH VILLA BOARD PRIOR TO MEMBRANE INSTALLATION

ARDEX WATERPROOFING

REFER SPECIFICATIONS

DOUBLE LAYER GIB & RECESS,


ARDEX STB TAPE APPLIED AT ALL CHANGES IN DIRECTION

LAY SILL TO 5° FALL


SYSTEM APPLIED TO MANUFACTURERS

SPECIFICATIONS (DETAIL AWW-07),

-DETAIL LIMITED TO INTERNAL WALLS ONLY -CONFIRM POSITION OF SHOWER RECESS ON SITE WITH OWNER -WATERPROOF MEMBRANE TO BE INSTALLED IN ACCORDANCE WITH MANUFACTURERS SPECIFICATIONS BY LICENSED APPLICATOR -WET AREA L.E.D. LIGHTING TO BE INSTALLED TO MANUFACTURERS SPECIFICATIONS IF SELECTED FIXTURES TO NOT HAVE RUBBER/SILICONE GASKET INSTALL OVER BEAD OF MS SILICONE

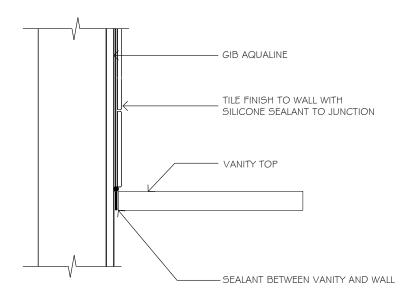

DETAIL 37 (D37) VANITY TOP/LINING JUNCTION SCALE 1:5

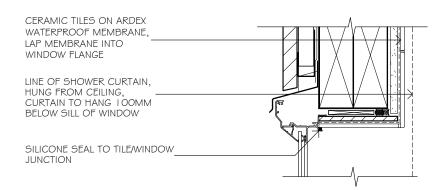

DETAIL 38C (D38C) WINDOW HEAD DETAIL - WET AREA SHOWER SCALE 1:5

NOTE:

-WATERPROOF MEMBRANE TO CONTINUE FULL PERIMETER OF WINDOW

-REFER SHADOWCLAD DETAIL KEY FOR WINDOW WEATHERTIGHT DETAILS

> DRAFTED ARCHITECTURAL <u>DESIGN</u> 11 TE HARAWIRA STREET

> > **H**DRAFTEDI**F**

PHONE: 022 607 0234 EMAIL: drafted.nz@gmail.cor www.drafted.nz

NOTES

- DO NOT SCALE FROM DRAWINGS
- CONTRACTORS TO VERIFY ALL MEASUREMENTS & LOCATION OF SERVICES ON SITE PRIOR
- CONTRACTORS TO VERIFY ALL MEASUREMENTS & LOCATION OF SERVICES ON SITE PRIOR
- COMMENCING WORK, CONTACT DRAFTED NZ FOR ANY CONTRADICTIONS OR ONSITE ANOMALIE
- PLANS ARE TO BE CROSS REFERENCED & READ IN CONCURRENCE WITH PROJECT SPECIFICATIONS,
- CONSULTANT REPORTS & SPECIALIST DOCUMENTATION
- ALL WORK TO BE CARRIED OUT IN ACCORDANCE WITH THE NEW ZEALAND BUILDING
- CODE, RELEVAND IDSTRICT PLAN REQUIREMENTS & OR RESOURCE MANAGEMENT ACT
- THE COPYRIGHT OF THIS DRAWING IS VESTED IN DRAFTED NZ & IT MAY NOT BE
- REPRODUCED IN WHOLE OR PART OR USED FOR THE MANUFACTURE OF ANY
- ARTICLE WITHOUT THE EXPRESS PERMISSION OF THE COPYRIGHT HOLDERS.

PROJECT: NEW TWO STOREY DWELLING LOT 2, 169 MANLY STREET, PARAPARAUMU

CLIENT: M PRITCHARD

DETAILS SCALE AT A3: STATUS: AS SHOWN OCT 25 AMEND JS PROJECT NO: 3224

SILICONE SEAL TO TILE/WINDOW

WINDOW SUPPORT PACKER

LINE OF SHOWER CURTAIN, CURTAIN TO HANG I OOMM

BELOW SILL OF WINDOW EXPANDABLE FOAM AIRSEAL

OVER PEF ROD & PACKER

ARDEX STB TAPE DRESSED INTO WINDOW DRAINAGE CHANNEL & OVER INTERNAL EDGE OF WINDOW JAMBS ON 6mm JH VILLA


CERAMIC TILES ON WPM 155 LIQUID MEMBRANE WATERPROOFING

BOARD LAID TO 5° FALL TOWARDS TO SHOWER

JUNCTION

WITH 5° SLOPE



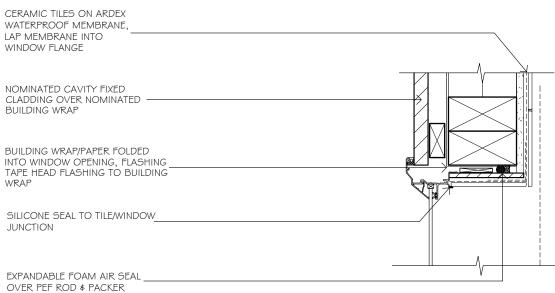

DETAIL 38B (D38B)

SILL FLASHING TO EXTEND BEHIND LINE OF ALUMINIUM

♯ FRAME BLOCK

FRAME WITH 8mm UPSTAND

ALUMINIUM WINDOW WITH

I Omm COVER TO CLADDING \$ SILL SUPPORT AS SUPPLIED

BY WINDOW MANUFACTURER

BUILDING WRAP FOLDED INTO

REFER SPECIFICATION

WINDOW OPENING & CONTINUOUS FLEXIBLE FLASHING TAPE TO SILL,


WINDOW JAMB DETAIL - WET AREA SHOWER SCALE 1:5

NOTE:

-WATERPROOF MEMBRANE TO CONTINUE FULL PERIMETER OF WINDOW -REFER SHADOWCLAD DETAIL KEY FOR WINDOW WEATHERTIGHT DETAILS


PERIMETER OF WINDOW -REFER SHADOWCLAD DETAIL KEY FOR WINDOW WEATHERTIGHT DETAILS CERAMIC TILES ON ARDEX WATERPROOF MEMBRANE, LAP MEMBRANE INTO

NOTES

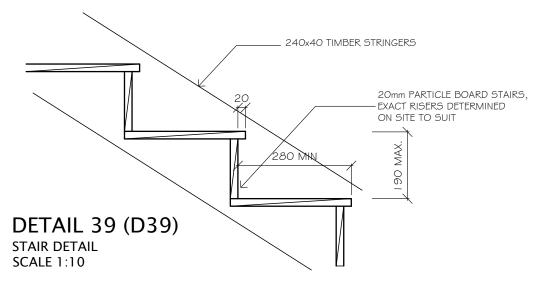


NOTE:


- -40mm Ø HANDRAIL 900mm ABOVE STAIR PITCH LINE, REFER DETAIL -ALL STAIR CONSTRUCTION & FINISH CONFIRMED WITH OWNER
- -280mm MINIMUM TREAD, 190mm MAXIMUM RISER

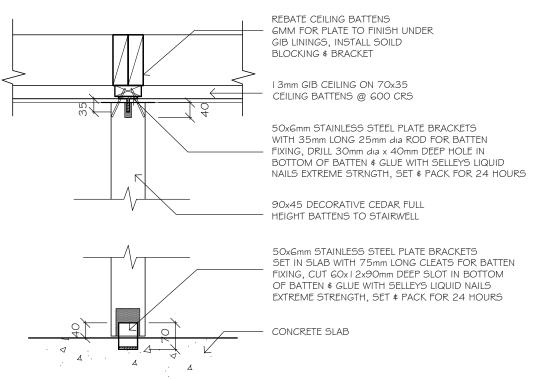

DETAIL 41 (D41) OPTIONAL CEDAR BATTEN DETAIL **SCALE 1:10**

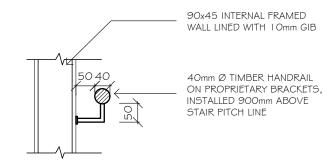

DETAIL 40 (D40) HANDRAIL DETAIL **SCALE 1:10**

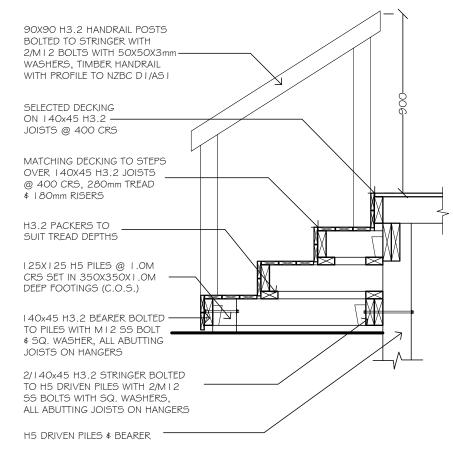

DETAIL 42 (D42) DECK STEPS DETAIL **SCALE 1:20**



NOTES

NOTES


- DO NOT SCALE FROM DRAWINGS
- CONTRACTORS TO VERIFY ALL MEASUREMENTS & LOCATION OF SERVICES ON SITE PRIOR
- CONTRACTORS TO VERIFY ALL MEASUREMENTS & LOCATION OF SERVICES ON SITE PRIOR
- COMMENCING WORK, CONTACT DRAFTED NZ FOR ANY CONTRADICTIONS OR ONSITE ANOMALIE
- PLANS ARE TO BE CROSS REFERENCED & READ IN CONCURRENCE WITH PROJECT SPECIFICATIONS,
- CONSULTANT REPORTS & SPECIALIST DOCUMENTATION
- ALL WORK TO BE CARRIED OUT IN ACCORDANCE WITH THE NEW ZEALAND BUILDING
- CODE, RELEVANT DISTRICT PLAN REQUIREMENTS & OR RESOURCE MANAGEMENT ACT
- THE COPYRIGHT OF THIS DRAWING IS VESTED IN DRAFTED NZ & IT MAY NOT BE
- REPRODUCED IN WHOLE OR PART OR USED FOR THE MANUPLACTURE OF ANY
- ARTICLE WITHOUT THE EXPRESS PERMISSION OF THE COPYRIGHT HOLDERS.

PROJECT:

NEW TWO STOREY DWELLING LOT 2, 169 MANLY STREET, PARAPARAUMU

CLIENT:	
M PRITCHARD	

DETAILS	}			
SCALE AT A3:	DATE:	DRAWN:	CHECKED:	STATUS:
AS SHOWN	OCT 25	JS	JS	AMEND
PROJECT NO:	REVISION:	DRAWING NO:		
3224		44		

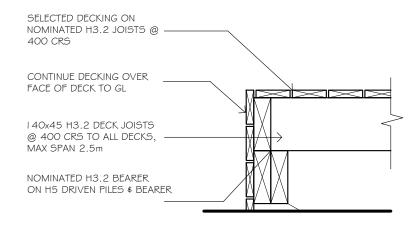


DETAIL 43 (D43) DECK EDGE DETAIL

SCALE 1:10

BGC STRATUM VERTICAL WEATHERBOARD DETAIL KEY

SCALE 1:50

-STRATUM MANUAL DETAIL REFERENCE-REFER SPECIFICATIONS FOR DETAILS -ALL DETAILS MUST BE READ IN CONJUNCTION WITH THE PREFACE OF THE TECHNICAL MANUAL & BRANZ APPRAISAL -ALL CLADDING FIXED IN ACCORDANCE WITH THE BRAD & GLUE METHOD				
CONSTRUCT FRAME	FIG I			
STRATUM VERTICAL INSTALLATION SLAB DETAIL	FIG 3			
STRATUM VERTICAL INSTALLATION PLANK JOINT DETAIL	FIG 5			
STRATUM VERTICAL INSTALLATION PLANK JOINT DETAIL	FIG 7			
STRATUM VERTICAL INSTALLATION FACE FIXING DETAIL	FIG 9			
STRATUM VERTICAL INSTALLATION EXTERNAL CORNER DETAIL	FIG			
STRATUM VERTICAL INSTALLATION INTERNAL CORNER DETAIL	FIG 13			
STRATUM VERTICAL INSTALLATION WINDOW HEAD DETAIL	FIG 15			
STRATUM VERTICAL INSTALLATION WINDOW SILL DETAIL	FIG 17			
STRATUM VERTICAL INSTALLATION WINDOW JAMB DETAIL	FIG 19			
INTERSTOREY DRAINAGE DETAIL CAVITY CONSTRUCTION	FIG SV-09			
STRATUM VERTICAL INSTALLATION PIPE PENETRATION DETAIL	FIG SV-25			

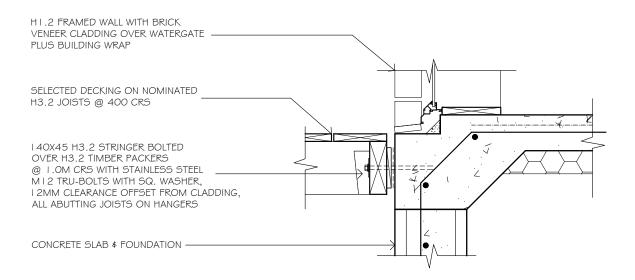

DETAIL 44 (D44) DECK STRINGER DETAIL SCALE 1:10

JAMES HARDIE VERTICAL STRIA DETAIL KEY **SCALE 1:50**

-JH STRIA-405mm WIDE CLADDING OVER H3. I 20mm CASTELLATED CAVITY BATTENS, REFER MANUAL FOR REFERENCE -REFER SPECIFICATIONS FOR DETAILS -ALL DETAILS MUST BE READ IN CONJUNCTION WITH THE PREFACE OF THE TECHNICAL MANUAL -ALL VERTICAL STRIA CLADDING TO COLUMNS \$ FASCIA TO BE 405mm \$ WHERE REQUIRED, MODIFIED TO ARCHITECTURAL DETAILS CAVITY FIXED TYPICAL FRAMING SETOUT FOUNDATION DETAILS FIGURE 3 - PAGE 25 CLADDING AND HARDIE HORIZONTAL BATTEN FIGURE 5 - PAGE 27 EXTERNAL ALUMINIUM BOX CORNER FIGURE 6 - PAGE 28 TRIMLINE JOINT FLASHING AT FLOOR LEVEL FIGURE 21 - PAGE 43 TRIMLINE JOINT EXTERNAL CORNER-OPTION A FIGURE 23 - PAGE 45 TRIMLINE JOINT EXTERNAL CORNER-OPTION B FIGURE 24 - PAGE 46 TRIMLINE FLASHING JOINT INTERNAL CORNER FIGURE 25 - PAGE 47 DRAINED FLASHING JOINT AT FLOOR JOIST FIGURE 27 - PAGE 49 EXTERNAL CORNER

NON-POTABLE WATER SIGNAGE:

OUTLETS OF NON-POTABLE WATER SHALL BE IDENTIFIED AS NOT SUITABLE FOR DRINKING BY USING THE PROHIBITION SAFETY SIGN SHOWN IN F8/AS I FIG 14, THE PICTOGRAM SHALL BE A MINIMUM OF 100 MM HIGH & LOCATED ADJACENT TO THE OUTLET IN A POSITION THAT WILL NOT BE OBSCURED WHEN THE OUTLET IS USED



NOTES

NOTES

- DO NOT SCALE FROM DRAWINGS

- CONTRACTORS TO VERIFY ALL MEASUREMENTS & LOCATION OF SERVICES ON SITE PRIOR

- CONTRACTORS TO VERIFY ALL MEASUREMENTS & LOCATION OF SERVICES ON SITE PRIOR

- COMMENCING WORK, COOTMACT DRAFTED NZ FOR ANY CONTRADICTIONS OR ONSITE ANOMALIE

- PLANS ARE TO BE CROSS REFERENCED & READ IN CONCURRENCE WITH PROJECT SPECIFICATIONS,

- CONSULTANT REPORTS & SPECIALIST DOCUMENTATION

- ALL WORK TO BE CARRIED OUT IN ACCORDANCE WITH THE NEW ZEALAND BUILDING

- CODE, RELEVANT DISTRICT PLAN REQUIREMENTS & OR RESOURCE MANAGEMENT ACT

- THE COPYRIGHT OF THIS DRAWING IS VESTED IN DRAFTED NZ & IT MAY NOT BE

- REPRODUCED IN WHOLE OR PART OR USED FOR THE MANUPLACTURE OF ANY

- ARTICLE WITHOUT THE EXPRESS PERMISSION OF THE COPYRIGHT HOLDERS.

PROJECT: NEW TWO STOREY DWELLING LOT 2, 169 MANLY STREET, PARAPARAUMU

CLIENT: M PRITCHARD	DETAILS					
	SCALE AT A3:	DATE:	DRAWN:	CHECKED:	STATUS:	
	AS SHOWN	OCT 25	JS	JS	AMEND	
	PROJECT NO:	REVISION:	DRAWING NO:			
	3224		45			