

STATEMENT OF PASSING OVER INFORMATION


This information has been supplied by the vendor or the vendor's agents. Accordingly, Ownly (REAA 2008) and Sold On Kapiti Limited is merely passing over the information as supplied to us by the vendor of the vendor's agents.

We cannot guarantee its accuracy and reliability as we have not checked, audited, or reviewed the information and all the intending purchasers are advised to conduct their own due diligence investigation into the same.

To the maximum extent permitted by law Ownly (REAA 2008) and Sold On Kapiti Limited does not accept any responsibility to any person for the accuracy of the information herein.



SOLD ON KĀPITI
real estate

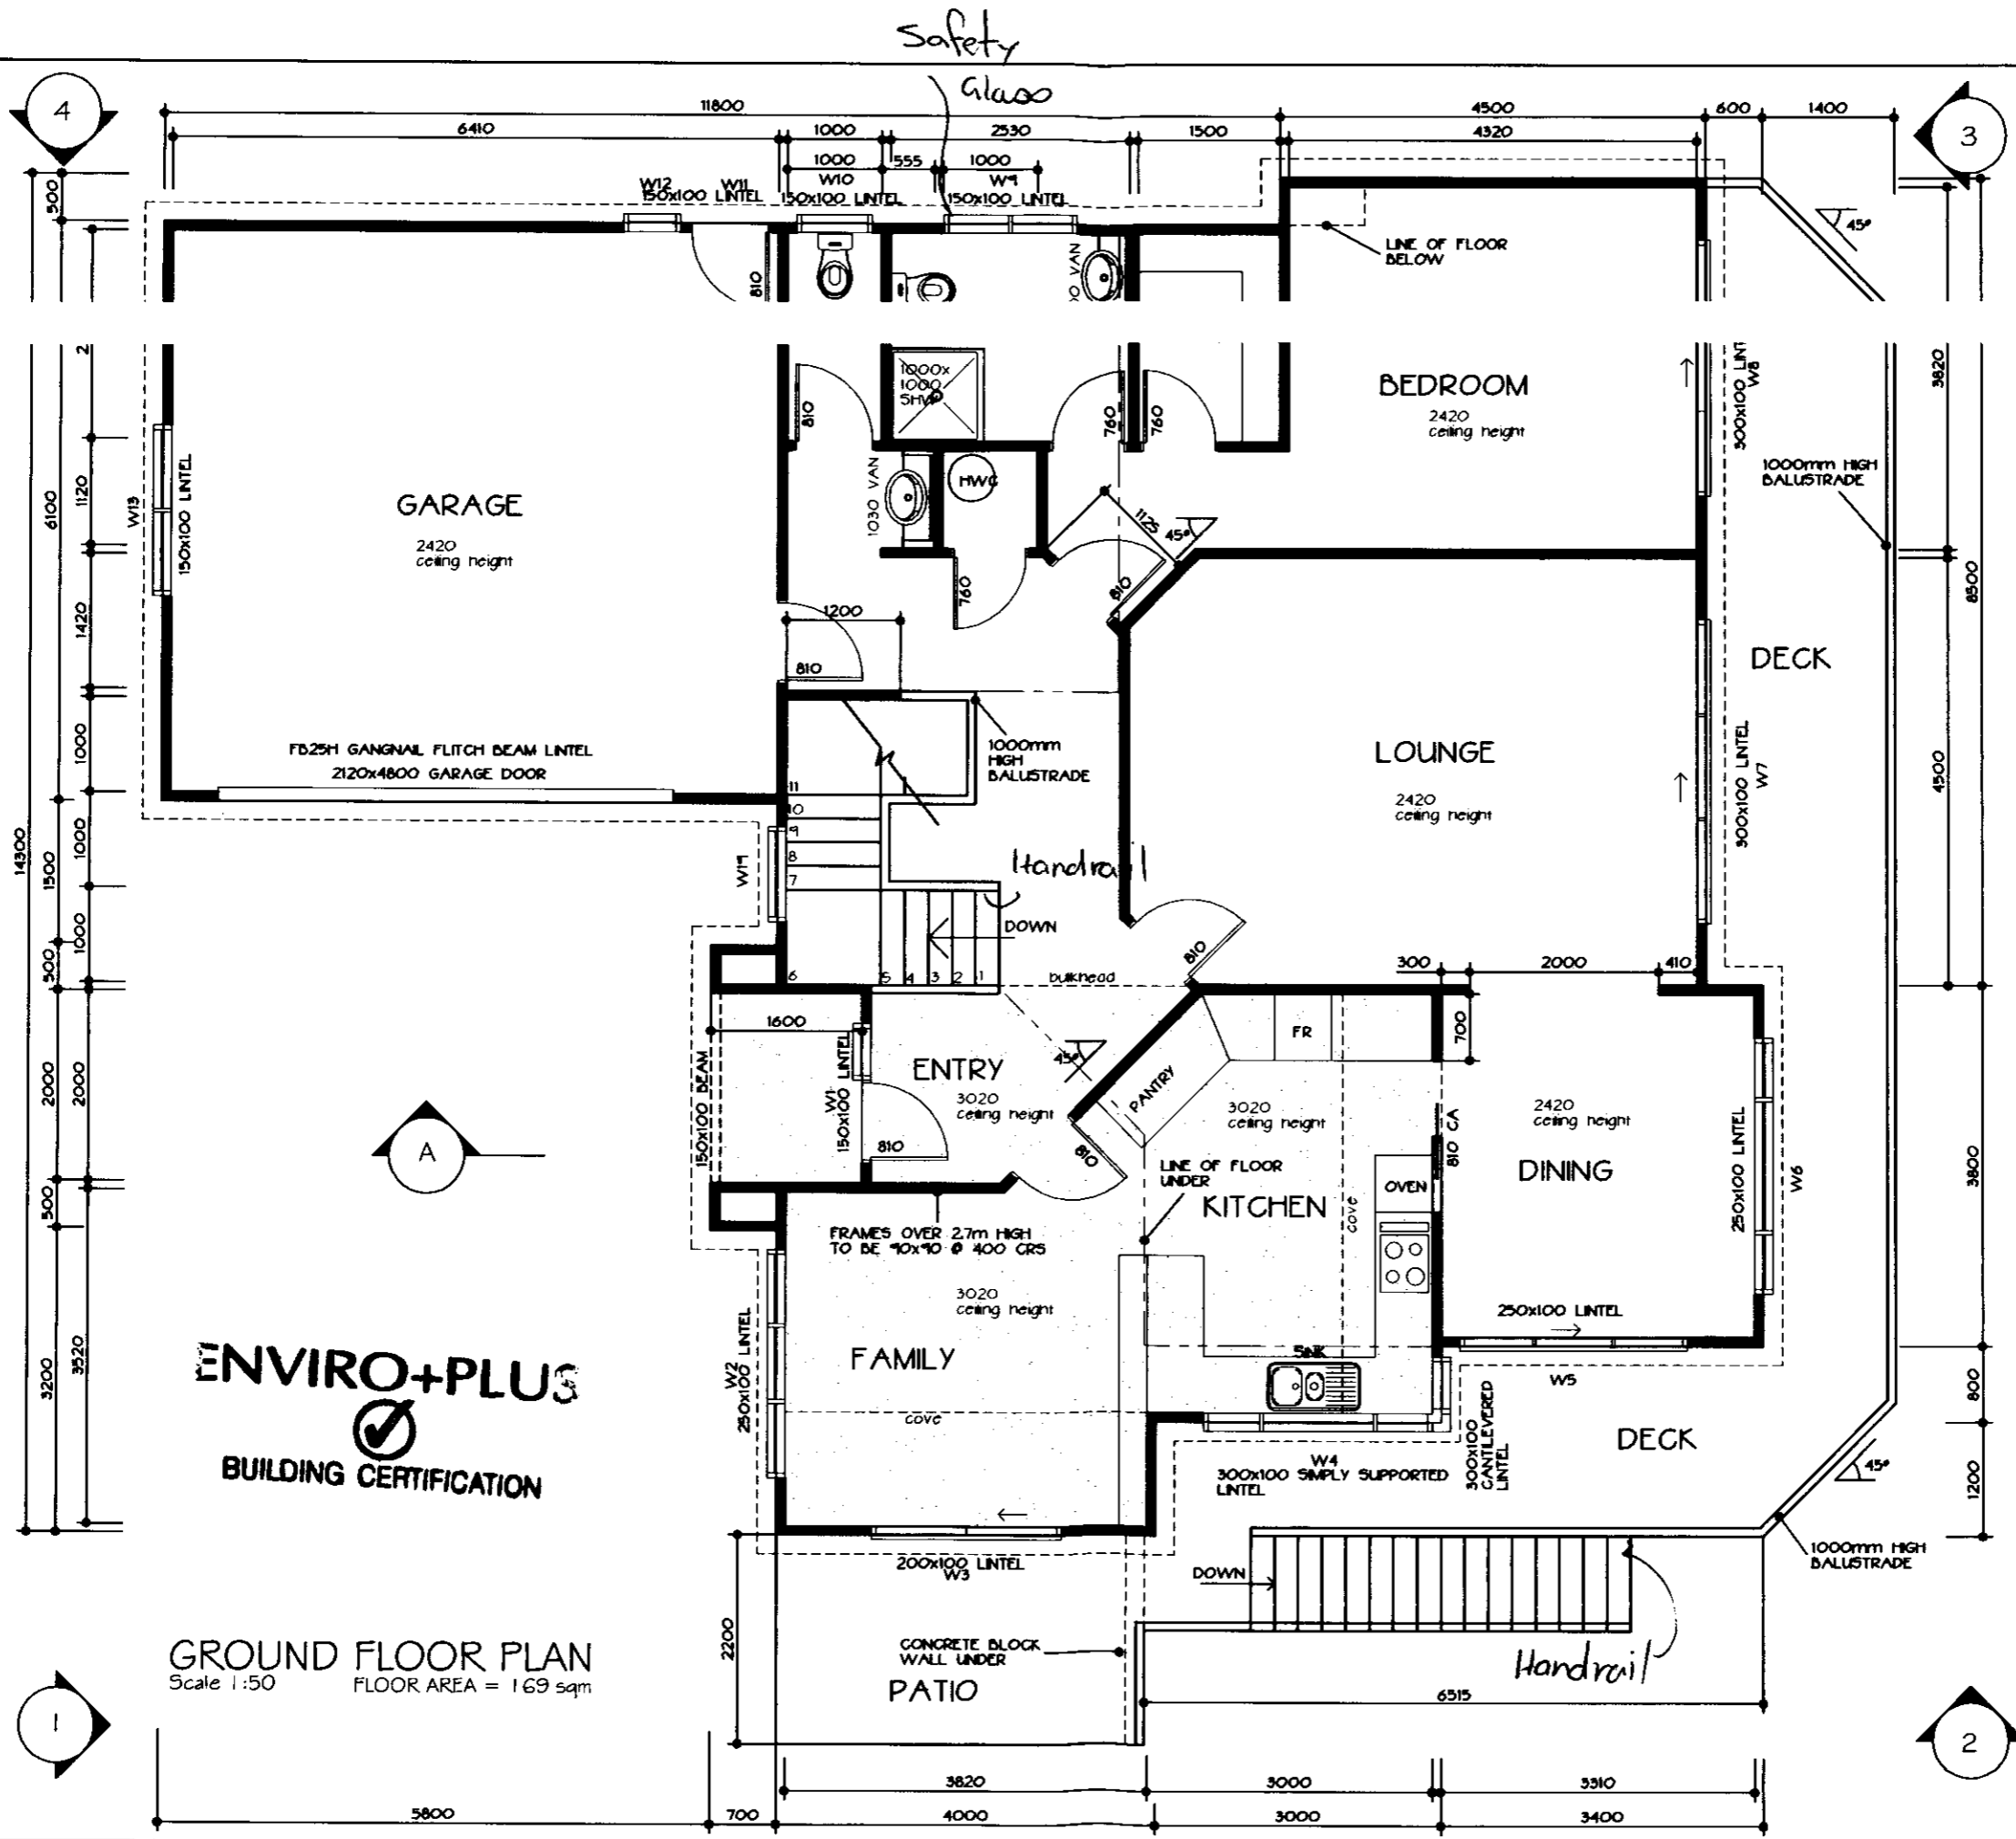

ENVIRO+PLUS

BUILDING CERTIFICATION

GROUND FLOOR PLAN
 Scale 1:50 FLOOR AREA = 169 sqm

MS
AE

PROJECT: **PROPOSED RESIDENCE FOR J A
 LOT 8 KAKARIKI GROVE, WAIK**

Design Network Kapiti

REVISIONS:

301 Kapiti Road
 PO Box 1616
 Paraparaumu Beach
 New Zealand
 Tel: 04 902 5505
 Fax: 04 902 5504
 Email: kapiti@desnet.co.nz

CONTRACTOR TO VERIFY ALL DIMENSIONS
 ON SITE PRIOR TO COMMENCING WORK.
 DO NOT SCALE DRAWINGS.
 THESE DRAWINGS ARE COPYRIGHT.
 DRAWINGS TO BE READ IN CONJUNCTION
 WITH STRUCTURAL ENGINEERS
 DRAWINGS.


DATE:	OCTOBER 2000
DESIGNED:	M STEVENS
DRAWN:	R.G & B.F
CAD REF:	2059
SCALE:	AS SHOWN

JOB/SHEET No:
2059/2
 (A2 original) OF 8

ENVIRO+PLUS

 BUILDING CERTIFICATION

BASEMENT FLOOR PLAN
 Scale 1:50
 FLOOR AREA = 89 sqm

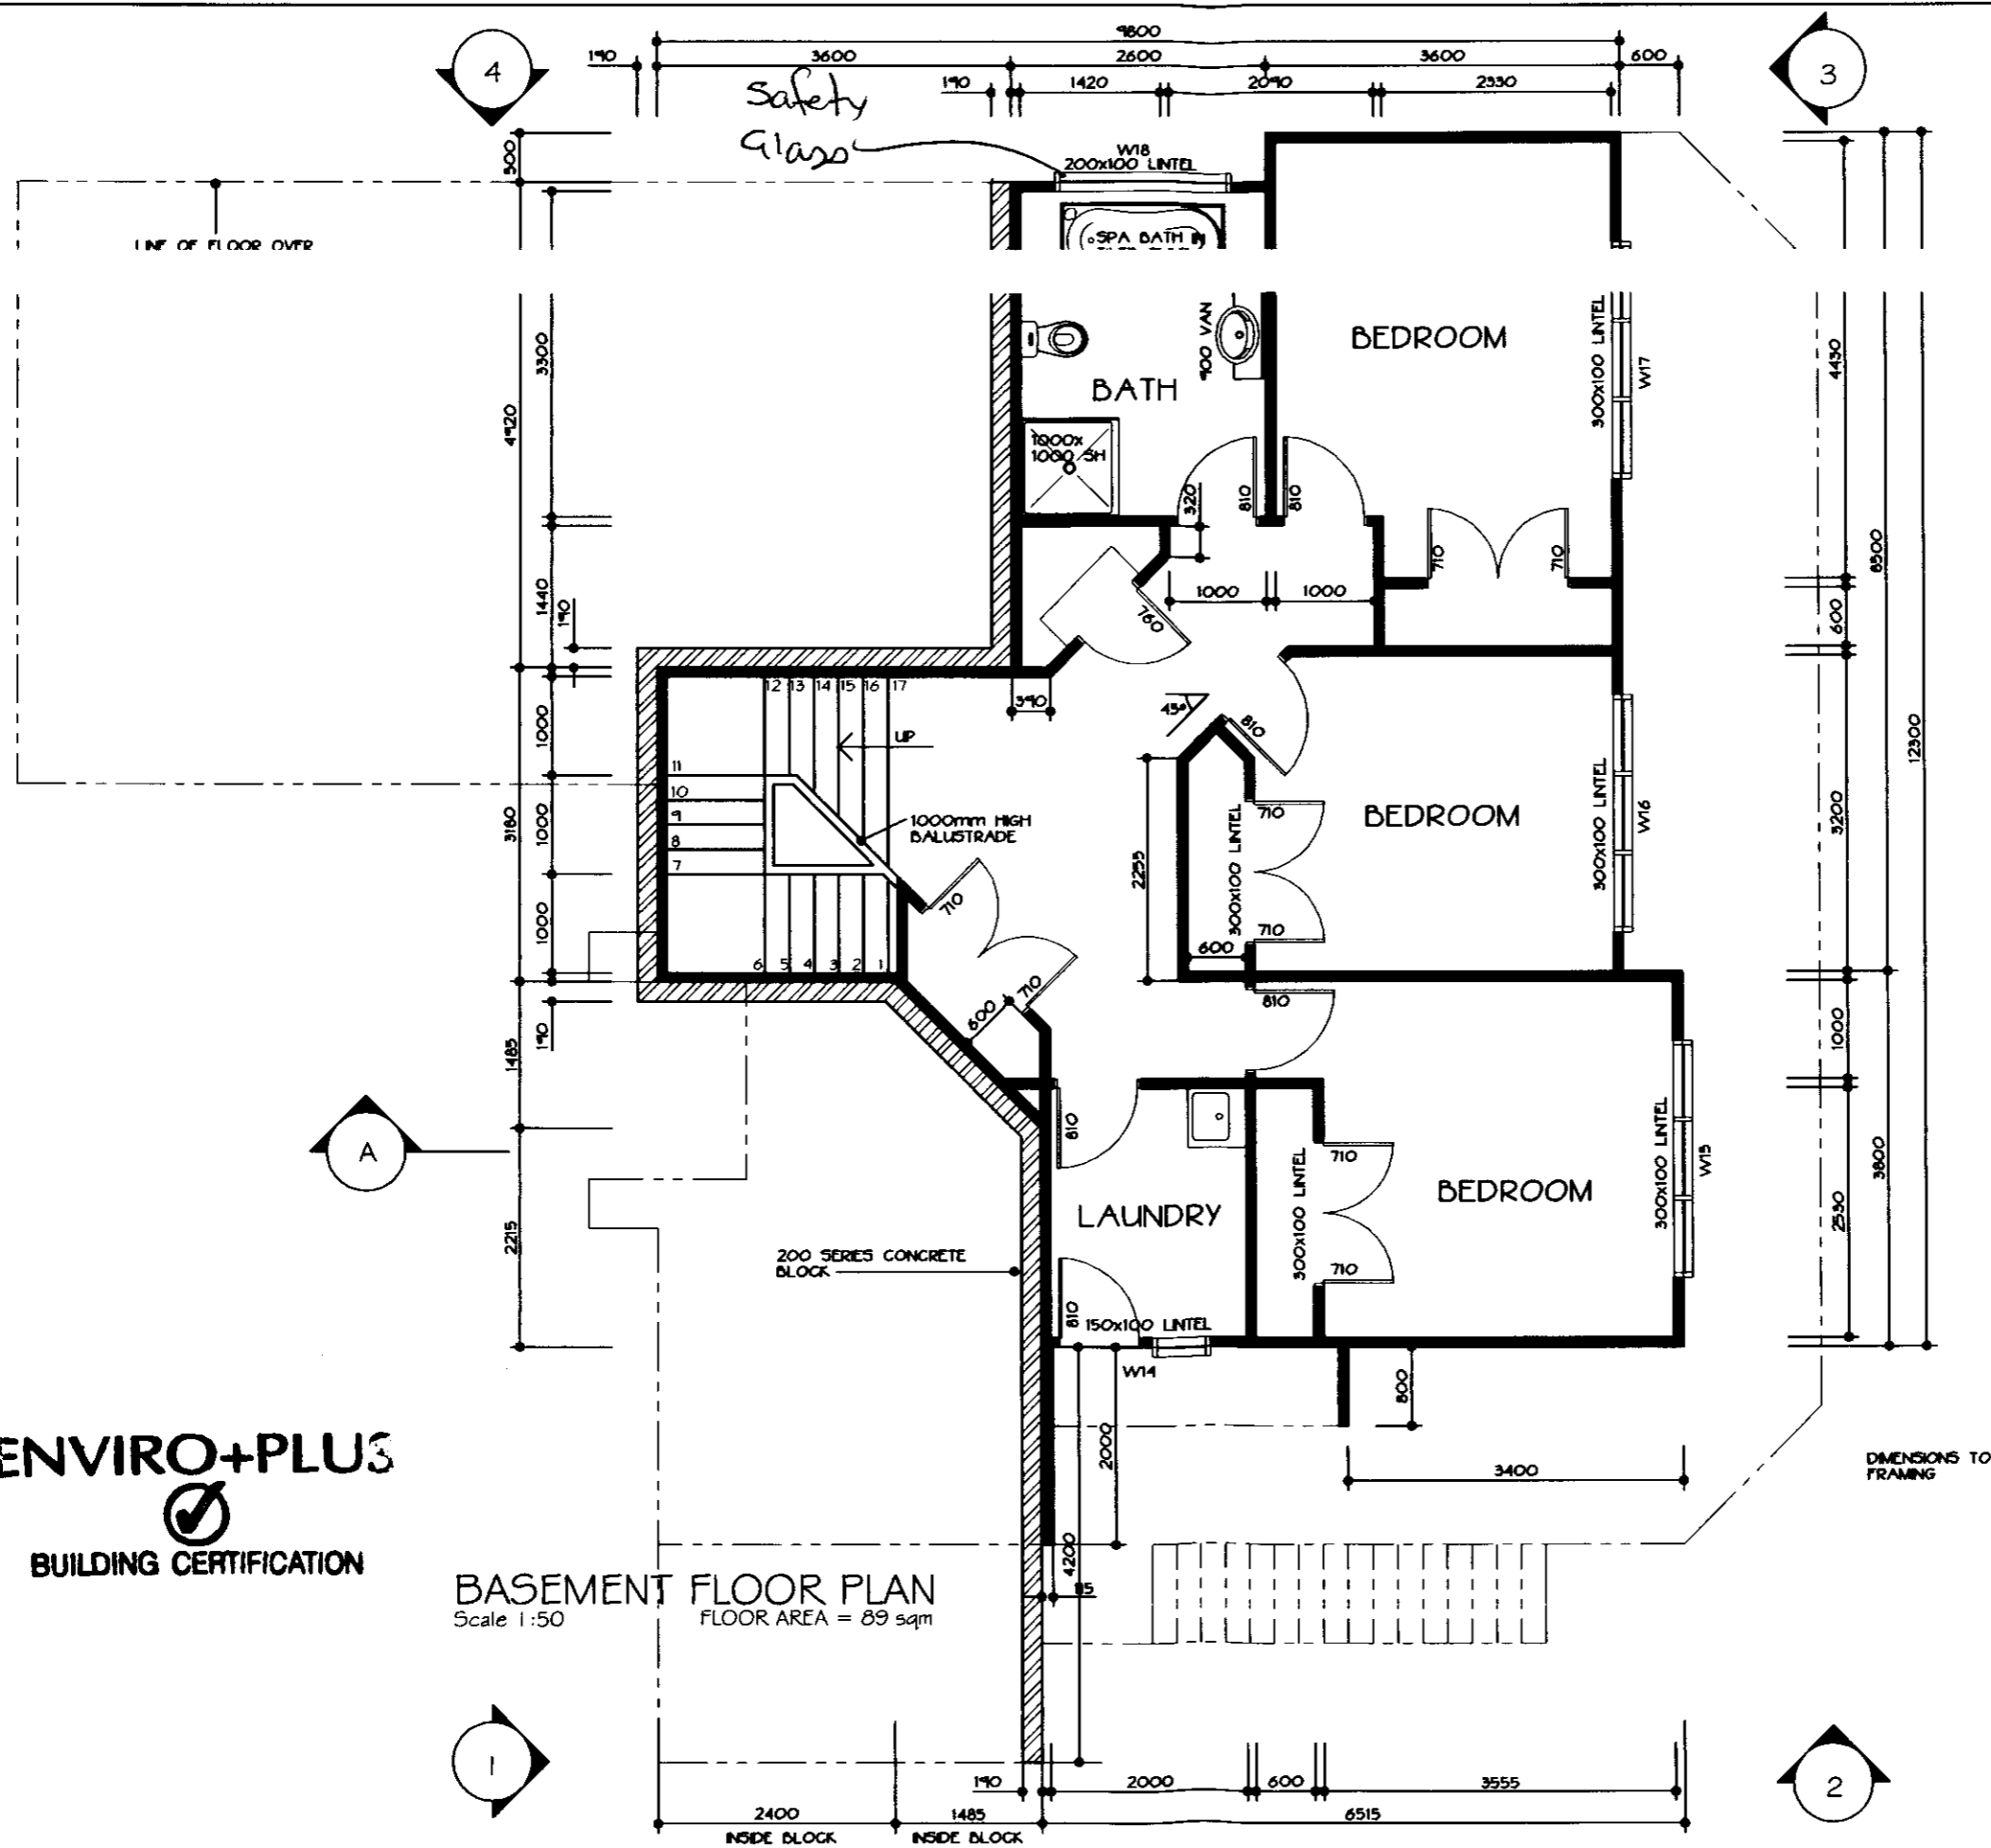

MS
 AE

PROJECT: **PROPOSED RESIDENCE FOR J A
 LOT 8 KAKARIKI GROVE, WAIKI**

DesignNetwork Kapiti

REVISIONS:

301 Kapiti Road
 PO Box 1616
 Paraparaumu Beach
 New Zealand
 Tel: 04 902 5505
 Fax: 04 902 5504
 Email: kapiti@desnet.co.nz

CONTRACTOR TO VERIFY ALL DIMENSIONS
 ON SITE PRIOR TO COMMENCING WORK.
 DO NOT SCALE DRAWINGS.
 THESE DRAWINGS ARE COPYRIGHT.
 DRAWINGS TO BE READ IN CONJUNCTION
 WITH STRUCTURAL ENGINEERS
 DRAWINGS

DATE:	OCTOBER 2000
DESIGNED:	M STEVENS
DRAWN:	R.G & B.F
CAD REF:	2059
SCALE:	AS SHOWN

JOB/SHEET No:

2059/3

(A2 original) OF 8